

REVIEW BY FORT BEND COUNTY COMMISSIONERS COURT

14K Fort Bend County Engineering Department

Engineering Department
301 Jackson Suite 401
Richmond, Texas 77469
281.633.7500
Permits@fortbendcountytx.gov

William B	Right of Way	y Permit							
	X Commercial D	Driveway Permit							
	Permit No: 2018-24190								
Appli	cant: United Constructors of Texas, Inc/RSG	Engineering							
Job Location Site: 11135 Harlem Road, Richmond , TX 77406									
Bond No Date of Bond:11/5/2018									
The above applicant came to make use of certain Fort Bend County property subject to, "The Order Regulating the Laying, Construction, Maintenance, and Repair of Buried Cables, Conduits, and Pole Lines, In, Under, Across or Along Roads, Streets, Highways, and Drainage Ditches in Fort Bend County, Texas, Under the Jurisdiction of the Commissioners Court of Fort Bend County, Texas," as passed by the Commissioners Court of Fort Bend County, Texas, of the Minutes of the Commissioners Court of Fort Bend County, Texas, to the extent that such order is not inconsistant with Chapter 181, Vernon's Texas Statutes and Codes Annoted.									
Notes 1. 2. 3. 4.	grounds for job shutdown. 2. Written notices are required: a. 48 hours in advance of construction start up, and b. When construction is completed and ready for final inspection, submit notification to Permit Administrator thru MyGovernmentOnline.org portal. 3. This permit expires one (1) year from date of permit if construction has not commenced.								
On this day of , , Upon Motion of Commissioner									
Signa By:	County Engineer	Presented to Commissioners Court and approved. Date Recorded 11-16-2 Comm. Court No. 14-K							
Ву:	N/A Drainage District Engineer/Manager	Clerk of Commissioners Court By: Deputy							



PERMIT APPLICATION REVIEW FORM FOR CABLE, CONDUIT, AND POLE LINE ACTIVITY IN FORT BEND COUNTY

Fort Bend County

Engineering Department
301 Jackson Suite 401
Richmond, Texas 77469
281.633.7500 Permits@fortbendcountytx.gov

Rig	ht of Way Permit		
X Co.	mmercial Driveway F	Permit	
	o: 2018-24190		
The following "Notice of Proposed Cable, Conattachments have been reviewed and the not of Fort Bend County, Texas.			
(1) COMPLETE APPLICATION FORM:			
X a. Name of road, street, and/o	or drainage ditch affec	eted.	
χ b. Vicinity map showing course	e of directions		
X c. Plans and specifications			
(2) BOND:			
County Attorney, approval who applicable.	en		
Perpetual bond currently posted.	Bond No:	Amount:	
X Performance bond submitted.	Bond No:	Amount: \$10,000.00	
Cashier's Check	Check No:	Amount:	
(3) DRAINAGE DISTRICT APPROVAL (WH	EN APPLICABLE):		
Drainage District Approval	_	Date	
We have reviewed this project and agree it	meets minimum req	uirements.	
Lan Eghten		11/5/2018	J
Permit Administrator		Date	



Insurors Indemnity Company

PERFORMANCE BOND COVERING ALL CABLE, CONDUIT AND/OR POLE LINE ACTIVITY IN, UNDER, ACROSS OR ALONG FORT BEND COUNTY ROAD

AUTHORIZED
BOND NO_
THE STATE OF TEXAS §
KNOW ALL MEN BY THESE PRESENTS:
COUNTY OF FORT BEND §
who
THAT WE, United Constructors of Texas, Inc. who address is 6989 W Little York Suite F. Houston, TX 77040 Texas, hereinafter called the Principa
Water to a Oydy III. Elittle Total Carte I (120 astern 121)
principal office is located at 225 South 5th Street, Waco, TX 76701, whose officer residi in the State of Texas, authorized to accept service in all suits and actions brought whining said state is Insurors Indemnity Co and accept service in all suits and actions brought whining said state is Insurors Indemnity Co and accept service in all suits and actions brought whining said state is Insurors Indemnity Co and accept service in all suits and actions brought whining said state is Insurors Indemnity Co and accept service in all suits and actions brought whining said state is Insurors Indemnity Co and Insurors Index Insurors Insurors Index Insurors Index Insurors Index Insurors Index Insurors Insurors
Whose address is 225 South 5th Street West TV 76701 hereinafter called the Surety and held a
Whose address is 225 South 5th Street, Waco, TX 76701, hereinafter called the Surety, and held a firmly bound unto, Robert e. Hebert, County Judge of Fort Bend County, Texas, or his successors in office, in the full surely sur
of Five Thousand Dollars and Zero Cents Dollars (\$5,000.00) current, lawful money of the United Stated
America, to be paid to said Robert E. Hebert, County Judge of Fort Bend County, Texas, or his successors in office,
which payment well and truly to be made and done, we, the undersigned, bind ourselves and each of us, our hei
executors, administrators, successors, assigns, and legal representatives, jointly and severally, by these presents.
7, 7, 7, 7, 7, 7, 7, 7, 7, 7, 7, 7, 7, 7
THE CONDITION OF THIS BOND IS SUCH THAT, WHEREAS, the above bounden principal contemplate
laying, constructing, maintaining and/or repairing one or more cables, conduits, and/or pole lines in, under, across a
along roads, streets and highways, commercial driveway and median openings or modifications in the County of Fo
Bend, and the State of Texas, under the jurisdiction of the Commissioners' Court of Fort Bend County, Texas, pursuant
the Commissioners' Court order adopted on the 1st day of December, A.D. 1980, recorded in Volume 13, of t
Commissioners' Court Minutes of Fort Bend County, Texas, regulating same, which Commissioners' Court order is here
referred to and made a part hereof for all purposes as though fully set out herein;
AND WHEREAS, the principal desires to provide Fort Bend County with a performance bond covering all su
cable, conduit and/or pole line activity, commercial driveway and median openings or modifications;
NOW, THEREFORE, if the above bounden principal shall faithfully perform all its cable, conduit and/or pole li
activity (including, but not limited to the laying, construction, maintenance and/or repair of cables, conduits and/or po
lines) in, under, across and/or along roads, streets and highways, commercial driveway and median openings
modifications in the County of Fort Bend and State of Texas, under the jurisdiction of the Commissioners Court of Fo
Bend County, Texas, pursuant to and in accordance with minimum requirements and conditions of the above mention
Commissioners' Court order set forth and specified to be by said principal done and performed, at the time and in t
manner therein specified, and shall pay over and make good and reimburse Fort Bend County, all loss and damages whi
Fort Bend County may sustain by reason of any failure or default on the part of said principal, then this obligation shall
null and void, otherwise to remain in full force and effect.
This bond is payable at the County Courthouse in the County of Fort Bend and State of Texas.
It is understood that at any time Fort Bend County deems itself insecure under this bond, it may require furth and/or additional bonds of the principal.
and/or additional bonds of the principals
EXECUTED this 21st day of September, 20 2018.
II in 10. Comment to
United Constructors of Texas, Inc
PRINCIPAL
Han fey (Gines de
BY

CCM 11-13-2018 #14K
Fort Bend County Clerk
Return Admin Sery Coord
Recmit # 2018-24190 RAC

Permit # 2019 24140

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POWER OF ATTORNEY of INSURORS INDEMNITY COMPANY Waco, Texas

KNOW ALL PERSONS BY THESE PRESENTS:	Number:
That INSURORS INDEMNITY COMPANY, Waco,	, Texas, organized and existing under the laws of the State of

Texas, and authorized and licensed to do business in the State of Texas and the United States of America, does hereby make, constitute and appoint Andrea M. Penaloza of the City of Houston, State of TX as Attorney in Fact, with full power and authority hereby conferred upon him to sign, execute, acknowledge and

deliver for and on its behalf as Surety and as its act and deed, all of the following classes of document, to-wit:

Indemnity, Surety and Undertakings that may be desired by contract, or may be given in any action or proceeding in any court of law or equity; Indemnity in all cases where indemnity may be lawfully given and with full power and authority to execute consents and waivers to modify or change or extend any bond or document executed for this Company.

INSURORS INDEMNITY COMPANY

Comm. Exp. 5/21/21

Number:

Tammy Tieperman, Secretary

Dave E. Talbert, President

State of Texas County of McLennan

On the 11th day of November, 2014, before me a Notary Public in the State of Texas, personally appeared Dave E. Talbert and Tammy Tieperman, who being by me duly swom, acknowledged that they executed the above Power of Attorney in their capacities as President, and Corporate Secretary, respectively, of Insurors Indemnity Company, and acknowledged said Power of Attorney to be the voluntary act and deed of the Company.

Notary Public, State of Texas

Insurors Indemnity Company certifies that this Power of Attorney is granted under and by authority of the following resolutions of the Company adopted by the Board of Directors on November 11, 2014:

RESOLVED, that all bonds, undertakings, contracts or other obligations may be executed in the name of the Company by persons appointed as Attorney in Fact pursuant to a Power of Attorney issued in accordance with these Resolutions. Said Power of Attorney shall be executed in the name and on behalf of the Company either by the Chairman and CEO or the President, under their respective designation. The signature of such officer and the seal of the Company may be affixed by facsimile to any Power of Attorney, and, unless subsequently revoked and subject to any limitation set forth therein, any such Power of Attorney or certificate bearing such facsimile signature and seal shall be valid and binding upon the Company and any such power so executed and certified by facsimile signature and seal shall be valid and binding upon the Company with respect to any bond or undertaking to which it is validly attached.

RESOLVED, that Attorneys in Fact shall have the power and authority, subject to the terms and limitations of the Power of Attorney issued to them, to execute and deliver on behalf of the Company and to attach the seal of the Company to any and all bonds and undertakings, and any such instrument executed by such Attorneys in Fact shall be binding upon the Company as if signed by an Executive Officer and sealed and attested to by the Secretary or Assistant Secretary of the Company.

I, Tammy Tieperman, Secretary of Insurors Indemnity Company, do hereby certify that the foregoing is a true excerpt from the Resolutions of the said Company as adopted by its Board of Directors on November 11, 2014, and that this Resolution is in full force and effect. I certify that the foregoing Power of Attorney is in full force and effect and has not been revoked.

In Witness Whereof, I have set my hand and the seal of INSURORS INDEMNITY COMPANY on this September

Tammy Tieperman, Secretar

NOTE: IF YOU HAVE ANY QUESTION REGARDING THE VALIDITY OR WORDING OF THIS POWER OF ATTORNEY, PLEASE CALL 800 933 7444 OR WRITE TO US AT P. O. BOX 2683, WACO, TEXAS 76702-2683 OR EMAIL US AT PT AT A NO DERN DRY. W CONFIRMATION@INSURORS.COM.



P&C

877 282 1625 Bonds 800 933 7444

225 South Fifth Street PO Box 2683 Waco, Texas 76702-2683

IMPORTANT NOTICE - AVISO IMPORTANTE

To obtain information or make a complaint:

You may call Insurors Indemnity Company's toll-free telephone number for information or to make a complaint at:

1-800-933-7444

You may also write to Insurors Indemnity Company at:

P.O. Box 2683 Waco, TX 76702-2683 Or 225 South Fifth Street Waco, TX 76701

You may contact the Texas Department of Insurance to obtain information on companies, coverages, rights or complaints at

1-800-252-3439

You may write the Texas Department of Insurance at:

Consumer Protection (111-1A) P.O. Box 149091 Austin, TX 78714-9091 Fax: 512-490-1007

Web: http://www.tdi.texas.gov

E-mail: ConsumerProtection@tdi.texas.gov

PREMIUM OR CLAIM DISPUTES:

Should you have a dispute concerning your premium or about a claim, you should contact the agent or the company first. If the dispute is not resolved, you may contact the Texas Department of Insurance.

ATTACH THIS NOTICE TO YOUR POLICY:

This notice is for information only and does not become a part or condition of the attached document.

Para obtener informacion o para someter una queja:

Usted puede llamar al numero de telefono gratis de Insurors Indemnity Company's para informacion o para someter una queja al

1-800-933-7444

Usted tanbien puede escribir a Insurors Indemnity Company:

> P.O. Box 2683 Waco, TX 76702-2683 0 225 South Fifth Street Waco, TX 76701

Puede comunicarse con el Departamento de Seguros de Texas para obtener informacion acerca de companias, coberturas, derechos o quejas al

1-800-252-3439

Puede escribir al Departamento de Seguros de Texas:

Consumer Protection (111-1A) P.O. Box 149091 Austin, TX 78714-9091 Fax: 512-490-1007

Web: http://www.tdi.texas.gov

E-mail: ConsumerProtection@tdi.texas.gov

DISPUTAS SOBRE PRIMAS O RECLAMOS:

Si tiene una disputa concemiente a su prima o a un reclamo, debe comunicarse con el agente o la compania primero. Si no se resuelve la disputa, puede entonces comunicarse con el departamento (TDI).

UNA ESTE AVISO A SU POLIZA:

Este aviso es solo para proposito de informacion y no se convierte en parte o condicion del documento adjunto.



P&C 877 282 1625 Bonds 800 933 7444 225 South Fifth Street PO Box 2683 Waco, Texas 76702-2683

RIDER

It is hereby agreed and understood that Insurors Indemnity Company gives consent to revise the information contained in the original bond as follows:

contained in the original	bond as follows:
Name of Principal: dba	United Constructors of Texas, Inc
Address of Principal:	6989 W. Little York, Suite F, Houston, TX 77040
Bond Effective Date:	09/21/2018
Bond Expiration Date:	09/21/2019
Penalty Amount:	Ten Thousand Dollars and Zero Cents (\$10,000.00)
Notes:	i to: Ten Thousand Dollars (\$10,000.00)
Penalty has been amended	to. Tell Thousand Donars (\$10,000.00)
Nothing herein contained	d shall be held to vary, alter, waive or extend any of the terms, limits or conditions of
theCab	les, Conduits & Poles , except as hereinabove set forth.
This rider becomes effec	tive on, at twelve and one minute o'clock a.m.,
Standard Time.	tive on, at twelve and one initiate a clock u.i.i.,
Attached to and forming	part of Bond Number dated09/21/2018
issued by Insurors Indem	nnity Company of Waco, Texas, to United Constructors of Texas, Inc
C'	av of November , 2018 .
Signed this 5th da	ay of <u>November</u> , <u>2018</u> .
	Insurors Indemnity Company
	MANY MANY
	By: andram. Revelop
	Andrea M. Penaloza, Attorney-in-Fact
	3 3 3 7
	The annual trees.



POWER OF ATTORNEY of INSURORS INDEMNITY COMPANY Waco, Texas

KNOW ALL PERSONS BY THESE PRESENTS:	Number:
That INSURORS INDEMNITY COMPANY, Waco, Texas, organized and licensed to do business in the State hereby make, constitute and appoint Andrea M. Penaloza of the City of the Ci	e of Texas and the United States of America, does
as Attorney in Fact, with full power and authority hereby confideliver for and on its behalf as Surety and as its act and deed, a	erred upon him to sign, execute, acknowledge and all of the following classes of document, to-wit:
Indemnity, Surety and Undertakings that may be desire or proceeding in any court of law or equity; Indemnity in given and with full power and authority to execute con extend any bond or document executed for this Compan	n all cases where indemnity may be lawfully nsents and waivers to modify or change or
	INSURORS INDEMNITY COMPANY
Attest:	By: Dave E. Talbert, President
State of Texas County of McLennan	
On the 11th day of November, 2014, before me a Notary Po Talbert and Tammy Tieperman, who being by me duly sworn, acknow their capacities as President, and Corporate Secretary, respectively, Power of Attorney to be the voluntary act and deed of the Company.	ledged that they executed the above Power of Attorney in of Insurors Indemnity Company, and acknowledged said Sheril Carnes Nothing Public, State of Texas My Comm. Exp. 5/21/21
Insurors Indemnity Company certifies that this Power of following resolutions of the Company adopted by the Board of D	of Attorney is granted under and by authority of the Directors on November 11, 2014:
RESOLVED, that all bonds, undertakings, contracts or other by persons appointed as Attorney in Fact pursuant to a Power of Attorney shall be executed in the name and on behalf of President, under their respective designation. The signature of such facsimile to any Power of Attorney, and, unless subsequently revoked Power of Attorney or certificate bearing such facsimile signature and such power so executed and certified by facsimile signature and seal to any bond or undertaking to which it is validly attached.	orney issued in accordance with these Resolutions. Said the Company either by the Chairman and CEO or the officer and the seal of the Company may be affixed by d and subject to any limitation set forth therein, any such eal shall be valid and binding upon the Company and any
RESOLVED, that Attorneys in Fact shall have the power at Power of Attorney issued to them, to execute and deliver on behalf of any and all bonds and undertakings, and any such instrument execution company as if signed by an Executive Officer and sealed and atterpression.	f the Company and to attach the seal of the Company to ted by such Attorneys in Fact shall be binding upon the ested to by the Secretary or Assistant Secretary of the
I, Tammy Tieperman, Secretary of Insurors Indemnity Comp. from the Resolutions of the said Company as adopted by its Board of is in full force and effect. I certify that the foregoing Power of Attorney is	Directors on November 11, 2014, and that this Resolution
day of November 2018	RORS INDEMNITY COMPANY on this5th

NOTE: IF YOU HAVE ANY QUESTION REGARDING THE VALIDITY OR WORDING OF THIS POWER OF ATTORNEY, PLEASE CALL 800 933 7444 OR WRITE TO US AT P. O. BOX 2683, WACO, TEXAS 76702-2683 OR EMAIL US AT CONFIRMATION@INSURORS.COM.

Tammy Tieperman, Secretary

FILED AND RECORDED OFFICIAL PUBLIC RECORDS

Laura Richard, County Clerk Fort Bend County Texas November 16, 2018 02:02:28 PM

FEE: \$0.00

EW

2018128456

PROPOSED PAVING, UTILITIES, DRAINAGE, AND GRADING CONSTRUCTION PLANS


TO SERVE

COMMONS AT HARVEST GREEN

AT

11131 AND 11135 HARLEM ROAD HOUSTON, TEXAS 77406

APRIL, 2018

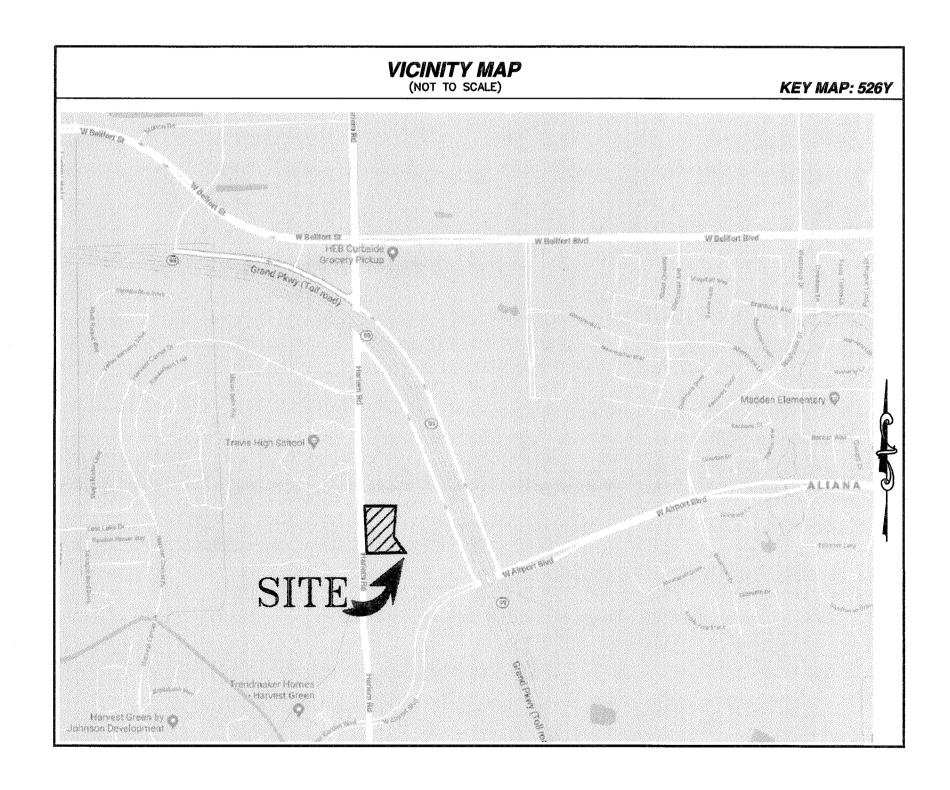

No example of	
INDEX OF DRAWINGS	SHEET
COVER SHEET	C1.0
TOPOGRAPHIC MAP	C2.0
SITE PLAN	C3.1
DRAINAGE AREA MAP	C4.0
DRAINAGE CALCULATIONS	C4.1
SITE DRAINAGE PLAN	C4.2
SITE GRADING PLAN	C4.3
SITE PAVING PLAN	C4.4
STORM WATER POLLUTION PREVENTION PLAN	C5.1
STORM WATER POLLUTION PREVENTION DETAILS	C5.2
SITE UTILITIES PLAN	C6.1
GENERAL NOTES	C7.1
CONSTRUCTION DETAILS	C7.2
CONSTRUCTION DETAILS	C7.3
TRAFFIC CONTROL PLAN	C8.0
TRAFFIC CONTROL PLAN	C8.1
LEFT TURN LANE PLAN	C9.1

FORT BEND COUNTY ENGINEER


ENGINEER: Pick Stargle, PE, PTOE 10/19/18


FOR RICHARD W. STOLLEIS. P.E.

THESE SIGNATURES ARE VOID IF
CONSTRUCTION HAS NOT BEEN COMMENCED
IN (1) YEAR FROM DATE OF APPROVAL.

APPROVED: DEVELOPMENT SERVICES MANAGER

DATE: 10/18/18

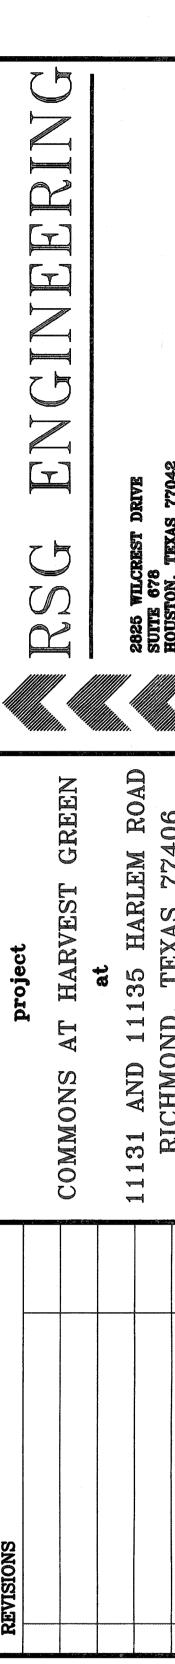


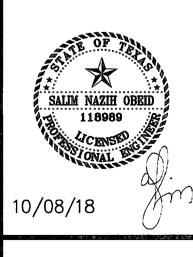



COVER SHEET

DRAWN BY: CHECKED:

PROJECT No SHEET No:
1877.01 C1.0

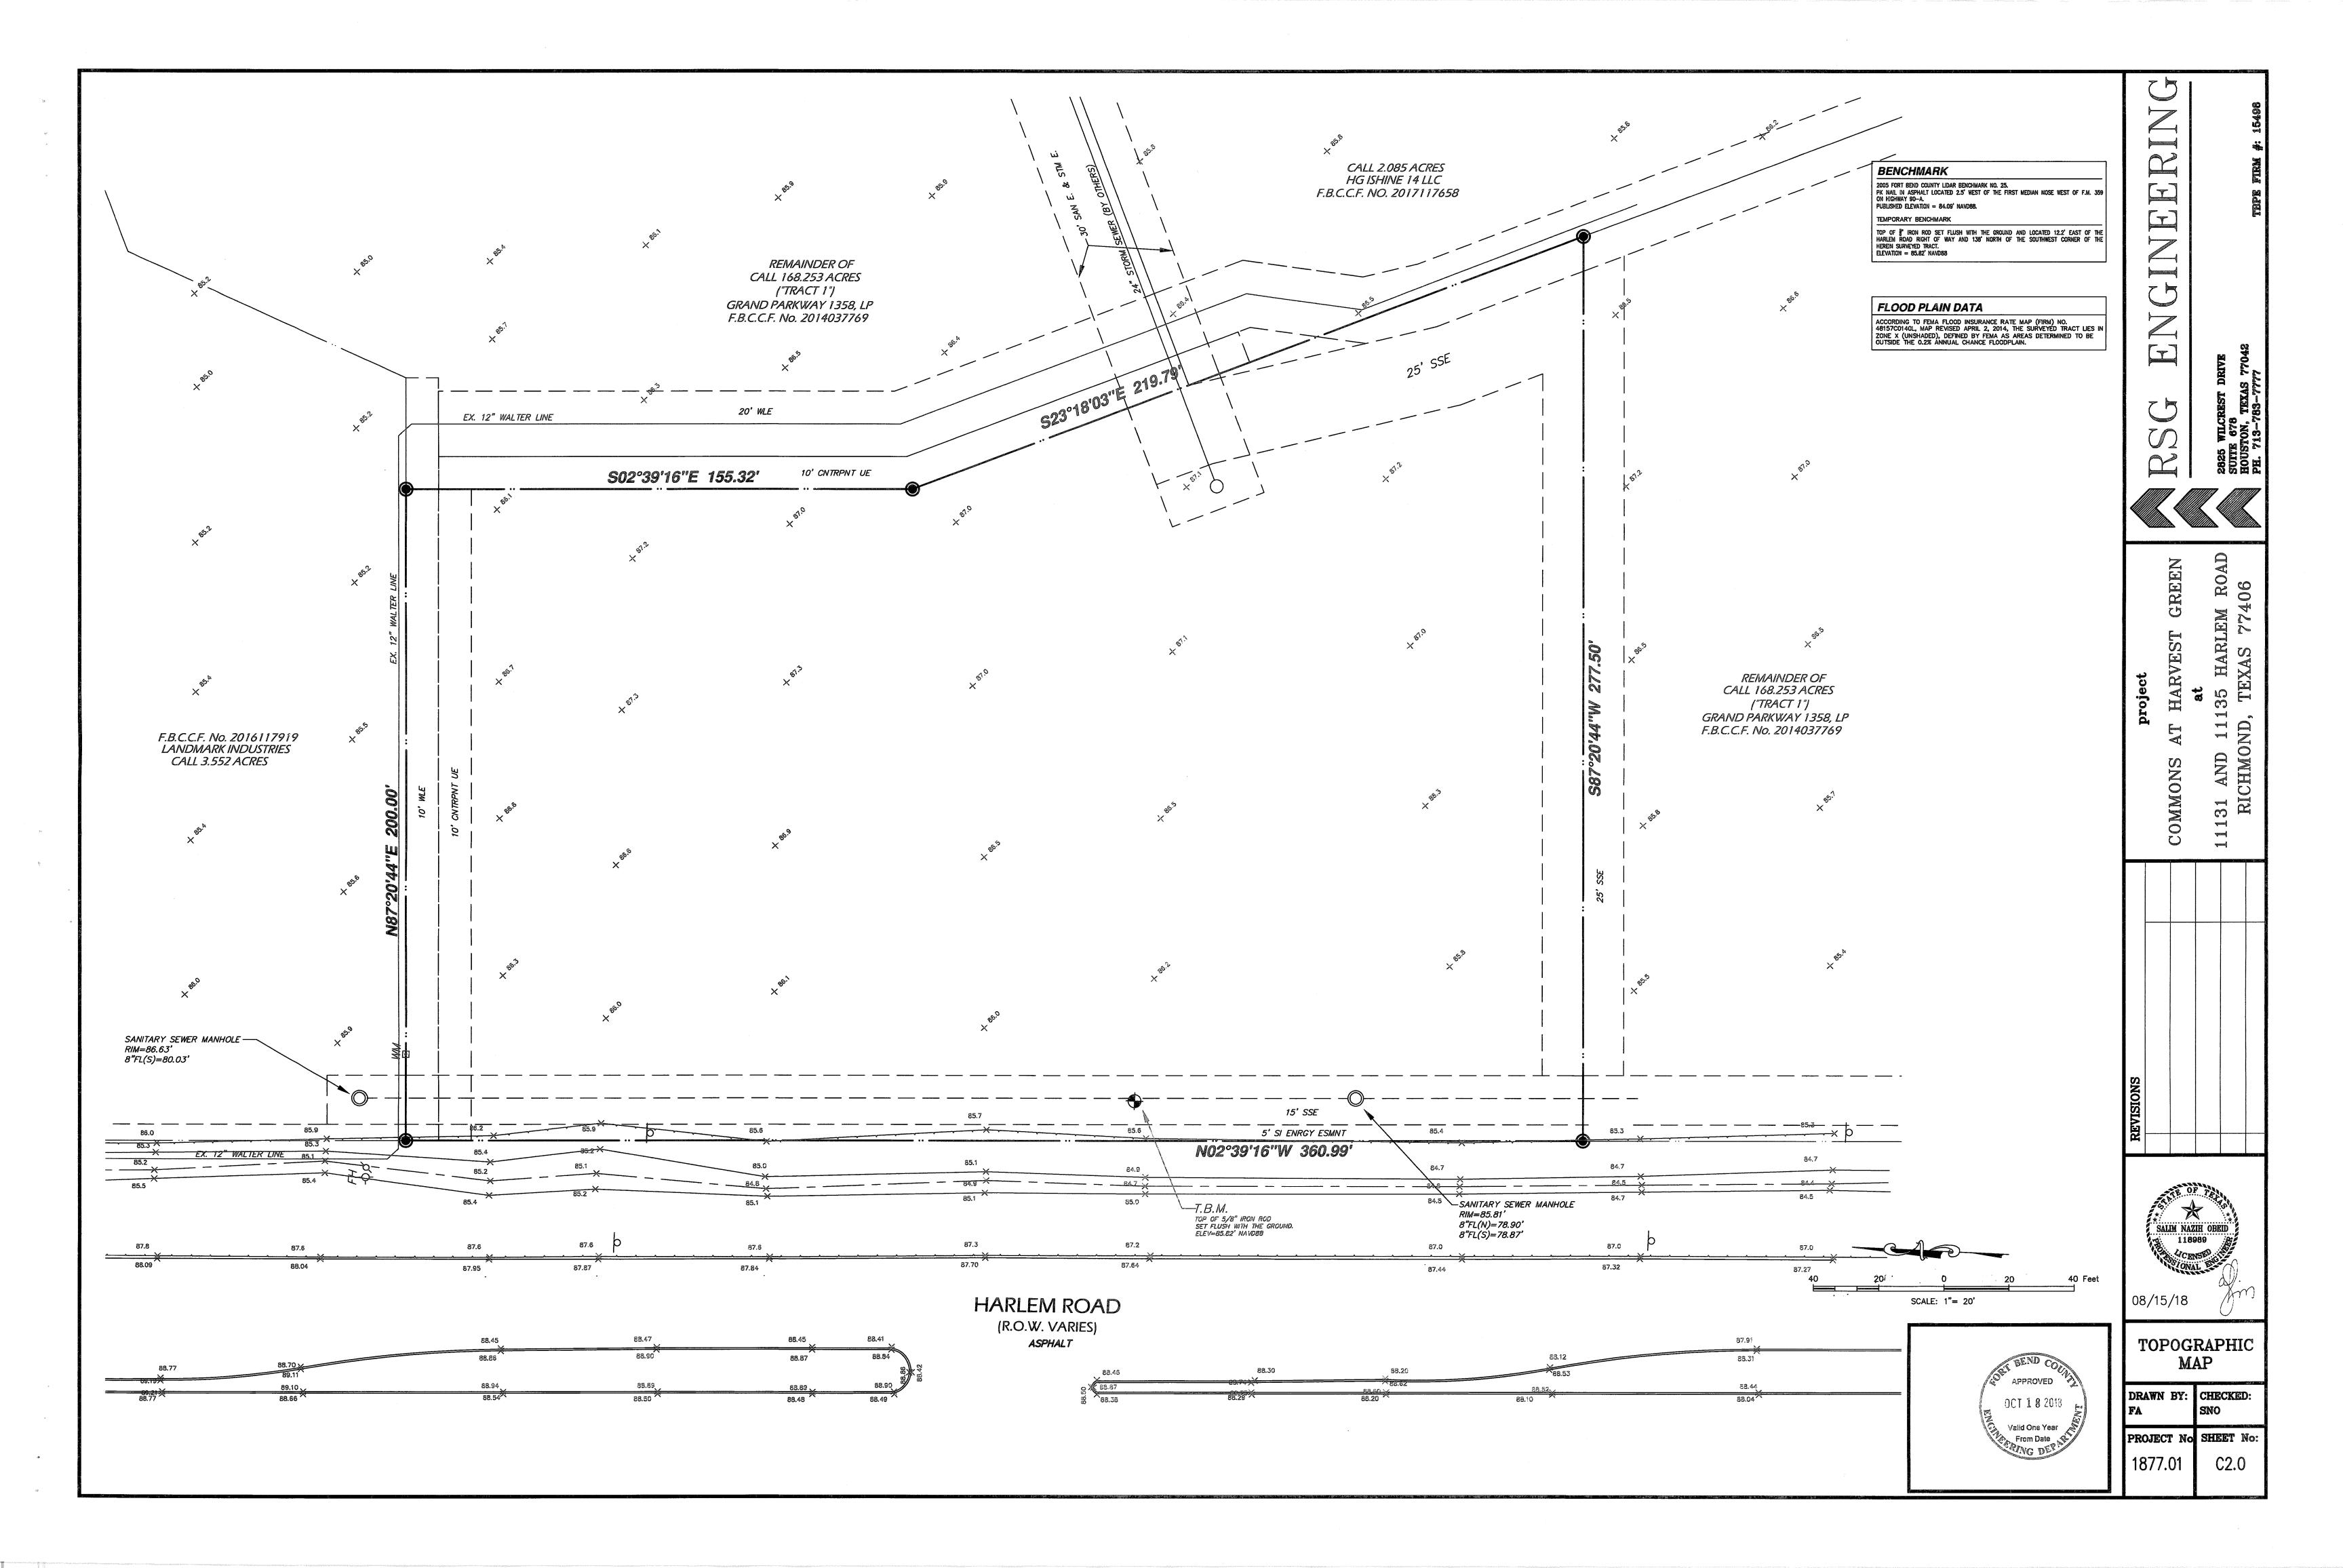

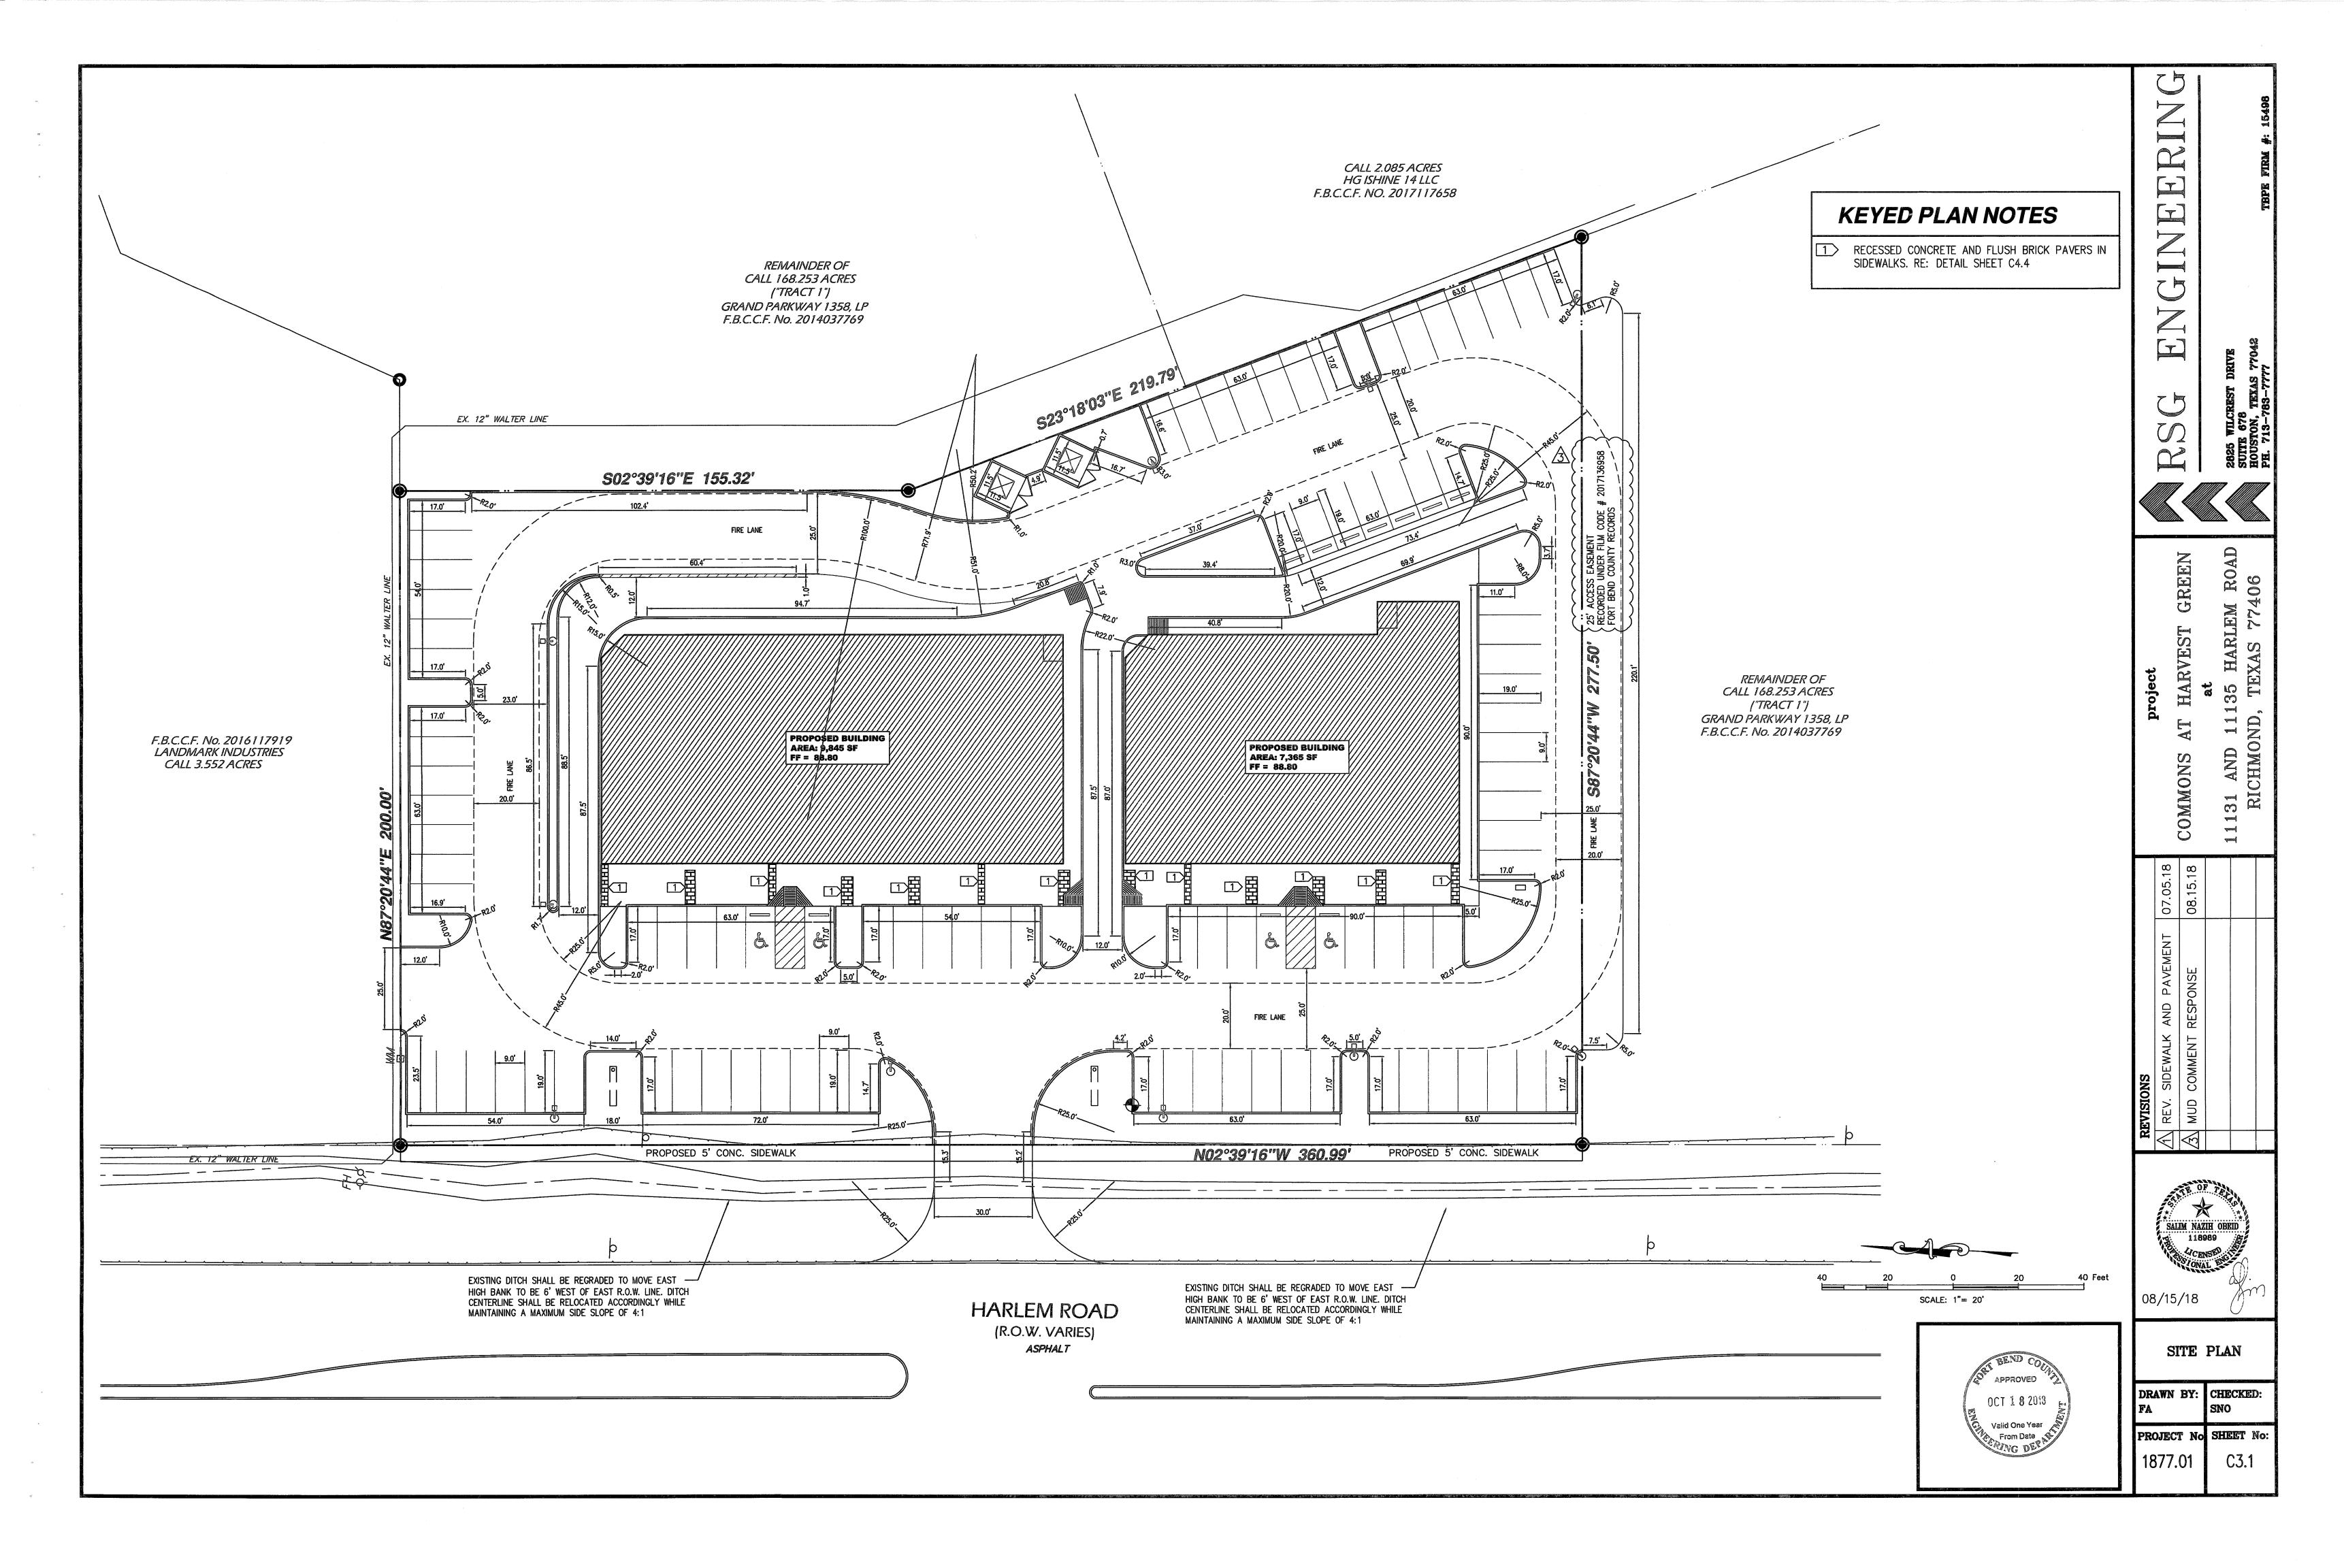

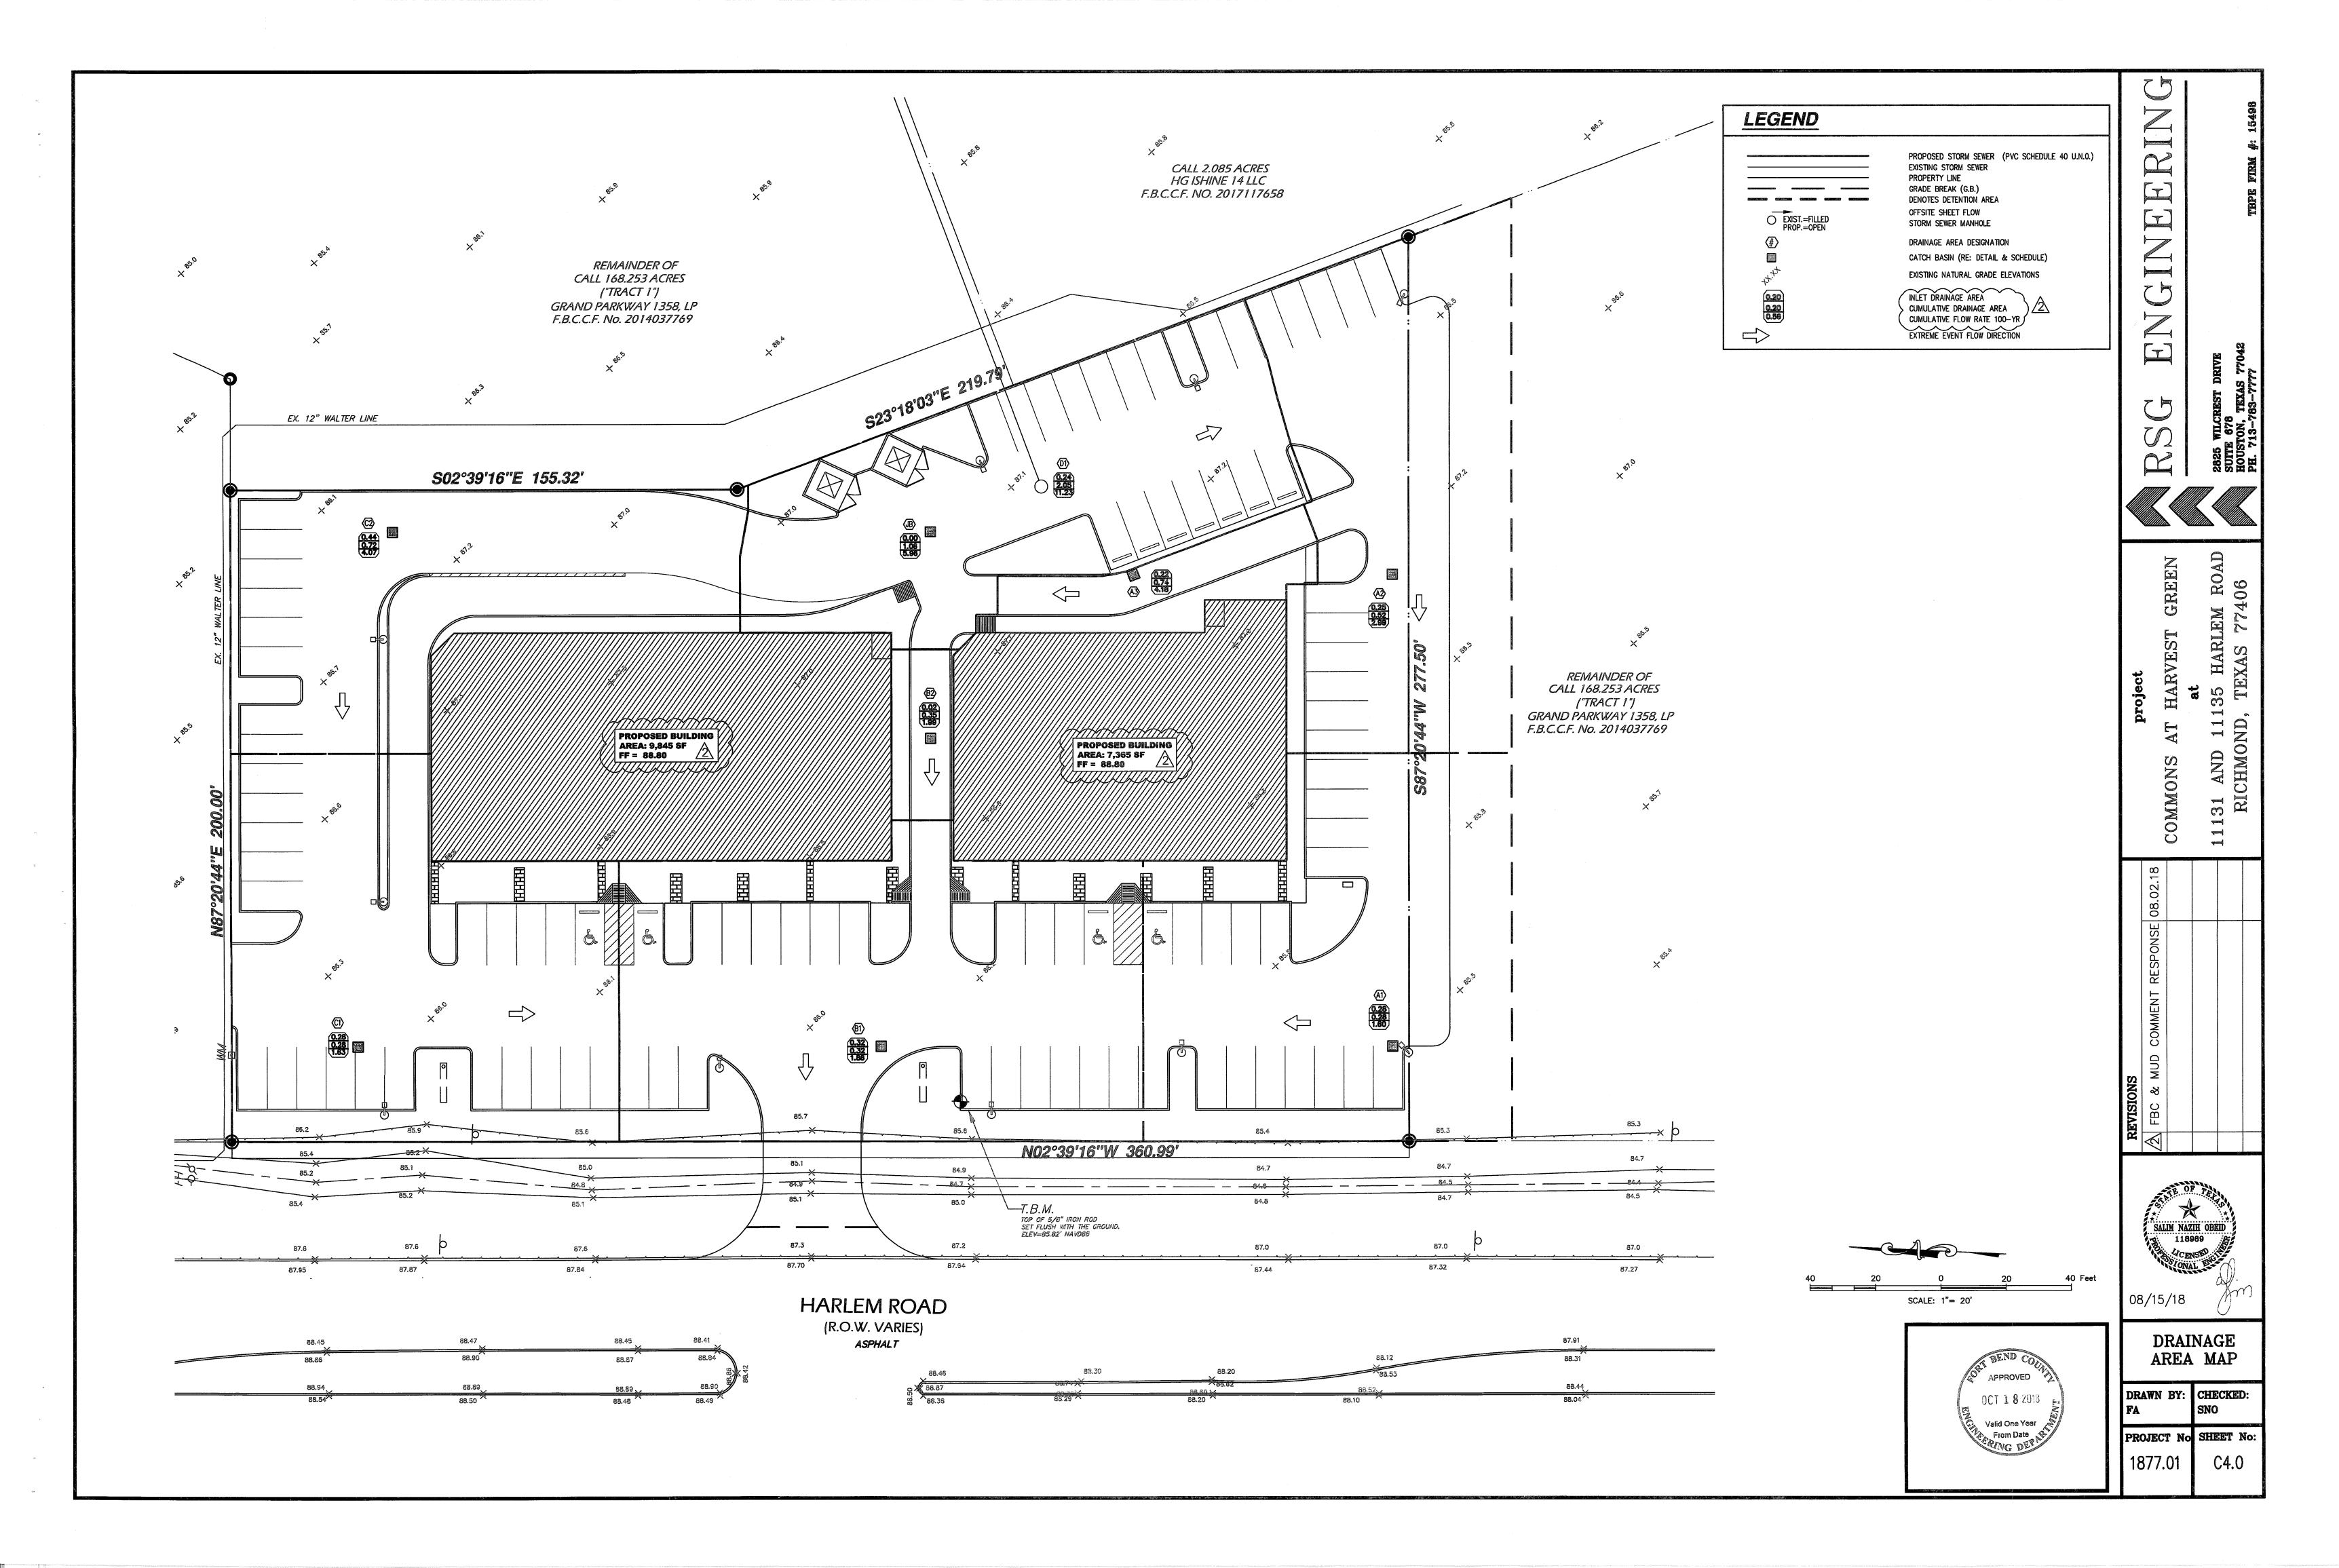


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NLET#	MAX PONDING ELEV (FT)	H	A (SF)	Q INLET CAPACITY (CFS)	REQUIRED FLOWS (CFS)
A1	87.5	1.27	2	14.48	1.60
A2	87.5	1.33	2	14.83	2.99
A3	87.8	1.76	Bernanda serveral menusuran santan	17.01	4.18
B1	87.5	1.15	1.125	7.76	1.86
B2	88.3	2.14	1.125	10.57	1.99
C1	87.5	1.07	1.125	7.46	1.63
C2	87.5	1.30	2	14.67	4.07

INLET# PROFILET# PROFILED #	MAXIMUM PONDING	TG	MAXIMUM PONDING
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A1	87.5	86.80	0.70
A2	87.5	86.90	0.60
A3 Opening the extension of the contract of t	87.8	87.40	0.40
**::::::::::::::::::::::::::::::::::::	87.5	86.80	0.70
999 grans an ague an caoise e an caoise agus an caoise agus agus agus agus agus agus agus agus	88.3	87.90	0.40
C1	87.5	86.80	0.70
C2	87.5	86.80	0.70

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PROJE	CT:	HARVES	ST GRE	baarta aree ee saaraa aa a			DESIGN S	STORM		en samuanne sekti saat die laak aan akkenin na teknisch die	mare een verver van 1884 een vervlever		yeare had distribute soor e deel see soor da a ee soor as soor ee soor ee soor ee soor ee soor ee soor ee soor	net videre vran le dramer videre armeneser		est constitution of the section					Harris de la composición del composición de la c			k Marie e a tireceta e e e e e e e e e e e e e e e e e e
JOB NO) :	1877.01						2-YR	10-YR	100-YR		I = b/(d+T)	°C)^e			FL=Flo	wline							
SYSTE	M:	100	YR STM	DESIG	N		b=	75.01	93.53	125.4		Tc = 10xA	۱٬(0.1761)	+ 15		HG= H	/drualic	Gradient	i fan in Herse (altare) in Herse Hersee H					The state of the section of the section of
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DA	DA	AREA	TOTAL	RUNOFF	SUM OF	TC	INTENSITY	SUM OF	REA CH	DIAM.	Slope	Manning's	Design	Design	Fall	FL.	FL.	Actual	Friction	HGL	HGL	HGL	TG	TG-HG
FROM	ТО	(A CRES)	AREA	COEFF.		(MIN.)		FLOWS		OR RISE	ntergron gyffir EP egypen tallen i sen en en en en entertal en en e		Capacity	Velocity		Elev.	Elev.	Velocity	Loss	⊟ev	⊟ev	Slope	Elev	
напрыядання праводня	. V. DODONIK PRZIOWATE. WKODODE		(ACRES)	C	C*A		(IN/HR)	(CFS)	(FT)	(IN)	%	"h" neessaanitaanista reviterassa viimeretäänää	(CFS)	(ft/s)	(FT)	UP (FT)	DS (FT)	(ft/s)	(ft)	UP (FT)	DS (FT)	%	UP (FT)	eljanovos to sneemintensis esimes e
A1	A2	0.28	0.28	0.80	0.22	22.97	7.25	1.60	145	15	0.25	0.011	3.83	3.12	0.36	82.44	82.08	1.30	0.06	86.23	86.17	0.04	86.80	0.57
A2	А3	0.25	0.52	0.80	0.42	23.92	7.13	2.99	79	15	0.25	0.011	3.83	3.12	0.20	82.08	81.88	2.43	0.12	86.17	86.04	0.15	86.90	0.73
A3	D1	0.22	0.74	0.80	0.59	24.48	7.07	4.18	39	18	0.20	0.011	5.57	3.15	0.08	81.88	81.80	2.37	0.04	86.04	86.00	0.11	87.30	1.26
B 1	B2	0.32	0.32	0.80	0.26	23.19	7.22	1.86	96	12	0.32	0.011	2.39	3.04	0.31	81.83	81.52	2.37	0.19	86.35	86.16	0.20	86.80	0.45
B2	JB	0.02	0.35	0.80	0.28	23.29	7.21	1.99	63	12	0.32	0.011	2.39	3.04	0.20	81.52	81.32	2.53	0.14	86.16	86.02	0.22	87.50	1.34
C1	B2	0.28	0.28	0.80	0.23	23.00	7.24	1.63	158	12	0.32	0.011	2.39	3.04	0.51	82.15	81.65	2.08	0.24	86.43	86.20	0.15	86.80	0.37
**************************************	JB	0.44	0.72	0.80	0.58	24.44	7.07	4.07	165	18	0.20	0.011	5.57	3.15	0.33	81.65	81.32	2.30	0.18	86.20	86.02	0.11	86.90	0.70
16-00-00-00-00-00-00-00-00-00-00-00-00-00	D1	0.00	1.06	0.80	0.85	25.11	7.00	5.96	37	24	0.18	0.011	111.37	3.62	0.07	81.32	81.25	1.90	0.02	86.02	86.00	0.05	87.25	1.23
D1	OUT	0.24	2.05	0.80	1.64	26.34	6.86	11.23	44	24	0.18	0.011	11.37	3.62	0.08	,		3.57	0.08	And the most of the author of an inter-			87.00	87.00

PROJE	CT:	HARVES	ST GRE	EN			DESIGN S	STORM					Ministrania el esastava alles sueventaministrators su										
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FROM	**************************************	(ACRES)	AREA (ACRES)	COEFF. C	C*A	(MN.)	(IVHR)	FLOWS (CFS)	LENGTH (FT)	OR RISE (IN)	101 NO. 152 PER	"n"	Capacity (CFS)	Velocity (ft/s)	(FT)	⊟ev. UP (FT)	⊟ev. DS (FT)	Velocity (ft/s)	Loss (ft)	⊟ev UP (FT)	⊟ev DS (FT)	Slope %	⊟ev UP (FT)
A1	A2	0.28	0.28	0.80	0.22	22.97	3.55	0.78	145	15	0.25	0.011	3.83	3.12	0.36	Barrell NV - 64/8/28/2014/8/2 Till St. Bill St. 2 I	82.08	0.64	0.02	83.69	83.41	0.19	86.80
A2	A3	0.25	0.52	0.80	0.42	23.92	3.48	1.46	79	15	0.25	0.011	3.83	3.12	0.20	82.08	81.88	1.19	0.03	83.41	83.38	0.04	86.90
A3	D1	0.22	0.74	0.80	0.59	24.48	3.44	2.04	39	18 	11.41110 VIVII (2000) (0.011	5.57	3.15	0.08	81.88	81.80	1.15	0.01	83.38	83.30	0.20	87.30
B1	B2	0.32	0.32	0.80	0.26	23.19	3.54	0.91	96	12	0.32	0.011	2.39	3.04	0.31	81.83	81.52	1.16	0.05	83.40	83.35	0.05	86.80
B2	JB	0.02	0.35	0.80	0.28	23.29	3.53	0.97	63	12 ************************************	0.32	0.011	2.39	3.04	0.20	81.52	81.32	1.24	0.03	83.35	83.32	0.05	87.50
C1	B2	0.28	0.28	0.80	0.23	23.00	3.55	0.80	158	12	0.32	0.011	2.39	3.04	0.51	82.15	81.65	1.02	0.06	83.42	83.36	0.04	86.80
C2	JB	0.44	0.72	0.80	0.58	24.44	3.45	1.98	165	18	0.20	0.011	5.57	3.15	0.33	81.65	81.32	1.12	0.04	83.36	83.32	0.03	86.90
JB	D1	0.00	1.06	0.80	0.85	25.11	3.40	2.89	37	24	0.18	0.011	11.37	3.62	0.07	81.32	81.25	0.92	0.00	83.32	83.25	0.18	87.25
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ENGINEERING
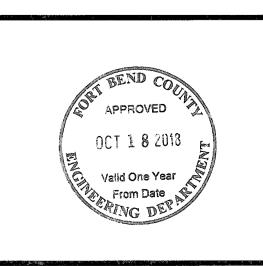
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HOUSTON, TEXAS 77042
PH. 713-783-7777


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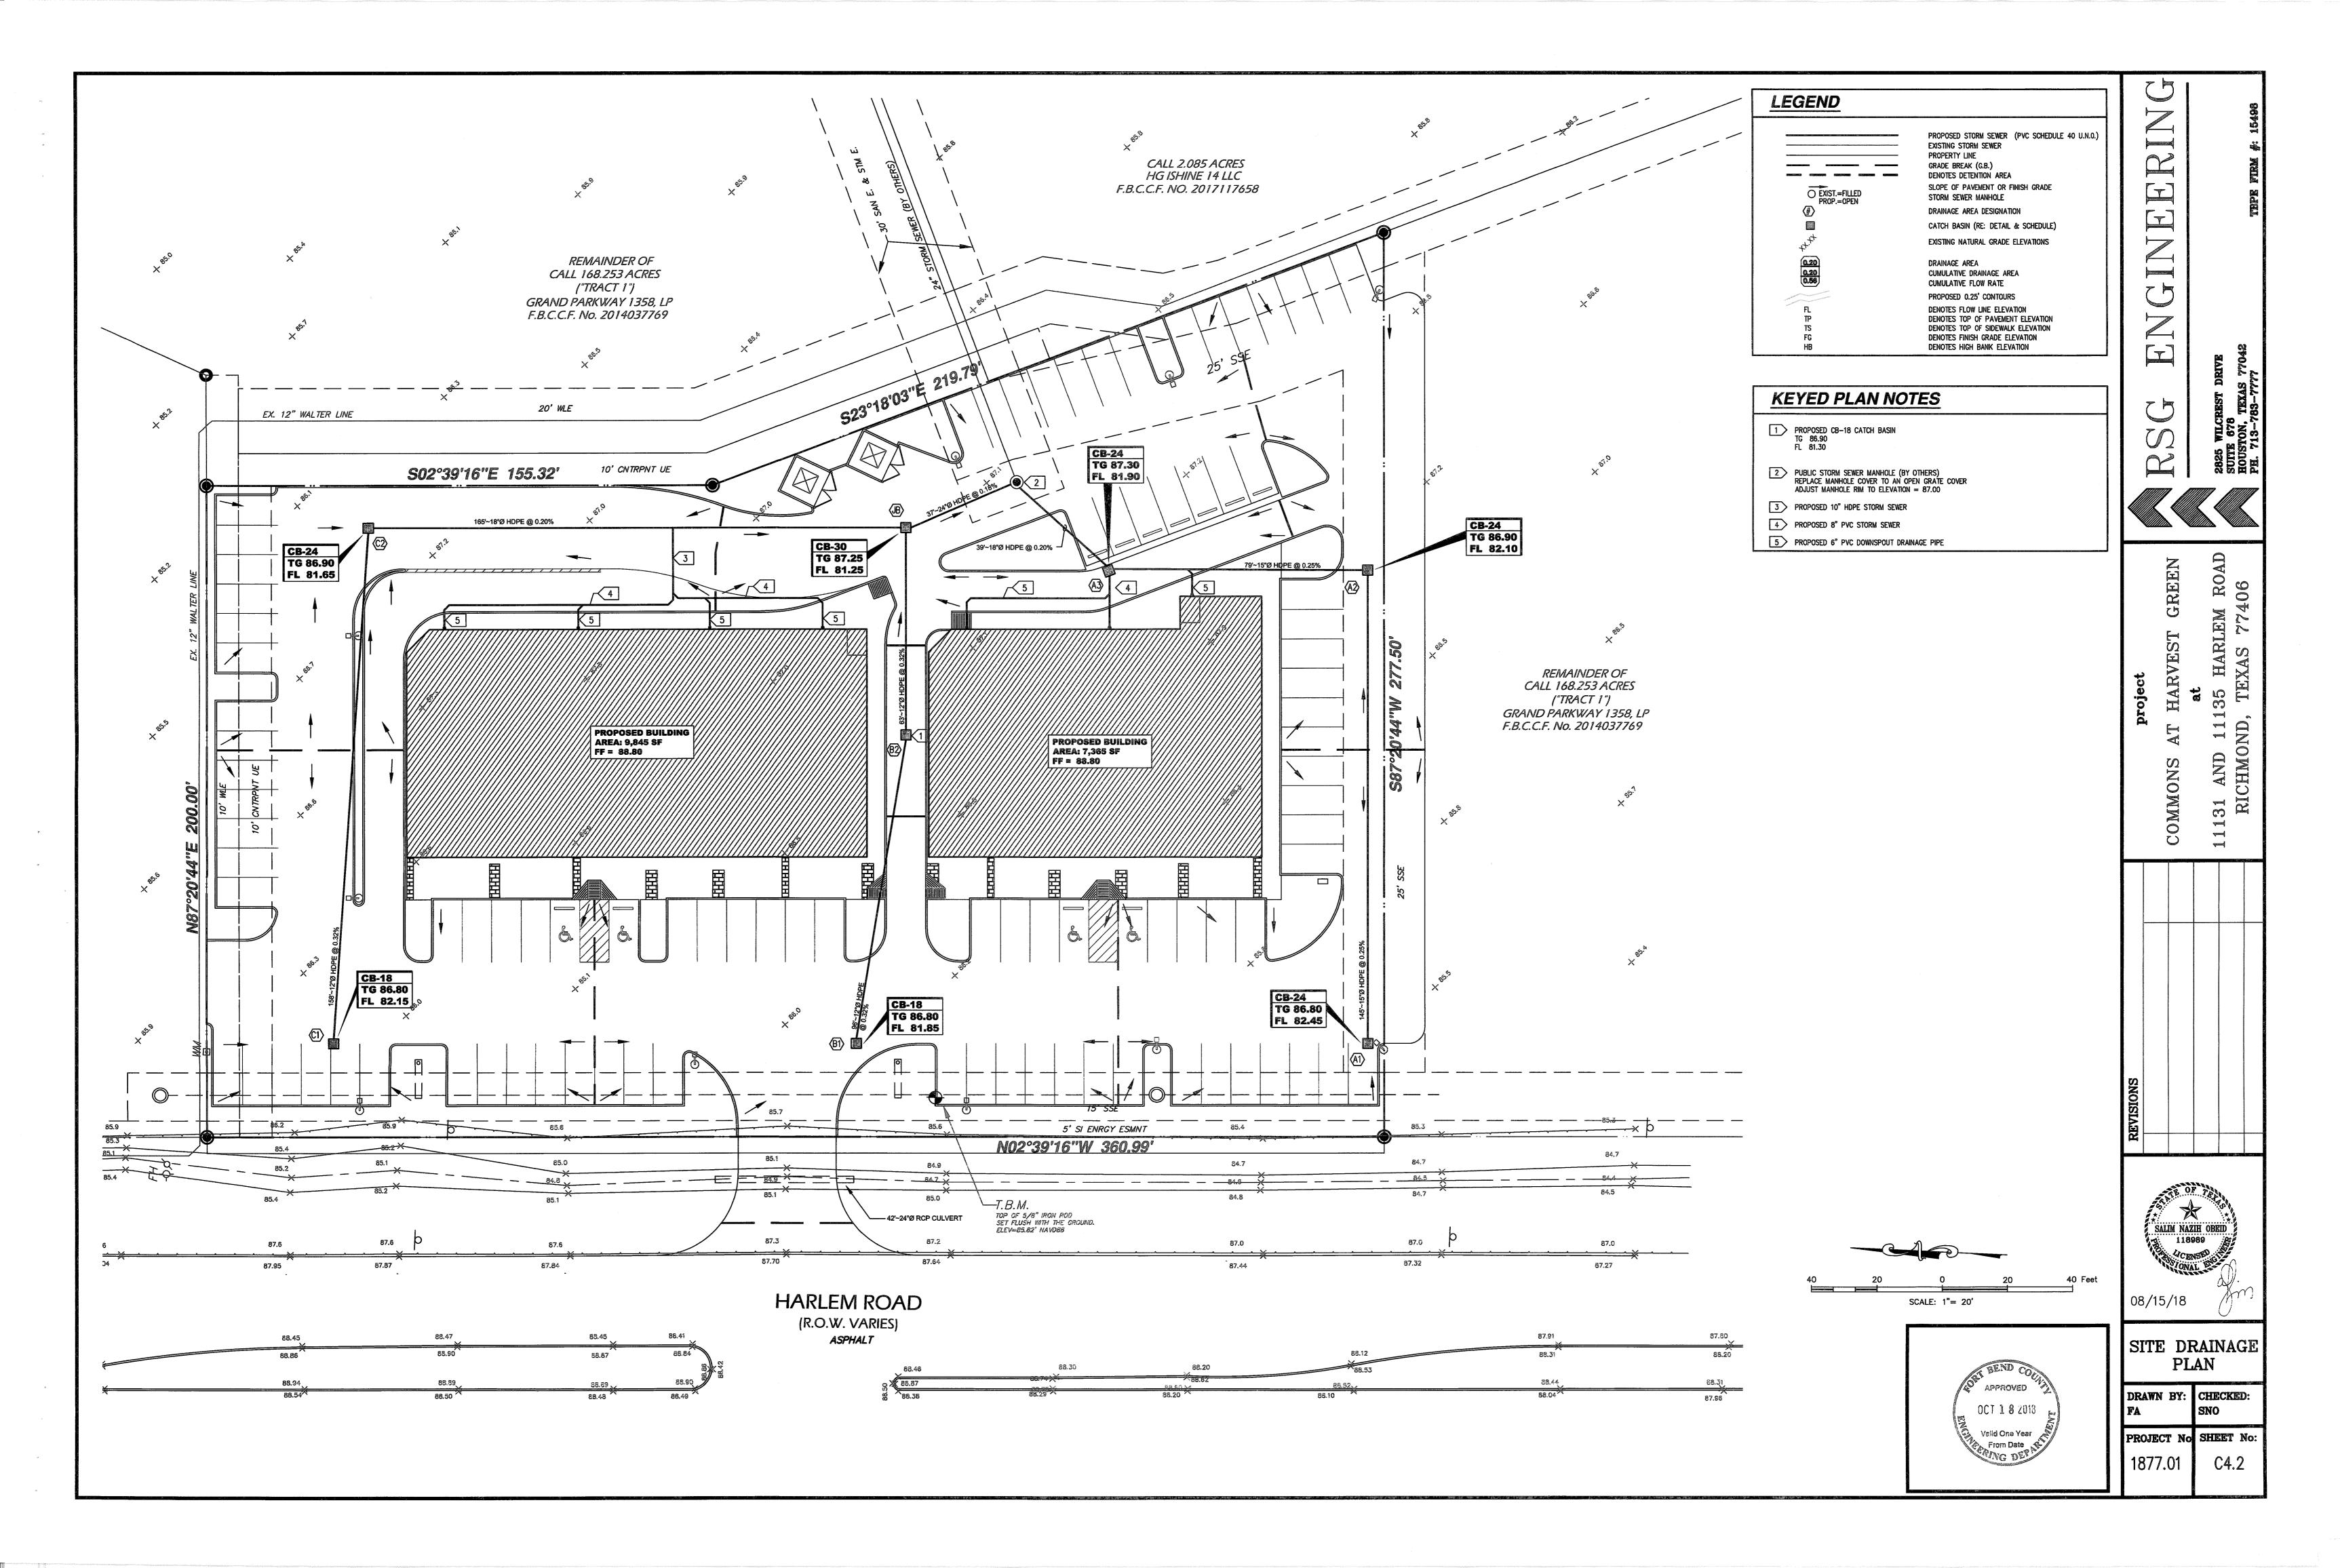
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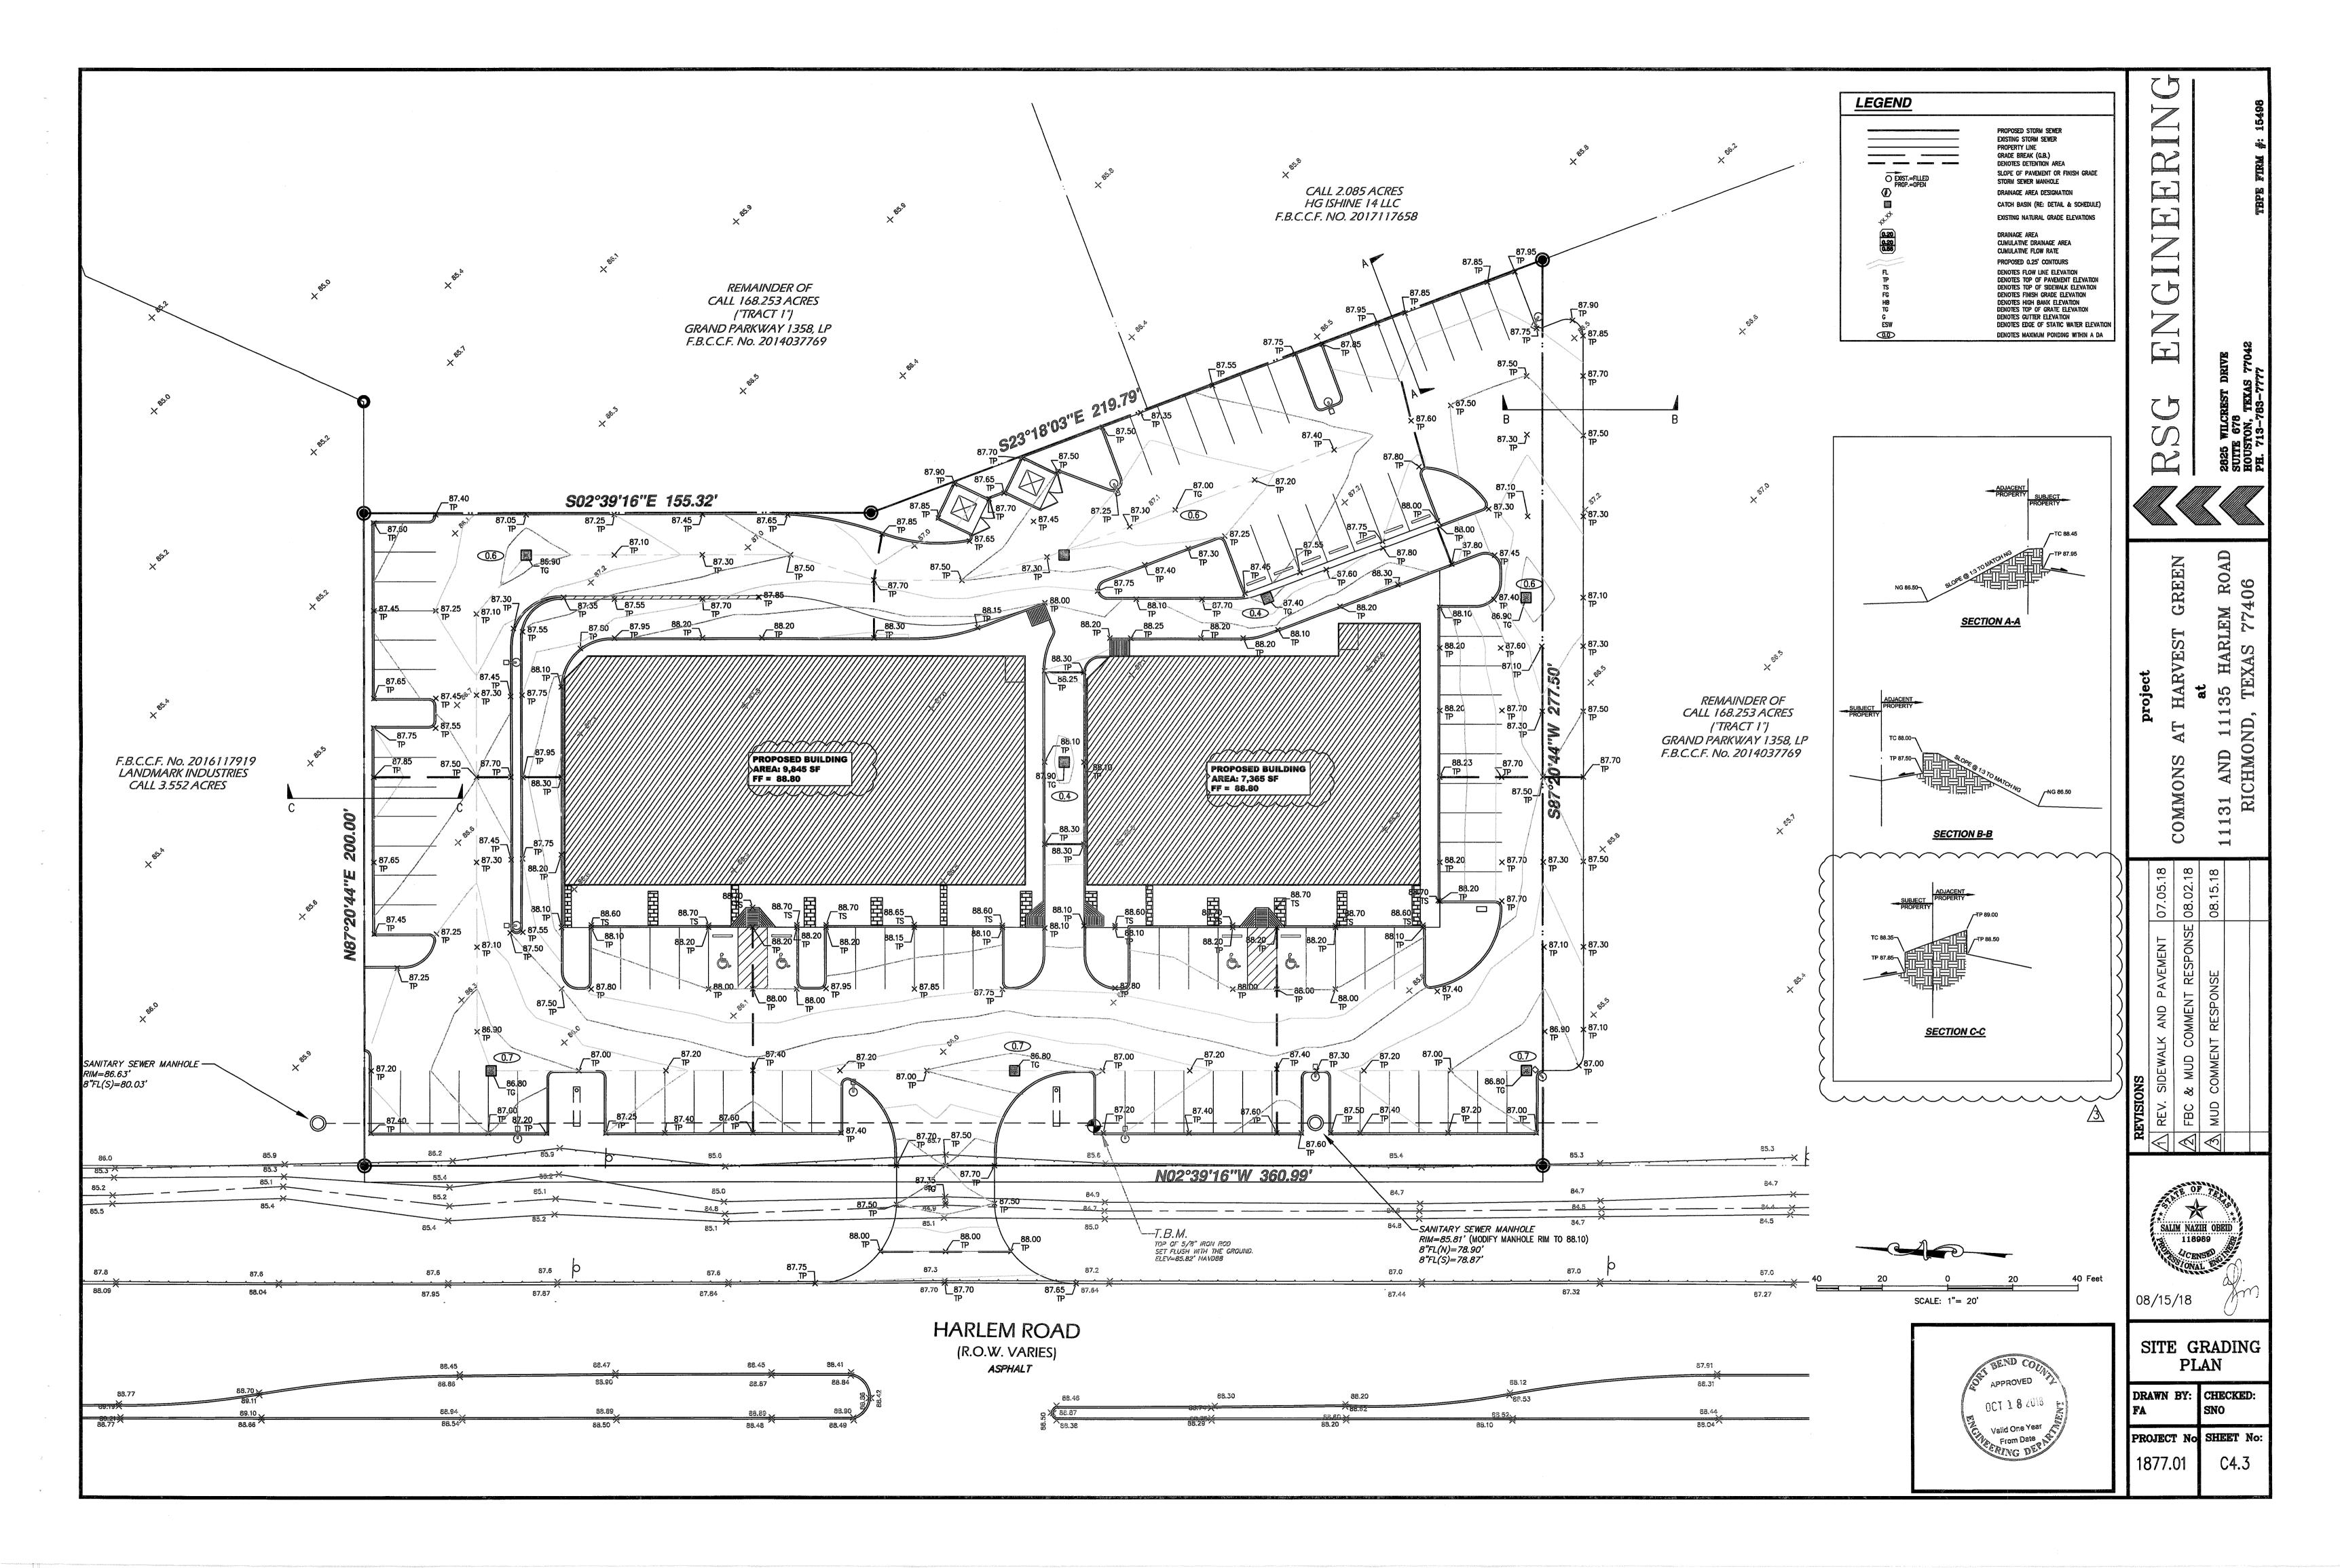
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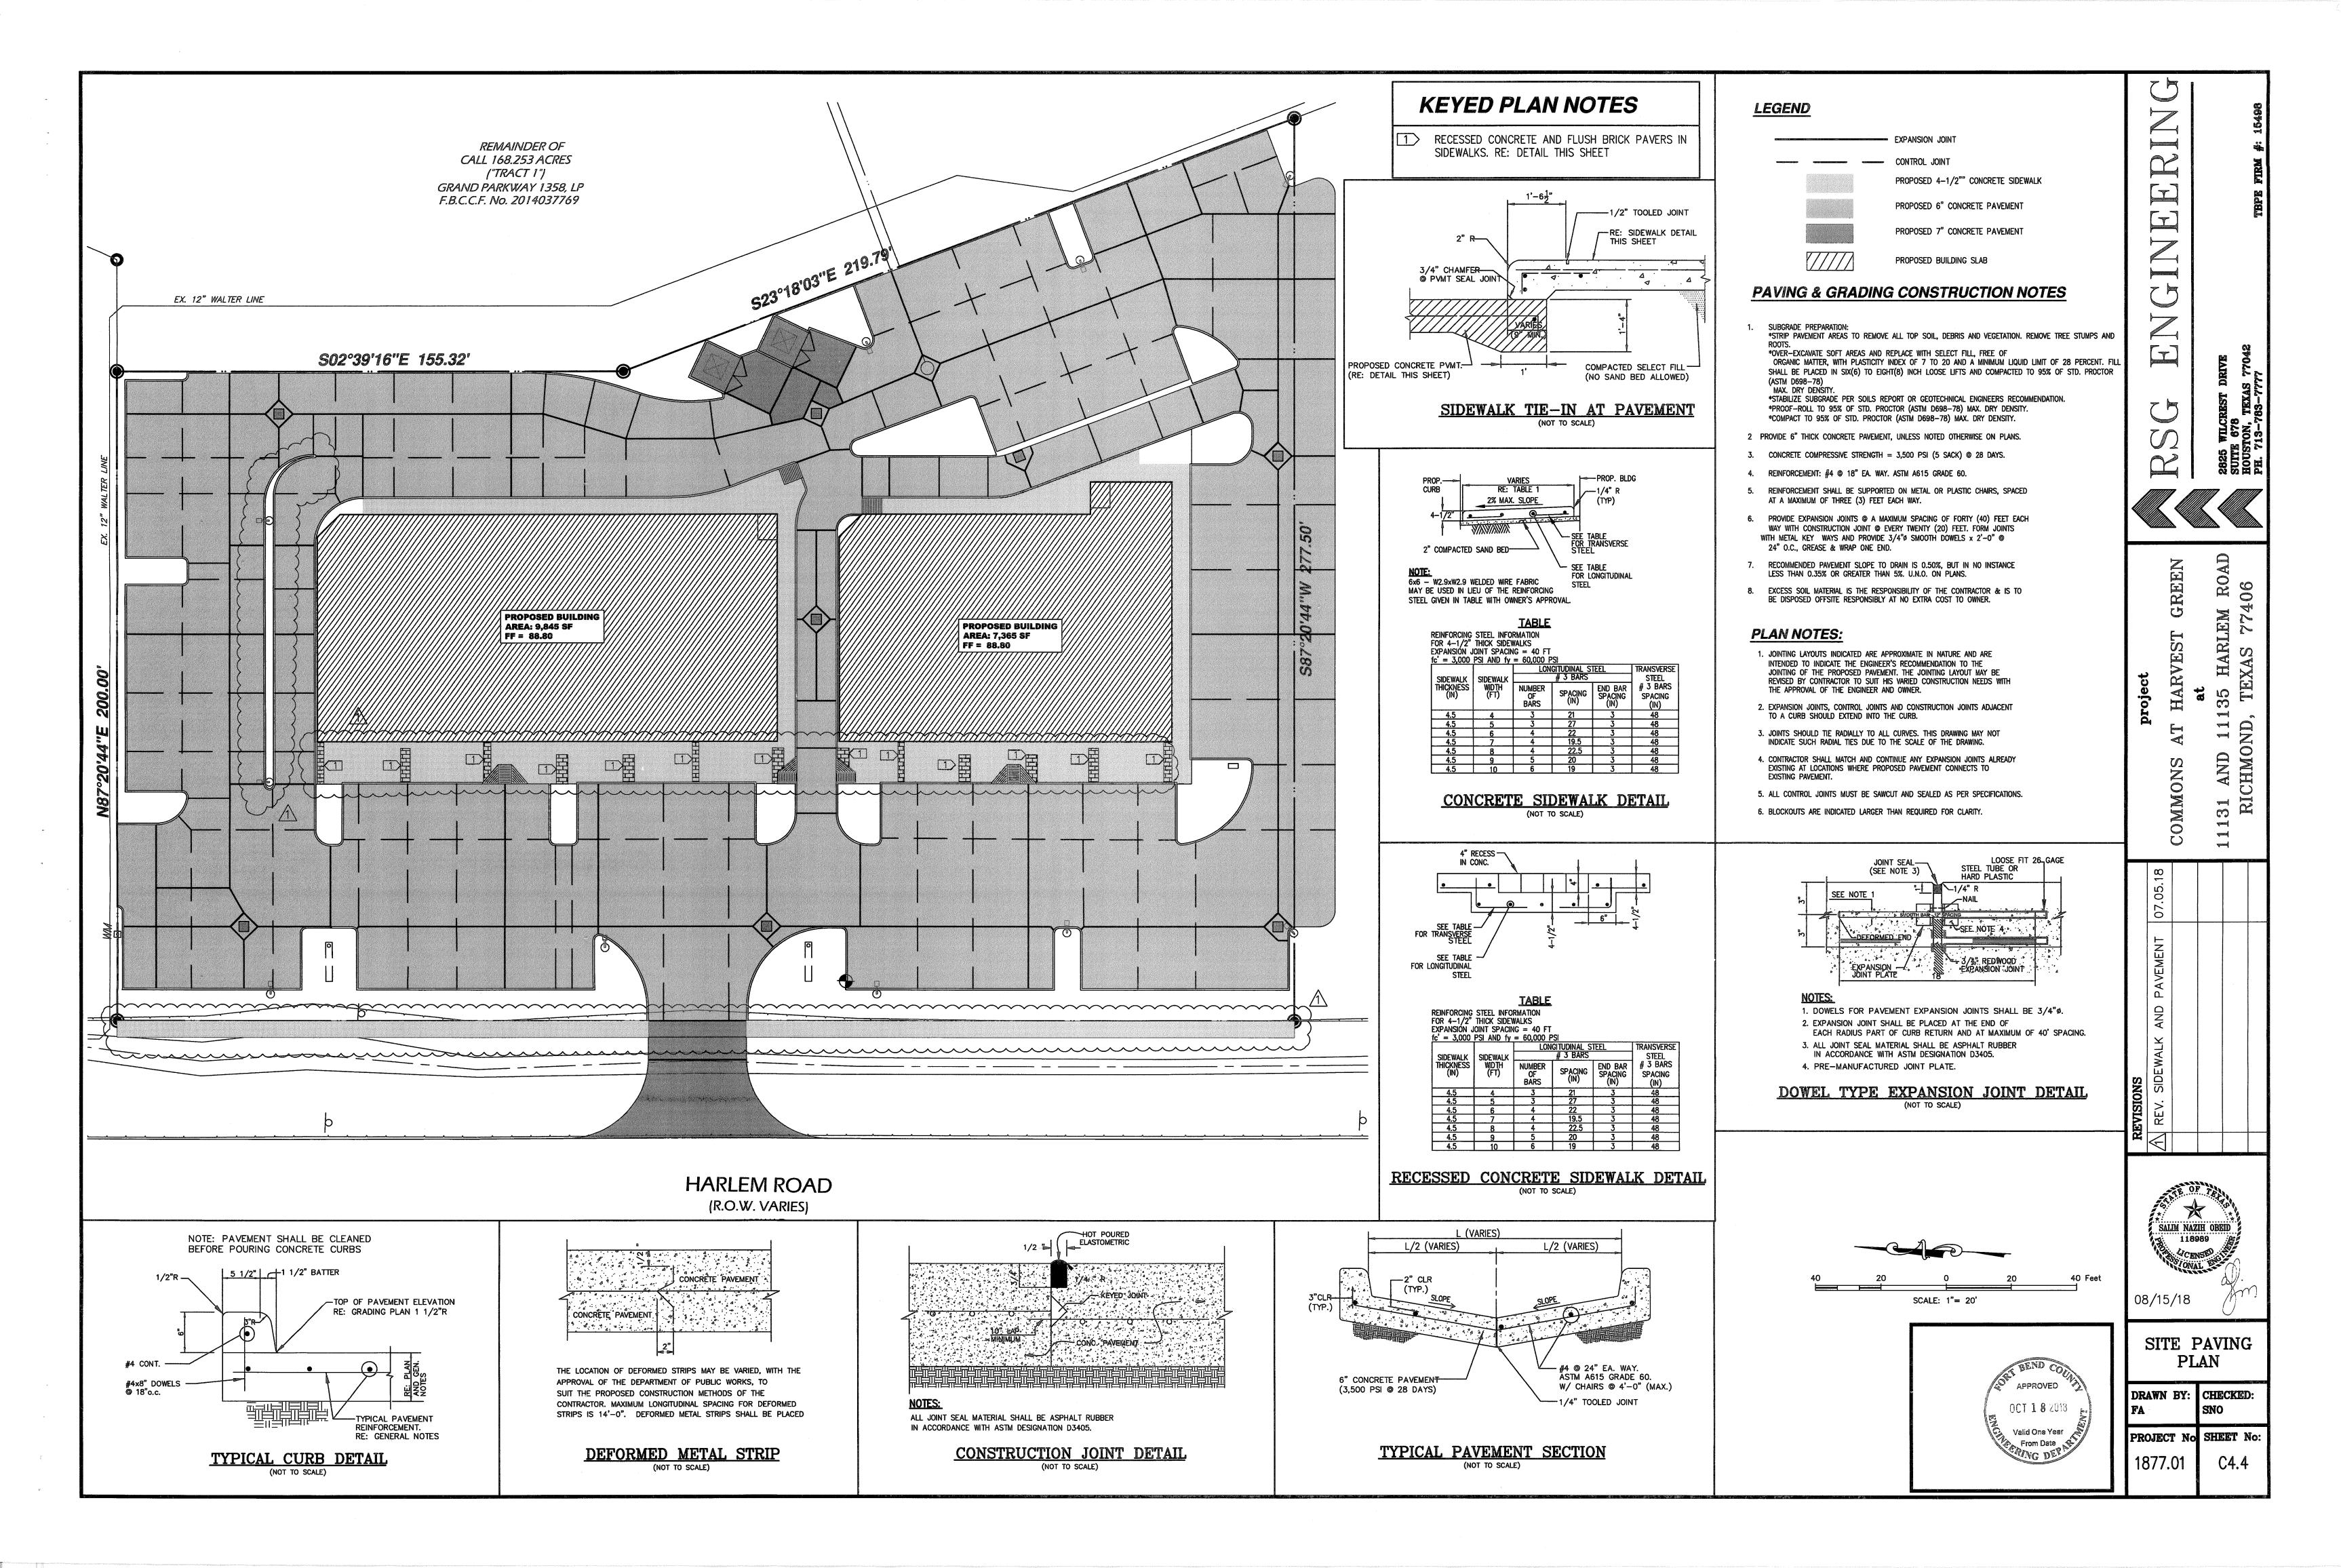



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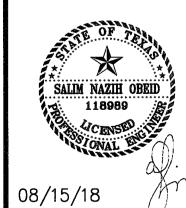







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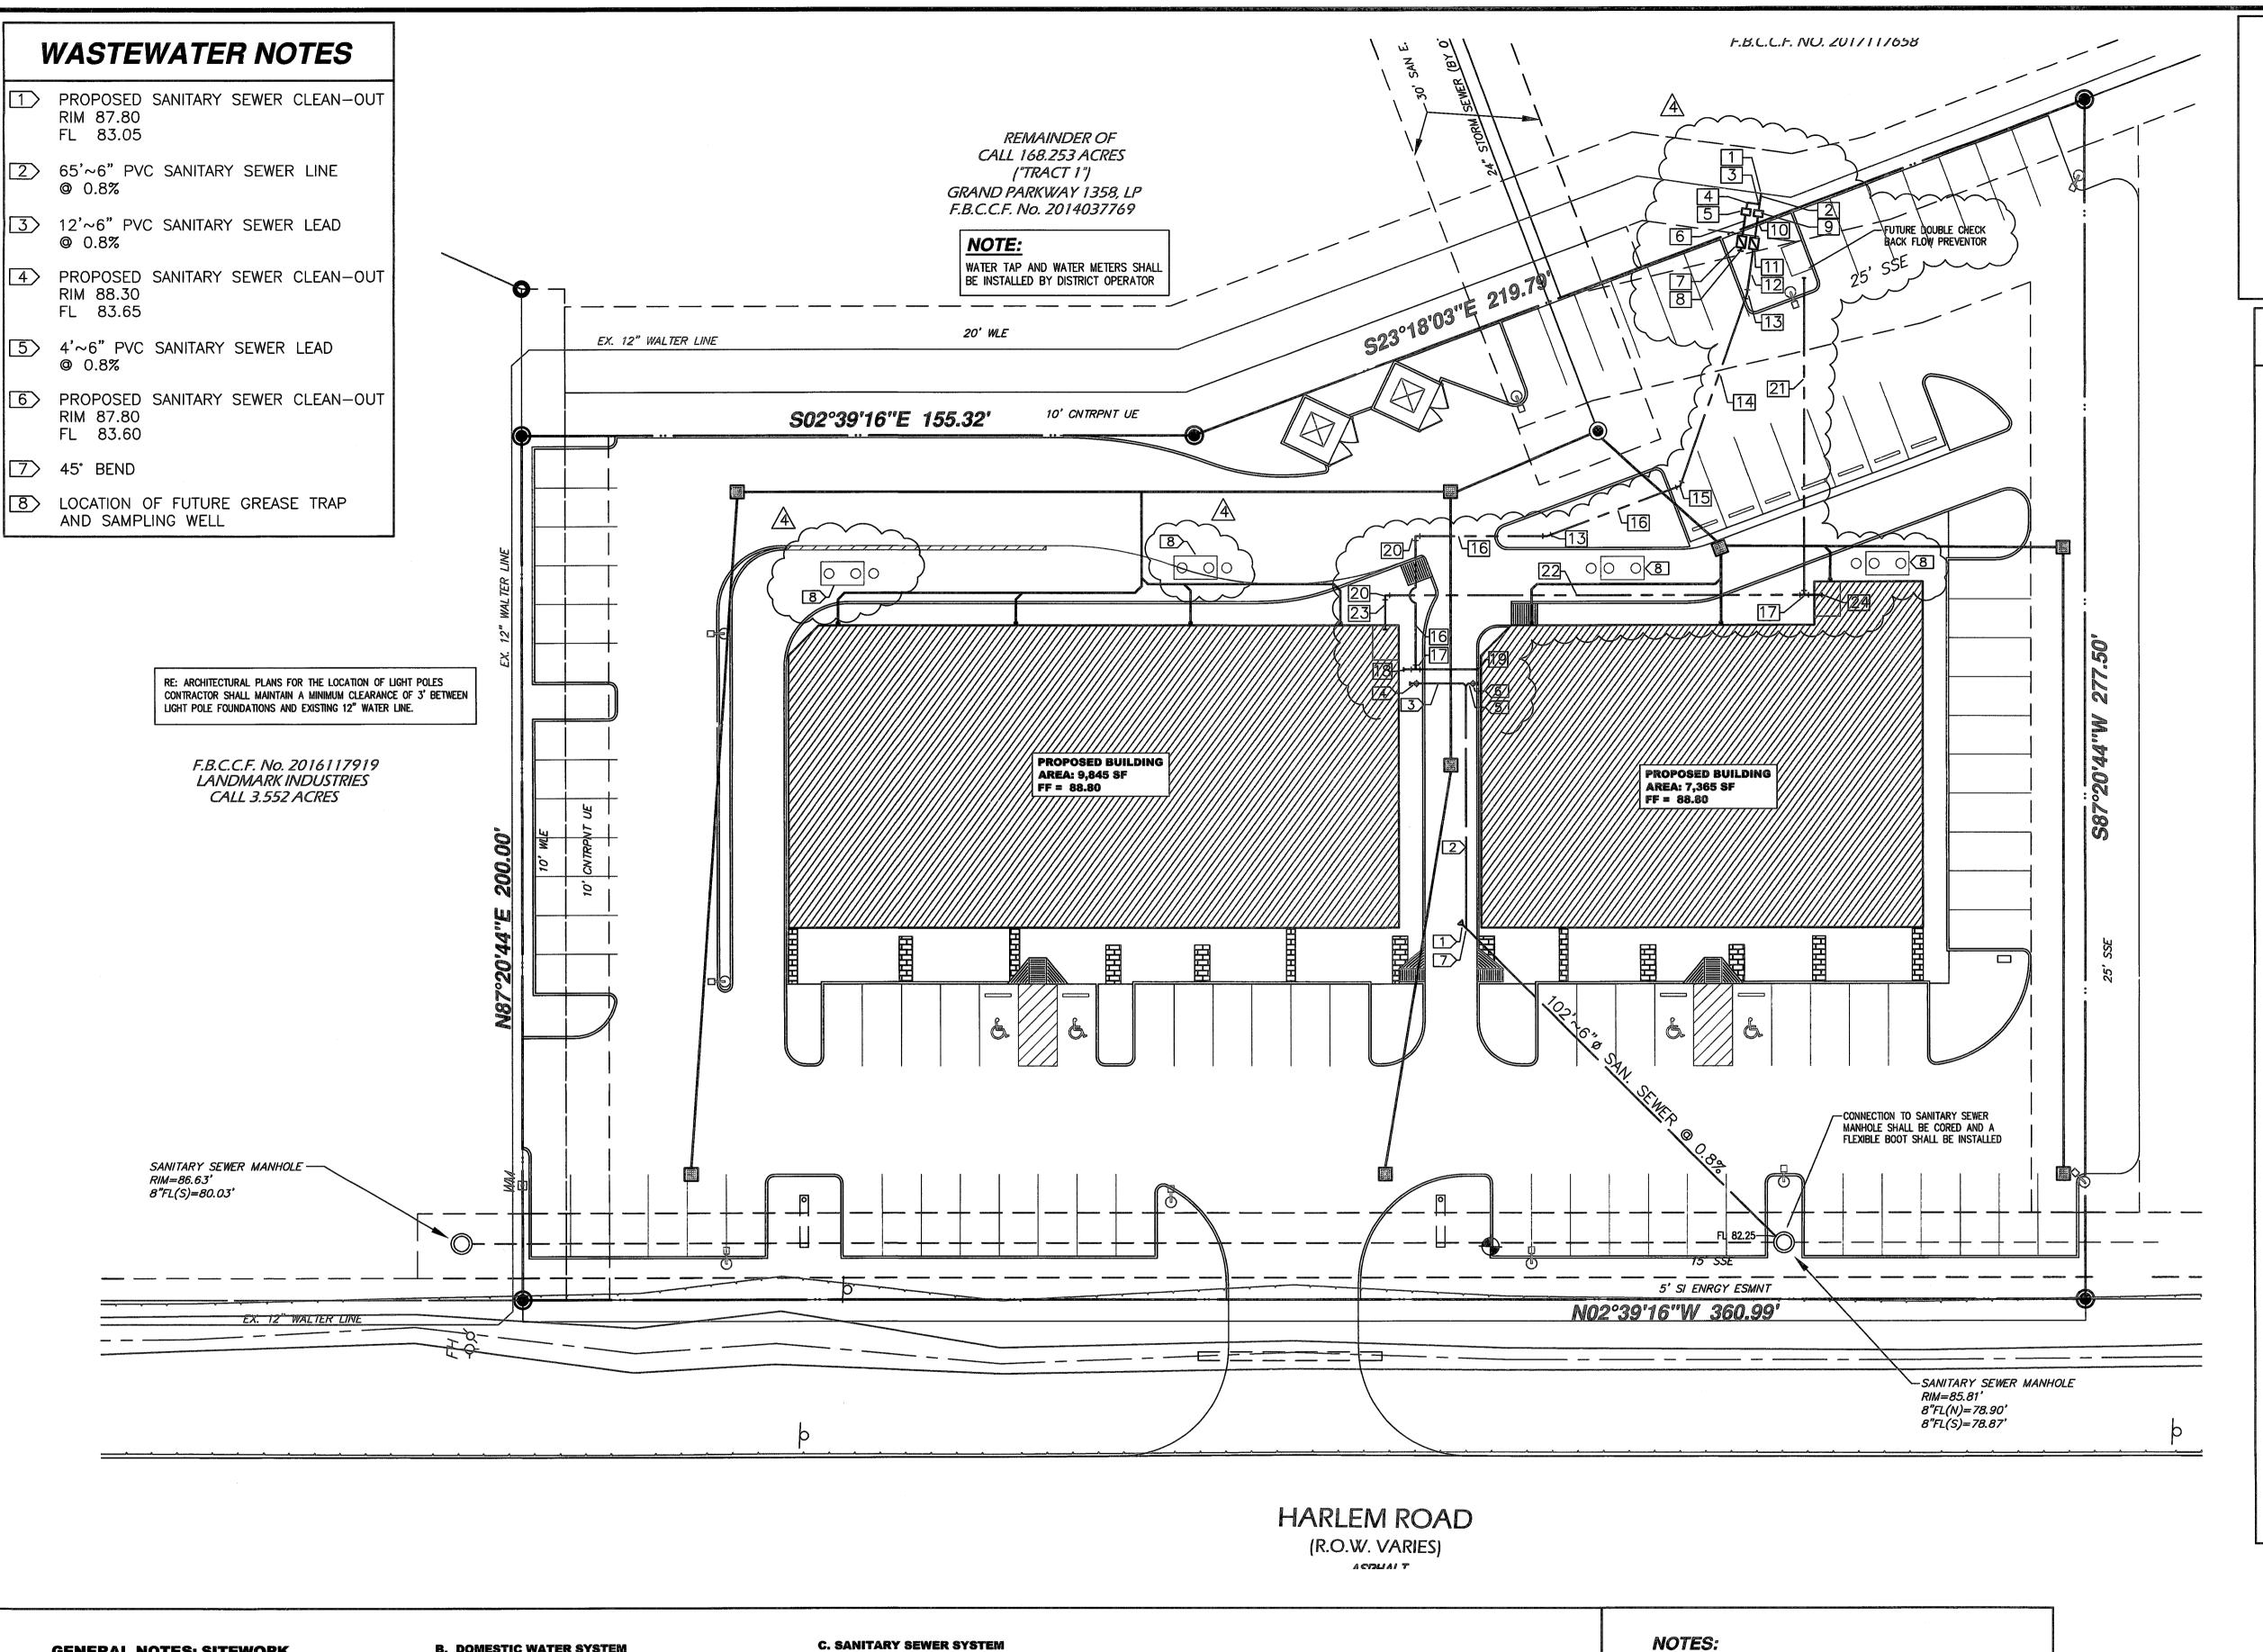
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STORM WATER POLLUTION PREVENTION PLAN

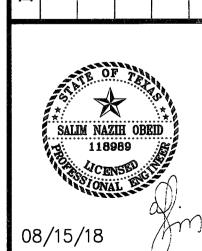DRAWN BY: CHECKED: PROJECT NO SHEET NO C5.1

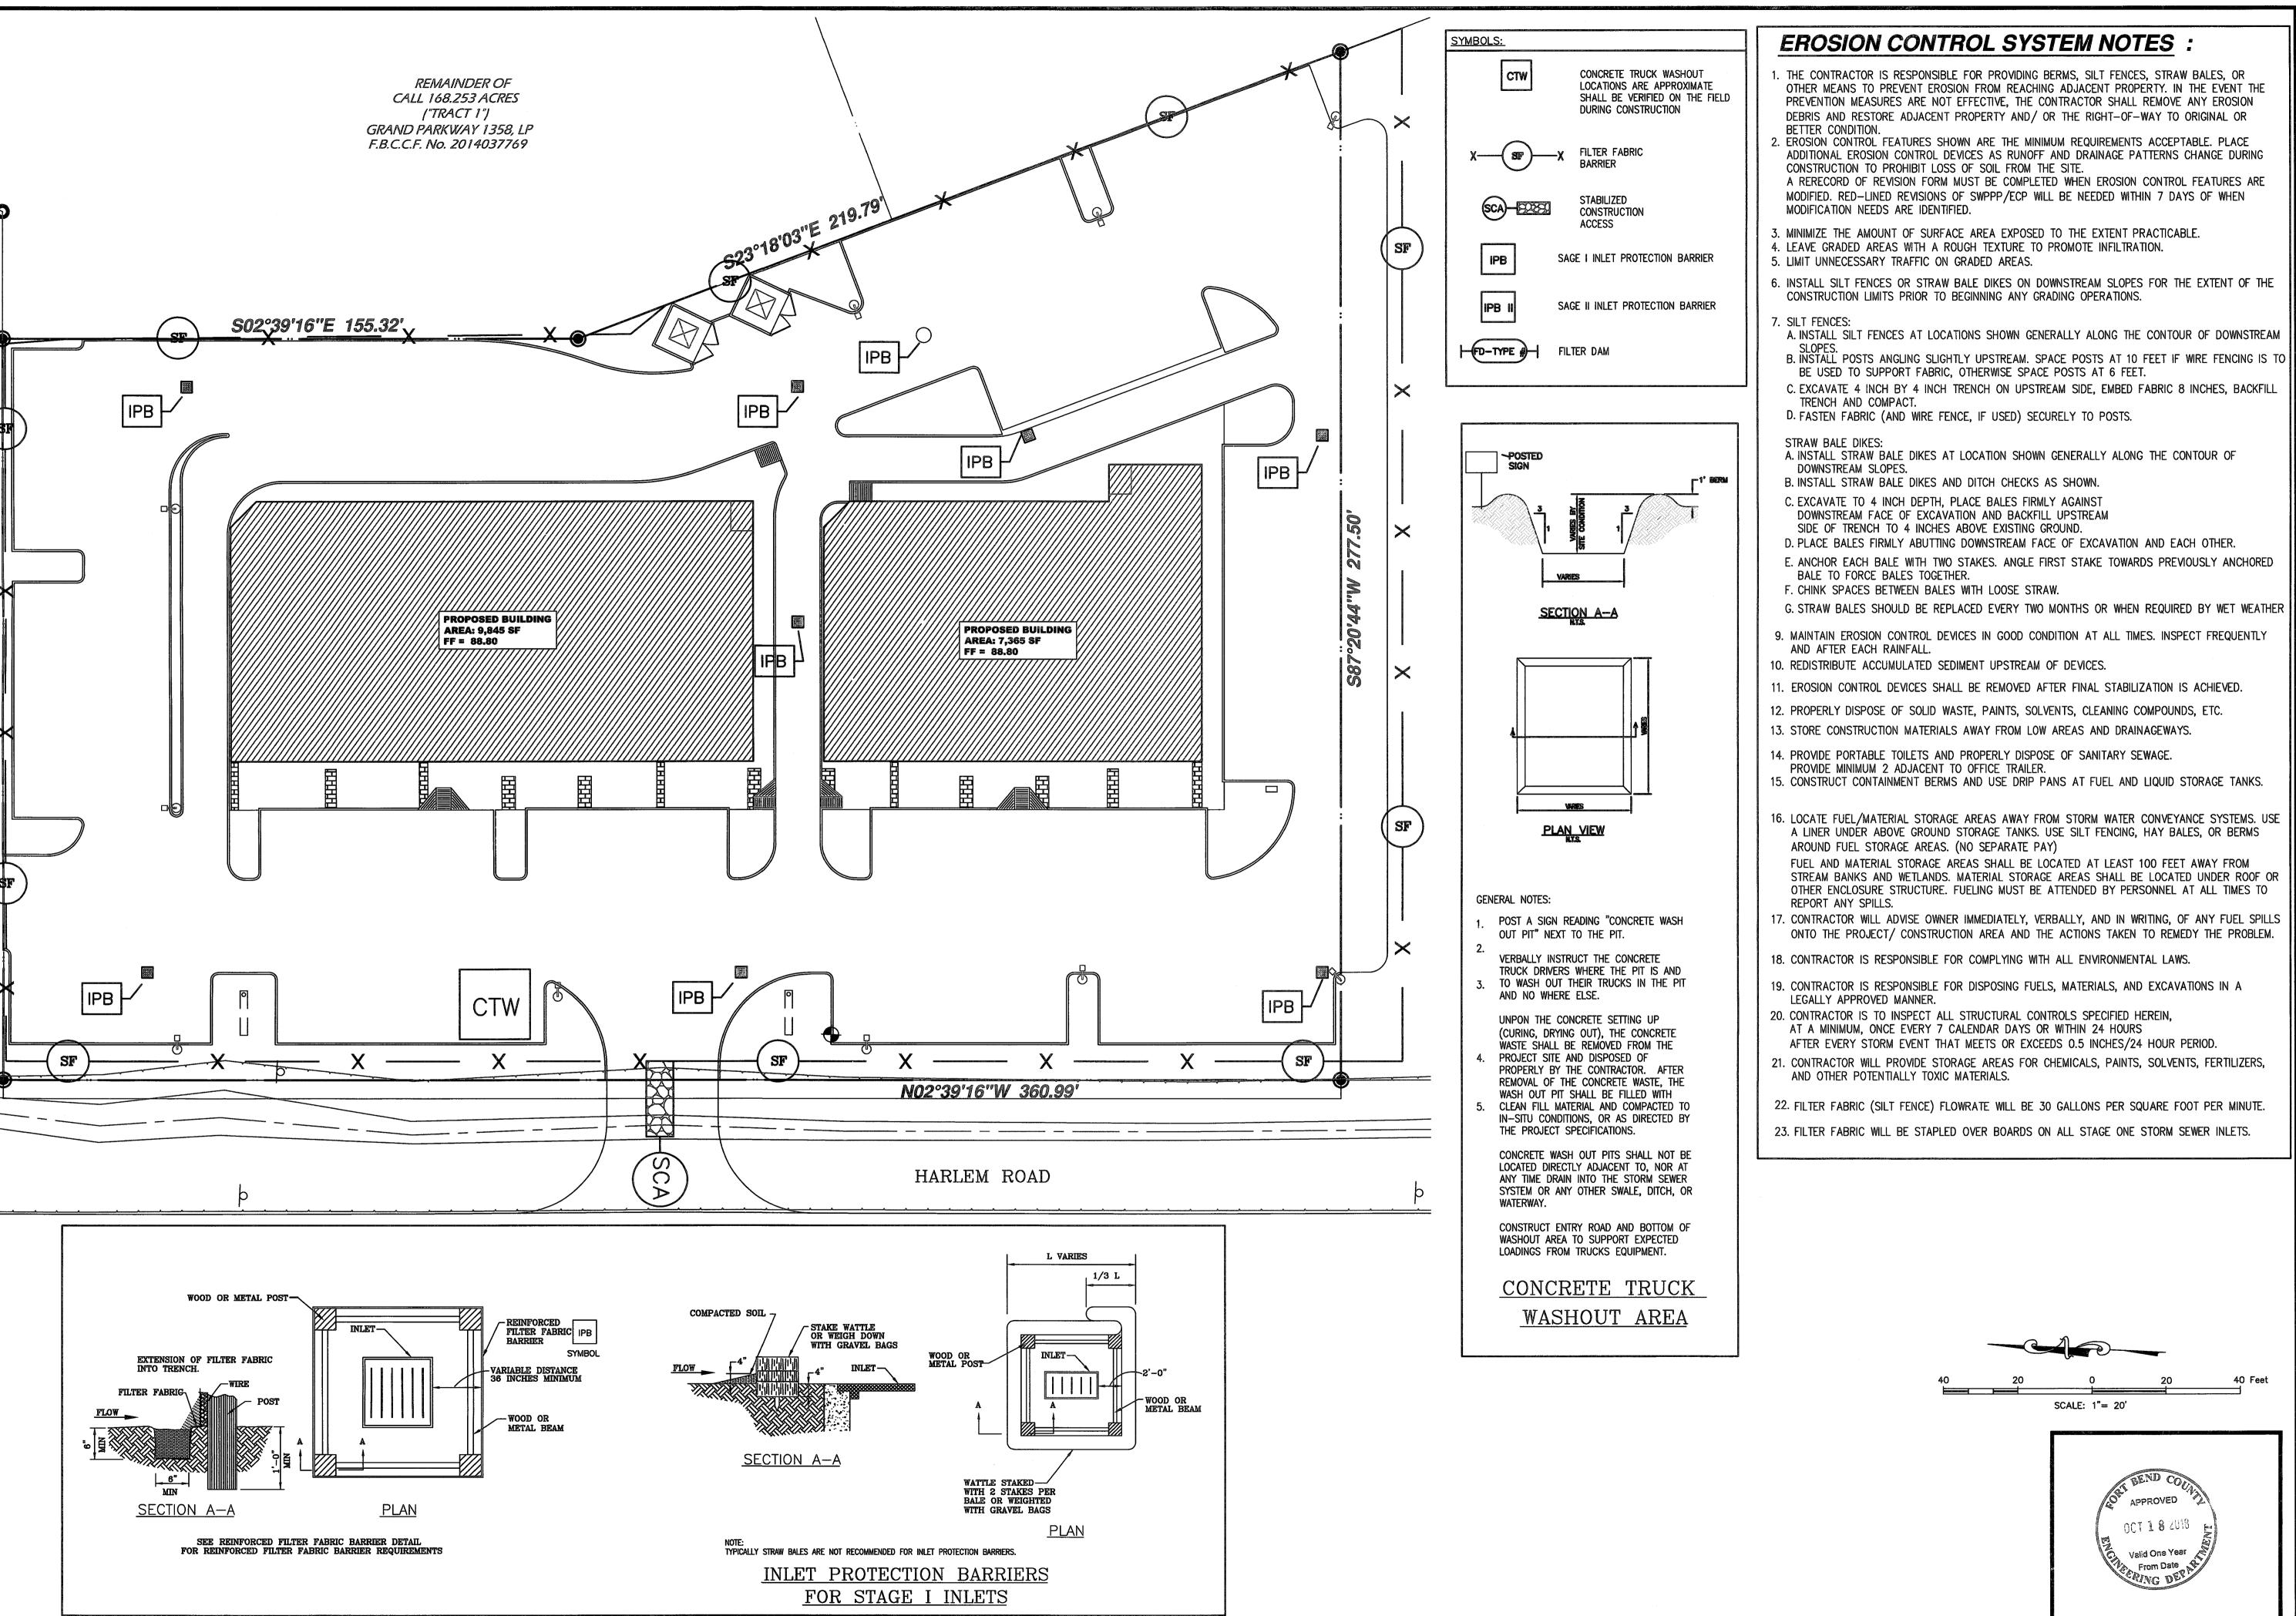



GENERAL NOTES: SITEWORK

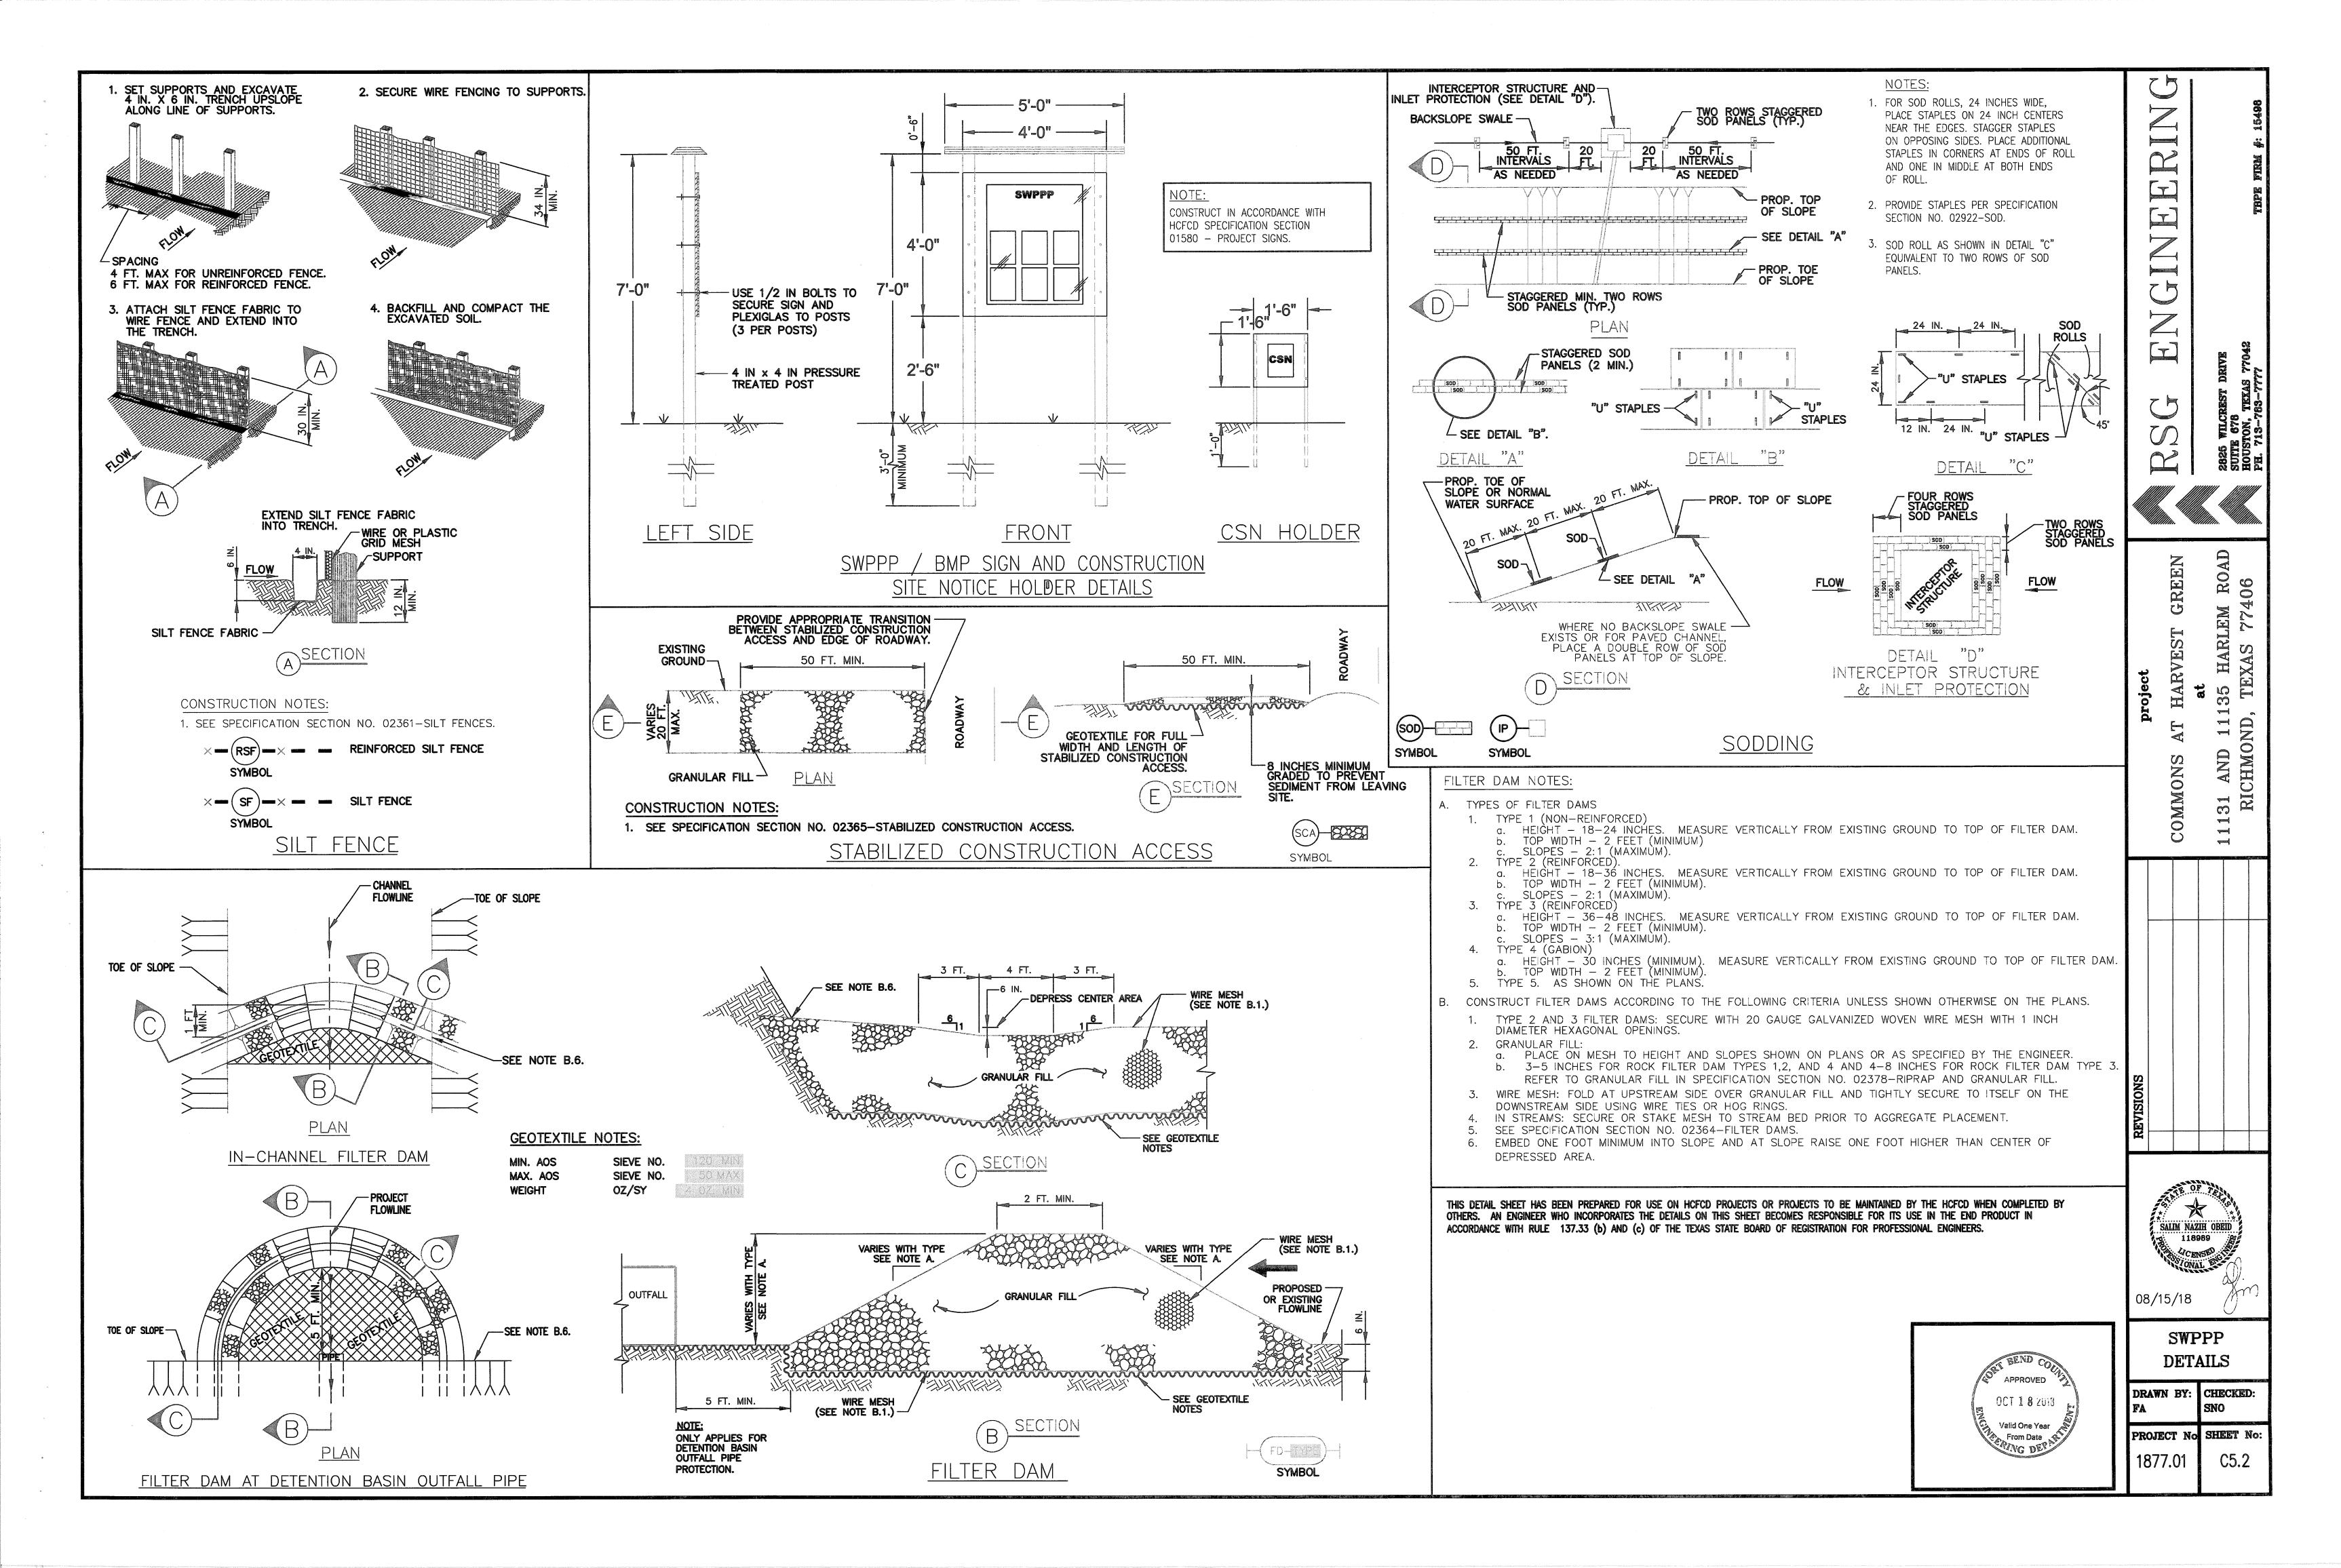(THESE NOTES CONTROL EXCEPT AS NOTED OTHERWISE IN PLANS & DETAILS)

- 1. CONTRACTOR SHALL FIELD VERIFY LOCATION AND ELEVATION OF ALL EXISTING UTILITIES PRIOR TO CONSTRUCTION OF PROPOSED FACILITIES. NOTIFY ENGINEER IMMEDIATELY OF ANY DISCREPANCIES.
- 2. CONTRACTOR SHALL NOTIFY THE APPROPRIATE UTILITY COMPANY 48 HOURS PRIOR TO EXCAVATING NEAR THEIR UTILITY.
- 3. CONTRACTOR SHALL TAKE ALL DUE PRECAUTIONS TO PROTECT EXISTING FACILITIES FROM DAMAGE. ANY DAMAGE TO EXISTING FACILITIES INCURRED AS A RESULT OF CONSTRUCTION OPERATIONS WILL BE REPAIRED BY THE CONTRACTOR AT HIS OWN EXPENSE.
- 4. CONTRACTOR SHALL TAKE EXTRA CARE TO PROTECT TREES IN AREAS ADJACENT TO CONSTRUCTION.
- **B. DOMESTIC WATER SYSTEM** 1. ALL WATER LINE MAINS SIZES 1 THRU 3 INCH SHALL BE PVC SCH 40.
- 2. ALL WATER MAINS SIZES 4 THRU 12 INCH SHALL BE AWWA C-900 CLASS
- 3. ALL WATER METERS SHALL BE FIRE RATED ACCORDING TO HARRIS COUNTY
- 4. WATER LINE SHALL BE CONSTRUCTED AND TESTED IN ACCORDANCE WITH HARRIS COUNTY SPECIFICATION FOR WATER MAIN CONSTRUCTION AS CURRENTLY AMENDED.
- 5. WATER LINE SHALL HAVE BANK SAND BEDDING AND BACKFILL.
- 6. PROVIDE THRUST BLOCKING ACCORDING TO HARRIS COUNTY STANDARDS & SPECIFICATIONS.
- 7. PROVIDE A MINIMUM 6-INCHES OF CLEARANCE AT STORM SEWER AND WATER LINE CROSSING.
- 1. POLY-VINYL-CHLORIDE PSM (PVC) PIPE SHALL CONFIRM TO ASTM SPECIFICATIONS D3034 AND BE INSTALLED ACCORDING TO ASTM D2321.
- 2. ALL SANITARY SEWER SERVICE LINES SHALL BE CONSTRUCTED TO TRUE
- ALIGNMENT AND GRADE. WRAPPED AND SAGGING LINES WILL NOT BE PERMITTED.
- BUILDING TIE-ON CONNECTION WILL BE MADE DIRECTLY TO THE STUB-OUT FROM THE BUILDING PLUMBING AT THE FOUNDATION ON ALL WASTES OUTLETS.
- 4. WATER-TIGHT ADAPTERS OF A TYPE COMPATIBLE WITH THE MATERIALS BEING JOINED WILL BE USED AT THE POINT OF CONNECTION OF THE SERVICE LINE TO THE BUILDING PLUMBING. NO CEMENT GROUT MATERIALS ARE PERMITTED.
- 5. NO BENDS OR TURNS AT ANY POINT WILL BE GREATER THAN 45 DEGREES.
- 6. EACH CLEANOUT WILL BE INSTALLED SO THAT IT OPENS IN A DIRECTION OPPOSITE TO THE FLOW OF THE WASTE AND, EXCEPT IN THE CASE OF "WYE" BRANCH AND END-OF-THE-LINE CLEANOUTS, CLEANOUTS WILL BE INSTALLED VERTICALLY ABOVE THE FLOW LINE OF THE PIPE.
- CLEANOUT WILL BE MADE WITH AIRTIGHT MECHANICAL PLUG.
- 8. THE PHYSICAL CONNECTION TO THE DISTRICT'S SEWER MAIN WILL BE MADE BY USE OF AN ADAPTER OF A TYPE COMPATIBLE WITH MATERIALS BEING JOINED. THE CONNECTION SHALL BE WATERTIGHT. NO CEMENT GROUT MATERIALS ARE PERMITTED.
- BACKFILLING OF SERVICE LINES TRENCH MUST BE ACCOMPLISHED WITHIN TWENTY-FOUR (24) HOURS OF INSPECTION AND APPROVAL. NO DEBRIS WILL BE PERMITTED IN THE TRENCH.
- 10. INLINE CLEAN OUTS SHALL BE INSTALLED AT EVERY 90' FEET.
- 11. ALL SANITARY SEWER LINES 6" OR SMALLER SHALL BE PVC SCHEDULE 40 PIPE SIZES 8" OR LARGER SHALL BE PVC SDR 35.
- 1. ALL WATER, SANITARY SEWER, STORM PIPING, GAS/ELECTRICAL SERVICES AND PAVING LOCATED IN THE COMMON AREA(S) ARE TO BE MAINTAINED BY THE IC MUD. (COMMON AREA: ALL AREAS OUTSIDE THE BUILDING FOOTPRINT ARE CONSIDERED COMMON AREA.)
- 2. OWNER/CONTRACTOR SHALL ALSO REFER TO GENERAL NOTES AND DETAILS.
- 3. OWNER/CONTRACTOR SHALL REFER TO ARCHITECTURAL SITE PLAN FOR ALL DIMENSIONS, PAD LOCATIONS AND ALL OTHER SITE RELATED ITEMS.
- 4. OVERHEAD AND UNDERGROUND UTILITIES MAY EXIST IN THE VICINITY OF THIS PROJECT. LOCATIONS SHOWN FOR EXISTING UTILITIES ARE APPROXIMATE AND OTHER UTILITIES MAY EXIST IN THE VICINITY OF THE PROJECT WHICH ARE NOT SHOWN ON THE PLANS. IT IS THE RESPONSIBILITY OF THE CONTRACTOR TO LOCATE ALL. EXISTING UTILITIES IN THE VICINITY OF THE PROJECT, PRIOR TO BEGINNING CONSTRUCTION. IF ANY DISCREPANCIES EXIST, NOTIFY ENGINEER IMMEDIATELY.
- 5. WHEN CONCRETE IS PLACED OVER AN EASEMENT A SAWCUT OR EXPANSION JOINT MUST BE PLACED AT THE EASEMENT LINE AND CROSS THE EASEMENT EVERY 10'.

LEGEND

PROPERTY LINE WASTEWATER 6" OR SMALLER-PVC SCH 40 8" OR LARGER-PVC SDR 35

FIRE HYDRANT (FH)

STORM SEWER MANHOLE

GATE VALVE EXIST.=FILLED PROP.=OPEN WASTEWATER MANHOLE EXIST.=FILLED PROP.=OPEN

c.o. > CLEAN-OUT c.o. 🕁 INLINE CLEAN OUT

WATER NOTES

- 2"X12" STANDARD CONNECTION
- 2 4'~2" DOMESTIC WATER LINE
- 3 2"X1½" TEE FITTING $3^{\circ} \sim 1\frac{1}{2}^{\circ}$ IRRIGATION WATER LINE
- 4 90° BEND
- 1'~12" IRRIGATION WATER LINE
- 6 5'~1½" IRRIGATION WATER LINE

13" IRRIGATION WATER METER

- 7 1½" REDUCED PRESSURE ZONE BACK FLOW PREVENTOR
- 8 PLUG WATER LINE

ASSEMBLY

- 9 2" DOMESTIC WATER METER ASSEMBLY
- 10 5'~2" DOMESTIC WATER LINE
- 11 2" REDUCED PRESURE ZONE BACK FLOW PREVENTOR
- 12 10'~2" DOMESTIC WATER LINE
- 13 11.25° BEND
- 14 46'~2" DOMESTIC WATER LINE
- 15 45° BEND
- 16 31'~2" DOMESTIC WATER LINE
- 17 TEE FITTING
- 18 3'~2" DOMESTIC WATER LINE PLUG WATER LINE. CONNECTION TO BUILDING BY MEP ENGINEER
- 19 14'~2" DOMESTIC WATER LINE PLUG WATER LINE. CONNECTION TO BUILDING BY MEP ENGINEER
- 20 90° BEND
- 21 75'~6" PVC C-900 DR-18 PIPE
- 22 96'~6" PVC C-900 DR-18 PIPE
- 23 7'~6" PVC C-900 DR-18 PIPE 90° BEND - VERTICAL BRING PIPELINE TO AN ELEVATION OF 89.00' AND PLUG FOR FUTURE USE
- 24 3'~6" PVC C-900 DR-18 PIPE 90° BEND - VERTICAL BRING PIPELINE TO AN ELEVATION OF

SCALE: 1"= 20'



BEND CO

APPROVED

Valid One Year

From Date

10/08/18


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GENERAL

 ALL WATER LINES, WASTEWATER COLLECTION SYSTEMS, PAVING, TRAFFIC SIGNALS AND DRAINAGE SYSTEMS SHALL BE CONSTRUCTED IN ACCORDANCE WITH CITY OF HOUSTON, DEPARTMENT OF PUBLIC WORKS AND ENGINEERING'S "STANDARD CONSTRUCTION SPECIFICATIONS (MOST RECENT ISSUE OCTOBER 2002) AND "STANDARD CONSTRUCTION DETAILS FOR WASTEWATER COLLECTION SYSTEMS, WATER LINES, STORM DRAINAGE AND STREET PAVING" (MOST RECENT ISSUE OCTOBER 2002) WITH ALL SUBSEQUENT AMENDMENTS ADDED THERETO UNLESS OTHERWISE NOTED AND APPROVED ON THESE PLANS. THE DESIGN MUST AGREE WITH THE MINIMUM STANDARDS ESTABLISHED IN THE LATEST ISSUE OF THE "INFRASTRUCTURE DESIGN MANUAL" (MOST RECENT ISSUE OCTOBER 2002) REVISED NOV 2008. NOTE THAT PLAN SIGNATURES AND LETTERS OF CAPACITY AVAILABILITY FOR STORM, WASTEWATER AND WATER EXPIRE AFTER ONE YEAR AND THAT THE LATEST EDITIONS OF DESIGN RULES, SPECIFICATIONS, STANDARD DETAILS AND MANUALS SHALL GOVERN AS OF THE DATES FOR RESIGNING.

2. THE CONTRACTOR SHALL BE FULLY RESPONSIBLE FOR ANY AND ALL DAMAGE TO EXISTING PUBLIC OR PRIVATE UTILITY LINES, INCLUDING BUT NOT LIMITED TO PAVING. WATER LINES. WASTEWATER COLLECTION SYSTEMS. STORM SEWER AND TRAFFIC SIGNALS DURING CONSTRUCTION. ALL DAMAGES SHALL BE REPAIRED IN ACCORDANCE WITH CURRENT EDITIONS OF CITY OF HOUSTON STANDARD CONSTRUCTION SPECIFICATIONS, DESIGN DETAILS AND DESIGN MANUALS. REPAIRS SHALL BE AT NO COST TO THE DISTRICT.

3. CONTRACTOR SHALL COMPLY WITH OCCUPATIONAL SAFETY AND HEALTH ADMINISTRATION STANDARDS AND ANY OTHER FEDERAL, STATE AND LOCAL REGULATIONS REGARDING TRENCH SAFETY SYSTEMS FOR TRENCH EXCAVATION.

4. ADEQUATE DRAINAGE SHALL BE MAINTAINED AT ALL TIMES DURING CONSTRUCTION AND ANY DRAINAGE DITCH OR STRUCTURE DISTURBED DURING CONSTRUCTION SHALL BE RESTORED TO THE SATISFACTION OF THE OWNING AUTHORITY. ALL CONSTRUCTION STORM RUNOFF SHALL COMPLY WITH THE FINAL DRAFT OF STORMWATER MANAGEMENT HANDBOOK FOR CONSTRUCTION ACTIVITIES AS PREPARED BY FORT BEND COUNTY/HCFCD, AND THE CITY OF HOUSTON, ALL IN COMPLIANCE WITH THE TEXAS POLLUTANT DISCHARGE ELIMINATION SYSTEM (TPDES) REQUIREMENTS.

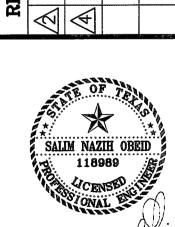5. CONDITION OF THE ROAD AND/OR RIGHT-OF-WAY, UPON COMPLETION OF JOB, SHALL BE AS GOOD OR BETTER THAN CONDITION PRIOR TO STARTING

6. THE EXISTENCE AND LOCATION OF ANY UNDERGROUND UTILITY PIPES OR STRUCTURES SHOWN ON THESE PLANS ARE OBTAINED BY A SEARCH OF AVAILABLE RECORDS. CONTRACTOR IS REQUIRED TO TAKE PRECAUTIONARY MEASURES TO PROTECT THE UTILITY LINE SHOWN AND ANY OTHER LINES NOT OF RECORD OR NOT SHOWN ON THESE DRAWINGS. EXISTING UTILITIES ARE LOCATED ON THE PLANS ONLY FOR THE CONVENIENCE OF THE CONTRACTOR. EXISTING UTILITY SERVICE LATERALS ARE NOT SHOWN ON THE PLANS AND CONTRACTOR IS ADVISED TO CALL THE APPLICABLE UTILITIES/AGENCIES BEFORE

THE CONTRACTOR SHALL TAKE ALL PRECAUTIONARY MEASURES NECESSARY TO PROTECT EXISTING IMPROVEMENTS WHICH ARE TO REMAIN IN PLACE FROM DAMAGE, AND ALL SUCH IMPROVEMENTS OR STRUCTURES DAMAGED BY CONTRACTOR'S OPERATIONS SHALL BE REPAIRED OR RECONSTRUCTED TO THE SATISFACTION OF THE ENGINEER AT THE EXPENSE OF THE CONTRACTOR.

8. THE CONTRACTOR IS TO FIELD VERIFY ALL EXISTING SITE CONDITIONS PRIOR TO CONSTRUCTION. IF A CONFLICT EXISTS BETWEEN WHAT IS SHOWN ON THESE PLANS AND WHAT EXISTS IN THE FIELD, CONTRACTOR IS TO NOTIFY THE ARCHITECT AND ENGINEER IMMEDIATELY. CONTRACTOR SHALL VERIFY THE INVERT AND/OR FLOW LINE ELEVATIONS OF POINTS OF CONNECTIONS PRIOR TO THE COMMENCEMENT OF WORK AND SHALL IMMEDIATELY REPORT ANY DEVIATIONS TO THE ENGINEER.

PRIVATE UTILITY NOTES

NOTICE

THE CONTRACTOR SHALL CONTACT THE UTILITY COORDINATING COMMITTEE AT 713-223-4567 OR TOLL FREE 1-800-344-8377 AND THE FORT BEND COUNTY MUNICIPAL UTILITY DISTRICT NO 189, A MINIMUM OF 48 HOURS PRIOR TO CONSTRUCTION TO HAVE UNDERGROUND LINES FIELD LOCATED.

CAUTION: <u>SBC CABLES</u>

THE LOCATION OF SBC FACILITIES ARE SHOWN IN AN APPROXIMATE WAY ONLY. THE CONTRACTOR SHALL DETERMINE THE EXACT LOCATION BEFORE COMMENCING WORK. HE AGREES TO BE FULLY RESPONSIBLE FOR ANY AND ALL DAMAGES WHICH MIGHT BE OCCASIONED BY THIS FAILURE TO EXACTLY LOCATE AND PRESERVE THESE UNDERGROUND UTILITIES.

WHEN EXCAVATING WITHIN EIGHTEEN INCHES (18") OF THE INDICATED LOCATION OF SBC FACILITIES, ALL EXCAVATIONS MUST BE ACCOMPLISHED USING NON-MECHANIZED EXCAVATION PROCEDURES. WHEN BORING THE CONTRACTOR SHALL EXPOSE THE SBC FACILITIES.

WHEN SBC FACILITIES ARE EXPOSED, THE CONTRACTOR WILL PROVIDE SUPPORT TO PREVENT DAMAGE TO THE CONDUIT DUCTS OR CABLES. WHEN EXCAVATING NEAR TELEPHONE POLES THE CONTRACTOR SHALL BRACE THE POLE FOR

CAUTION: UNDERGROUND GAS FACILITIES

LOCATION OF CENTERPOINT/ENTEX MAIN LINES (TO INCLUDE UNIT GAS TRANSMISSION AND/OR INDUSTRIAL GAS SUPPLY CORPORATION WHERE APPLICABLE) ARE SHOWN IN AN APPROXIMATE LOCATION ONLY. SERVICE LINES ARE USUALLY NOT SHOWN. THE CONTRACTOR SHALL CONTACT THE UTILITY COORDINATING COMMITTEE AT 223-4567 OR 1-800-669-8344 A MINIMUM OF 48 HOURS PRIOR TO CONSTRUCTION TO HAVE MAIN AND SERVICE LINES FIELD

WHEN CENTERPOINT/ENTEX PIPE LINE MARKINGS AR NOT VISIBLE. CALL 713-967-8037 (7:00 am to 4:30 pm) FOR STATUS OF LINE LOCATION REQUEST BEFORE EXCAVATION BEGINS.

WHEN EXCAVATION WITHIN EIGHTEEN INCHES (18") OF THE INDICATED LOCATION OF CENTERPOINT/ENTEX FACILITIES, ALL EXCAVATION MUST BE ACCOMPLISHED USING NON-MECHANIZED EXCAVATION PROCEDURES.

WHEN CENTERPOINT/ENTEX FACILITIES ARE EXPOSED SUFFICIENT SUPPORT MUST BE PROVIDED TO THE FACILITIES TO PREVENT EXCESSIVE STRESS ON THE

THE CONTRACTOR IS FULLY RESPONSIBLE FOR ANY DAMAGES CAUSED BY HIS FAILURE TO EXACTLY LOCATE AND PRESERVE THESE UNDERGROUND FACILITIES.

ANY UTILITY OUTAGES CAUSED BY CONTRACTOR SHALL BE RESTORED WITHIN 4 HOURS OF NOTICE BY TENANT OR OWNER.

CAUTION: OVERHEAD POWER LINES

OVERHEAD LINES EXIST ON THE PROPERTY. WE HAVE NOT ATTEMPTED TO MARK THOSE LINES SINCE THEY ARE CLEARLY VISIBLE, BUT YOU SHOULD LOCATE THEM PRIOR TO BEGINNING ANY CONSTRUCTION. TEXAS LAW, SECTION 752, HEALTH AND SAFETY CODE, FORBIDS ALL ACTIVITIES IN WHICH PERSONS OR THINGS MAY COME WITHIN SIX (6) FEET OF LIVE OVERHEAD HIGH VOLTAGE LINES. PARTIES RESPONSIBLE FOR THE WORK, INCLUDING CONTRACTORS, ARE LEGALLY RESPONSIBLE FOR THE SAFETY OF CONSTRUCTION WORKERS UNDER THIS LAW. THIS LAW CARRIES BOTH CRIMINAL AND CIVIL LIABILITY. TO ARRANGE FOR LINES TO BE TURNED OFF OR REMOVED, CALL RELIANT ENERGY/HL&P AT 713-207-7777.

CONTRACTOR TO NOTIFY THE "UNDERGROUND UTILITY COORDINATING COMMITTEE" (TELEPHONE: 713-223-4567) AND CITY OF HOUSTON DEPARTMENT OF PUBLIC WORKS (TELEPHONE: 713-754-0767) 48 HOURS BEFORE STARTING WORK IN STREET RIGHT-OF-WAY OR EASEMENTS.

CONTRACTOR TO NOTIFY THE MUD OPERATOR AND IS RESPONSIBLE FOR SCHEDULING AND COORDINATING ALL NECESSARY INSPECTIONS, REVIEWS OF WORK AND APPROVAL

PAVING

1. GUIDELINES SET FORTH IN THE TXDOT MANUAL ON UNIFORM TRAFFIC CONTROL DEVICES SHALL BE OBSERVED.

2. EXISTING PAVEMENTS, CURBS, SIDEWALKS AND DRIVEWAYS DAMAGED OR REMOVED DURING CONSTRUCTION SHALL BE REPLACED TO FORT BEND COUNTY STANDARDS WITH LATEST ADDENDA AND AMENDMENTS THERETO.

3. PAVING CONSTRUCTION SHALL BE IN ACCORDANCE WITH CITY OF HOUSTON "STANDARD CONSTRUCTION SPECIFICATIONS" DATED OCTOBER, 2002 AND ALL APPLICABLE AMENDMENTS AND REVISIONS THERETO.

4. CONTRACTOR SHALL BLOCK OUT (SQUARE) AROUND ALL INLETS AND MANHOLES IN PROPOSED PAVING AS SHOWN ON TYPE "A" INLET AND TYPE "C" MANHOLE DETAILS.

5. EXPANSION JOINT SHALL BE PLACED AT THE END OF EACH CURB RETURN AND A MAXIMUM 60' SPACING.

7. CONTRACTOR SHALL CONSULT THE SOILS REPORT PREPARED BY THE MURILLO COMPANY, SEPTEMBER 2012, REPORT NO. GOE30112, ENTITLED GEOTECHNICAL INVESTIGATION, DISCOVERY AT VINTAGE PARK APARTMENTS, FORT BEND COUNTY, TEXAS.

6. PROPOSED DRIVEWAYS TO BE CONSTRUCTED PER FORT BEND COUNTY

8. CONTRACTOR SHALL SUBMIT JOINT PLAN TO ENGINEER FOR APPROVAL.

STORM SEWERS

DRIVEWAY DETAIL.

1. STORM SEWER PIPE USED FOR CONNECTION TO STORM SEWER IN PUBLIC RIGHT-OF-WAY SHALL BE REINFORCED CONCRETE PIPE ASTM C-76, CLASS III, AND SHALL EXTEND TO FIRST INLET OR MANHOLE. ALL OTHER PRIVATE STORM SEWERS SHALL BE HDPE AND BEDDED PER CITY OF HOUSTON STANDARDS. PIPE GRADES ARE BASED ON CONCRETE PIPE TO PRODUCE THREE (3) FPS

2. STORM SEWERS SHALL BE INSTALLED, BEDDED, AND BACKFILLED IN ACCORDANCE WITH CITY OF HOUSTON DRAWINGS NOS. 02317-02, 02317-03, 02317-05, 02317-06, 02317-07, & 02081-07 AS APPLICABLE UNLESS OTHERWISE SHOWN ON DRAWINGS.

3. STORM SEWERS SHALL BE CONSTRUCTED IN ACCORDANCE WITH CITY OF HOUSTON "STANDARD CONSTRUCTION SPECIFICATIONS" OCTOBER, 2002 ISSUE, AS CURRENTLY AMENDED.

4. ALL SEWERS UNDER PROPOSED OR FUTURE PAVEMENT AND TO A POINT ONE (1) FOOT BACK OF ALL PROPOSED OR FUTURE CURBS SHALL BE BACKFILLED WITH 1 1/2 SACK CEMENT/C.Y. STABILIZED SAND TO WITHIN ONE (1) FOOT OF SUBGRADE. THE REMAINING DEPTH OF TRENCH SHALL BE BACKFILLED WITH SUITABLE EARTH MATERIAL IN 8 INCH LIFTS, WITH TESTS TAKEN AT 100 FOOT INTERVALS ON EACH LIFT, AND MECHANICALLY COMPACTED TO A DENSITY OF NOT LESS THAN 95% OF OF THE MAXIMUM DRY DENSITY AS DETERMINED BY THE STANDARD PROCTOR COMPACTION TEST (ASTM DESIGNATION D-698/AASHTO T99). MOISTURE CONTENT OF BACKFILL SHALL BE IN ACCORDANCE WITH THE REQUIREMENTS OF THE CEMENT- STABILIZED SAND SPECIFICATION ASTM C33, LATEST EDITION.

5. CONCRETE PIPE SHALL BE INSTALLED USING RUBBER GASKET JOINTS ONLY CONFORMING TO ASTM C443.

6. "STM.S.E." INDICATES "STORM SEWER EASEMENT."

7. ALL PROPOSED PIPE STUB-OUTS FROM MANHOLES OR INLETS ARE TO BE PLUGGED WITH 8" BRICK WALLS UNLESS OTHERWISE NOTED.

SANITARY SEWERS

1. ALL SEWERS SHALL BE CONSTRUCTED IN ACCORDANCE WITH CITY OF HOUSTON "STANDARD CONSTRUCTION SPECIFICATION FOR WASTEWATER COLLECTION SYSTEMS, WATER LINES, STORM DRAINAGE AND STREET PAVING" OCTOBER, 2002 ISSUE AND ALL CURRENT AMENDMENTS THERETO AND BE SUBJECT TO A STANDARD EXFILTRATION TEST. TESTS ARE TO BE PERFORMED ON THE TOTAL FOOTAGE OF SEWER LINE INCLUDED IN THE PROJECT. REQUIREMENTS OF TEXAS ADMINISTRATIVE CODE. TITLE 30 CHAPTER 317, "DESIGN CRITERIA FOR SEWERAGE SYSTEMS" SHALL GOVERN WHERE CONFLICTS EXIST EXCEPT WHERE CITY REQUIREMENTS ARE OF HIGHER STANDARDS.

2. SANITARY SEWER PIPE TO BE SDR 26 P.V.C. PIPE MEETING ASTM SPECIFICATION D2241 WITH RUBBER GASKET JOINTS, UNLESS OTHERWISE NOTED.

3. SANITARY SEWERS MANHOLES WILL HAVE BEDDING AND BACKFILL PER CITY OF HOUSTON STANDARDS UNLESS OTHERWISE NOTED.

4. ALL SANITARY SEWER LINES UNDER PROPOSED OR FUTURE PAVEMENT AND TO A POINT ONE (1) FOOT BACK OF ALL PROPOSED OR FUTURE CURBS SHALL HAVE BEDDING PER CITY OF HOUSTON STANDARDS AS APPLICABLE, WITH 1 1/2 SACK CEMENT/C.Y. STABILIZED SAND BACKFILL UP TO THE BOTTOM OF THE PAVEMENT SUBGRADE. 100 PSI PERFORMANCE RESULTS ARE STILL REQUIRED.

5. ALL MANHOLES ARE TO BE PER CITY OF HOUSTON STANDARDS.

6. ALL SANITARY SEWERS CROSSING WATER LINES WITH A CLEARANCE BETWEEN 6 INCHES AND 9 FEET SHALL HAVE A MINIMUM OF ONE 18' JOINT OF 150 P.S.I. DUCTILE IRON OR C900 PVC PIPE MEETING ASTM SPECIFICATION D2241 CENTERED ON WATER LINE. WHEN WATER LINE IS BELOW SANITARY SEWER PROVIDE MINIMUM 2 FOOT SEPARATION.

7. CONTRACTOR SHALL PROVIDE FOR A MINIMUM HORIZONTAL CLEARANCE OF 9' FEET BETWEEN WATER LINES AND SANITARY SEWER MANHOLES AND LINES.

8. SANITARY SEWER MANHOLE RIMS OUTSIDE OF PROPOSED PAVING WILL BE SET 3"- 6" ABOVE THE SURROUNDING LEVEL FINISHED GRADE AFTER PAVING WITH SLOPED BACKFILL ADDED FOR STORMWATER DRAINAGE AWAY FROM MANHOLE RIM.

9. "SAN. S. E." INDICATES "SANITARY SEWER EASEMENT"

10. IN WET STABLE TRENCH AREAS USE BEDDING PER CITY OF HOUSTON

11. ALL SDR P.V.C. PIPE IS TO HAVE D.I.P. SIZE O.D. AND RUBBER GASKET BELL-AND- SPIGOT TYPE JOINT ENDS.

12. SDR 26 P.V.C. PIPE USES "FULL BODIED" SDR 26 P.V.C. FITTINGS WITH APPROPRIATE ADAPTERS. AWWA C-900 DR-18 P.V.C. PIPE USES EITHER AWWA C900 DR-18 P.V.C. FITTINGS OR D.I.P. FITTINGS. SDR-26 P.V.C. PIPE SHALL HAVE A CELL CLASSIFICATION OF 12364-B AS DEFINED IN ASTM

13. DEFLECTION TEST: DEFLECTION TESTS SHALL BE PERFORMED ON ALL FLEXIBLE AND SEMI-RIGID SEWER PIPE. THE TEST SHALL BE CONDUCTED AFTER THE FINAL BACKFILL HAS BEEN IN PLACE AT LEAST 30 DAYS. NO PIPE SHALL EXCEED A DEFLECTION OF 5%. IF THE DEFLECTION TEST IS TO BE RUN USING A RIGID MANDREL, IT SHALL HAVE A DIAMETER EQUAL TO 95% OF THE INSIDE DIAMETER OF THE PIPE. THE TEST SHALL BE PERFORMED AS PER 30 TAC 317.2 LATEST AMENDMENT AND WITHOUT MECHANICAL PULLING DEVICES.

14. INFILTRATION. EXFILTRATION OR LOW-PRESSURE AIR TEST: EITHER OF THE FOLLOWING TESTS SHALL BE PERFORMED AS PER TAC, TITLE 30 317.2 WITHIN THE SPECIFIED TOLERANCES ON ALL GRAVITY SEWERS. A. INFILTRATION OR EXFILTRATION TEST: TOTAL LEAKAGE AS DETERMINED BY A HYDROSTATIC HEAD TEST SHALL NOT EXCEED 50 GALLONS PER INCH DIAMETER PER MILE OF PIPE PER 24 HOURS AT A MINIMUM TEST HEAD OF

B. LOW-PRESSURE AIR TEST: PERFORM TEST ACCORDING TO UNI-B-6-90 OR OTHER APPROPRIATE PROCEDURES. FOR SECTIONS OF PIPE LESS THAN 36"(INCH) AVERAGE INSIDE DIAMETER, THE MINIMUM ALLOWABLE TIME FOR PRESSURE DROP FROM 3.5 PSIG TO 2.5 PSIG SHALL BE AS FOLLOWS:

6" 340 SECONDS OR 0.855(L) FOR TEST LENGTHS GREATER THAN 398' 8" 454 SECONDS OR 1.520(L) FOR TEST LENGTHS GREATER THAN 298' 10" 567 SECONDS OR 2.374(L) FOR TEST LENGTHS GREATER THAN 239'

15" 850 SECONDS OR 5.342(L) FOR TEST LENGTHS GREATER THAN 159' 18" 1020 SECONDS OR 7.693(L) FOR TEST LENGTHS GREATER THAN 133'

WHERE L = LENGTH OF LINE OF SAME PIPE SIZE IN FEET.

12" 680 SECONDS OR 3.419(L) FOR TEST LENGTHS GREATER THAN 199'

BACKFILL/COMPACTION OF FILL

1. ALL GRADING/BACKFILL/COMPACTION SHALL BE IN ACCORDANCE WITH THE SOILS REPORT AND ANY ADDENDUMS THERETO AS PREPARED BY THE MURILLO COMPANY, SEPTEMBER 2012, REPORT NO. GOE30112, ENTITLED GEOTECHNICAL INVESTIGATION, DISCOVERY AT VINTAGE PARK APARTMENTS, FORT BEND COUNTY, TEXAS,

2. ALL AREAS TO BE FILLED ARE TO BE FREE OF VEGETATION, DEBRIS, PONDING WATER, LOOSE SOILS, MUD & MUCK (STRIP 4").

3. ALL FILL OR DISPOSAL OF EXCESS MATERIAL SHALL BE COMPACTED IN 8" LIFTS, 95% STANDARD PROCTOR DENSITY.

4. THE BUILDING AND PAVEMENT AREAS SHOULD BE STRIPPED OF ANY REMAINING TREES AND STUMPS, VEGETATION, ORGANICS, LOOSE TOPSOIL, AND/OR OTHER DEBRIS. CARE SHOULD BE TAKEN TO REPLACE OR RECOMPACT ALL SOIL REMOVED OR LOOSENED BY REMOVAL OF TREE ROOTS AND STUMPS. THE LOOSENED SOILS SHOULD BE MOISTURE CONDITIONED IF NECESSARY AND COMPACTED TO AT LEAST 95 PERCENT MAXIMUM DRY DENSITY TO WITHIN 1% DRY TO 3% WET OF THE OPTIMUM MOISTURE CONTENT AS OUTLINED BELOW.

5. FOLLOWING A PERIOD OF RAIN. THE MOISTURE SENSITIVE SILTY SAND SUBGRADE WILL BE OBVIOUSLY WEAK AND NOT CAPABLE OF SUPPORTING CONSTRUCTION EQUIPMENT. THE SOIL WILL THEN REQUIRE IMPROVEMENT AS OUTLINED IN THE GEOTECHICAL REPORT. IF THE SUBGRADE IS REASONABLY DRY AND STABLE, THE EXPOSED SOIL SUBGRADE AREA SHOULD BE PROOF ROLLED TO DETECT WEAK AREAS ONCE FINAL SUBGRADE ELEVATIONS HAVE BEEN ACHIEVED THROUGHOUT THE SITE. WEAK AREAS DETECTED DURING PROOF ROLLING, AS WELL AS ZONES OF DEBRIS AND ORGANICS SHOULD BE REMOVED AND REPLACED WITH SOILS EXHIBITING SIMILAR CLASSIFICATION, MOISTURE CONTENT, AND DENSITY AS THE ADJACENT IN-SITU SOILS, SUBSEQUENT TO PROOF ROLLING AND JUST PRIOR TO PLACEMENT OF FILL. THE EXPOSED SUBGRADE SHOULD BE MOISTURE CONDITIONED AND COMPACTED TO AT LEAST 95 PERCENT OF THE MAXIMUM DENSITY (ASTM D 698) AT 1% DRY TO 3% WET OF THE OPTIMUM MOISTURE CONTENT. THE PURPOSE IS TO PROVIDE SUPPORT FOR COMPACTION OF THE INITIAL FILL LIFT IN THE BUILDING AREA OR FOR CHEMICAL STABILIZATION IN THE PAVEMENT AREAS. FOR WET WEATHER CONSIDERATIONS, SEE GEOTECH REPORT.

6. GRADE ADJUSTMENTS WITHIN THE BUILDING LIMITS SHOULD BE ACCOMPLISHED WITH SELECT, STRUCTURAL FILL COMPOSED OF CLEAN, INACTIVE SANDY CLAY (NOT A SILT) WITH A PLASTICITY INDEX RANGING BETWEEN 10 AND 20. ALL FILL SHOULD BE FREE OF ORGANIC AND DEBRIS. ALL STRUCTURAL FILL SHOULD BE PLACED ON REPAIRED SURFACES IN LIFTS NOT TO EXCEED EIGHT INCHES LOOSE MEASURE, WITH COMPACTED THICKNESS NOT TO EXCEED SIX INCHES. ALL FILL SHOULD BE COMPACTED TO AT LEAST 95 PERCENT (ASTM D 698) MAXIMUM DRY DENSITY AT AT MOISTURE CONTENT WITHIN 1% DRY TO 3% WET OF OPTIMUM MOISTURE CONTENT.

WATERLINE CONSTRUCTION NOTES:

1. WATER MAINS SHALL BE CONSTRUCTED IN ACCORDANCE WITH CITY OF HOUSTON, DEPARTMENT OF PUBLIC WORKS AND ENGINEERING STANDARD CONSTRUCTION SPECIFICATIONS DATED OCTOBER 2002 WITH LATEST ADDENDA AND AMENDMENTS THERETO.

2. 4" THRU 12" WATER LINES SHALL BE AWWA C-900 AND 1" THRU 3" WATER LINES SHALL BE SCHEDULE 40 PVC.

3. ALL WATER LINES SHALL BE BEDDED AND BACKFILLED IN ACCORDANCE WITH CITY OF HOUSTON WATER DWG. NO. 02317-04.

ONE (1) FOOT BACK OF ALL PROPOSED OR FUTURE CURBS SHALL BE ENCASED IN BANK SAND TO 12" OVER PIPE AND BACKFILLED WITH BANK SAND TO THE BOTTOM OF THE PAVEMENT SUBGRADE.

5. CONTRACTOR SHALL PROVIDE FOR A MINIMUM HORIZONTAL CLEARANCE OF 9' (NINE FEET) BETWEEN WATER LINES AND SANITARY SEWER MANHOLES AND

4. ALL WATER LINES UNDER PROPOSED OR FUTURE PAVING AND TO A POINT

6. "W.L.E." INDICATES "WATER LINE EASEMENT"

7. ALL WATER LINES TO BE DISINFECTED IN CONFORMANCE WITH AWWA C-651. A MINIMUM OF ONE BACTERIOLOGICAL SAMPLE SHALL BE COLLECTED FOR EACH 1.000 FEET OF COMPLETED WATER LINE, OR FRACTION THEREOF, TO CHECK EFFICIENCY OF DISINFECTION PROCEDURES AND SHALL BE REPEATED IF CONTAMINATION PERSISTS.

8. ALL WATER PIPE AND RELATED PRODUCTS MUST CONFORM TO ANSI/NSF

9. 4" THRU 12" FITTINGS SHALL BE CEMENT MORTAR LINED COMPACT DUCTILE IRON PRESSURE FITTINGS PER ANSI A21.53 OR PUSH ON FITTINGS PER ANSI A21.10 PRESSURE RATED AT 250 PSIG CONFORMING TO THE REQUIREMENTS OF CITY OF HOUSTON STANDARD SPECIFICATION SECTION 02501-DUCTILE IRON PIPE AND FITTINGS.

10. HYDROSTATIC TESTING: ALL WATER PIPE SHALL BE TESTED FOR LEAKAGE IN ACCORDANCE WITH AWWA STANDARDS. LEAKAGE SHALL BE DEFINED AS THE QUANTITY OF WATER THAT MUST BE SUPPLIED INTO THE NEWLY LAID PIPE OR ANY VALVED SECTION THEREOF, TO MAINTAIN PRESSURE WITHIN 5 PSI OF THE SPECIFIED TEST PRESSURE AFTER THE PIPE HAS BEEN FILLED WITH WATER AND THE AIR HAS BEEN EXPELLED. THE TEST PRESSURE SHALL BE EITHER A MINIMUM OF 125 PSIG OR 1.5 TIMES THE MAXIMUM DESIGN PRESSURE WHICHEVER IS LARGER. THE MAXIMUM LEAKAGE SHALL BE CALCULATED USING THE FORMULA AS FOLLOWS:

WHERE $L = (S)(D)(P^1/2)/133,200$

L = ALLOWABLE LEAKAGE IN GAL./HR

S = LENGTH OF PIPE TESTED IN FEET

D = INSIDE DIAMETER OF PIPE IN INCHES S P = PRESSURE IN POUNDS PER SQUARE INCH (GAUGE)

11. ALL WATER LINES TO HAVE 4' MINIMUM COVER TO FINISHED GRADE AND MINIMUM 12" CLEAR TO OTHER UTILITIES AT CROSSINGS UNLESS OTHERWISE NOTED ON PLANS.

12. ALL FLANGES BELOW GRADE SHALL BE INSULATED.

13. ALL WATERLINES SHALL BE ENCASED IN BANK SAND AT LEAST 12" ABOVE THE PIPE. COST OF BANK SAND TO BE INCLUDED IN THE UNIT PRICE OF WATERLINE

14. CENTER OF FIRE HYDRANT TO BE LOCATED 3'-0" FROM BACK OF CURB. 15. UTILITY CONTRACTOR TO TURN FIRE HYDRANTS AND MAKE ALL FINAL ADJUSTMENTS AFTER COMPLETION OF PAVING. NO SEPARATE PAY.

16. SANITARY PRECAUTIONS MUST BE TAKEN DURING WATER LINE CONSTRUCTION, AS CALLED FOR BY AWWA STANDARDS. PRECAUTIONS INCLUDE KEEPING PIPE CLEAN AND CAPPING OR OTHERWISE EFFECTIVELY SEALING OPEN PIPE ENDS TO EXCLUDE INSECTS, ANIMALS OR OTHER SOURCES OF CONTAMINATION FROM UNFINISHED PIPE LINES AT TIMES WHEN CONSTRUCTION

STORM WATER QUALITY PRE-CONSTRUCTION **INSPECTION REQUIREMENTS**

THE CONTRACTOR SHALL CONTACT THE FORT BEND COUNTY STORM WATER QUALITY PERMITTING SECTION AT 713-956-3000 FOR A PRE-CONSTRUCTION INSPECTION PRIOR TO COMMENCING ANY CLEARING OR CONSTRUCTION ACTIVITIES ON THE SITE.

FORT BEND COUNTY NOTES

. CONTRACTOR TO OBTAIN ALL PERMITS REQUIRED BY THE "REGULATIONS OF FORT BEND COUNTY, TEXAS FOR FOR FLOOD PLAIN MANAGEMENT" PRIOR TO STARTING CONSTRUCTION.

2. OWNER TO OBTAIN ALL PERMITS REQUIRED BY FORT BEND COUNTY, TEXAS PRIOR TO STARTING CONSTRUCTION OF UTILITIES AND/OR CULVERTS WITHIN FORT BEND COUNTY ROAD RIGHTS-OF-WAY.

3. PAVING SHALL BE IN ACCORDANCE WITH THE "REGULATIONS OF FORT BEND COUNTY, TEXAS FOR THE APPROVAL AND ACCEPTANCE OF INFRASTRUCTURE" AND/OR AMENDMENTS OF SAME.

4. AUTHORIZATION NOTICE ISSUED BY FORT BEND COUNTY PUBLIC INFRASTRUCTURE DEPARTMENT - ENGINEERING DIVISION - PERMIT OFFICE -REQUIRED PRIOR TO CONSTRUCTION OF UTILITIES OR LEFT TURN LANES WITHIN FORT BEND COUNTY RIGHTS-OF-WAY. CONTACT FORT BEND COUNTY PERMIT OFFICE (713) 274-3731.

MUD NOTES:

CONTACT CAMERON MILLER, PE (JONES AND CARTER, INC.) AT 832-813-4032 AND LARRY KELLER (ST ENVIRONMENTAL) AT 281-732-6614, 48 HOURS PRIOR TO COMMENCING CONSTRUCTION.



Fort Bend County Construction - General Notes

Fort Bend County must be invited to the Pre-Construction Meeting.

2. Contractor shall notify Fort Bend County Engineering Department 48 hours prior to commencing construction and 48 hour notice to any construction activity within the limits of the paving at Construction@fortbendcountytx.gov.

3. Contractor is responsible for obtaining all permits required from Fort Bend County prior to commencing construction of any improvements within County road right of ways.

4. All Paving Improvements shall be constructed in accordance with Fort Bend County "Rules, Regulations and Requirements" relating to the Approval and Acceptance of Improvements in Subdivisions as currently amended.

5. All road widths, curb radii and curb alignment shown indicates back of curb

6. A continuous longitudinal reinforcing bar shall be used in the curbs.

7. All concrete pavement shall be 5 % sack cement with a minimum compressive strength of 3500 psi at 28 days. Transverse expansion joints shall be installed at each curb return and at a maximum spacing of 60 feet.

All weather access to all existing streets and driveways shall be maintained at all times.

9. 4"x 12" reinforced concrete curb shall be placed in front of single family lots only. All other areas shall be 6" reinforced concrete curb.

10. At all intersection locations, Type 7 ramps shall be place in accordance with TXDOT Ped-12a standard detail sheet. A.D.A. - Handicap Ramps shall be installed with street paving at all Intersections and comply with current A.D.A.

11. Curb headers are required at curb connections to Handicap Ramps, with no construction joint within 5' of ramps.

12. All intersections utilizing Traffic Control measures shall have A.D.A. wheel chair ramps installed.

13. Guidelines are set forth in the Texas "Manual on Uniform Traffic Control Devices", as currently amended, shall be observed. The Contractor shall be responsible for providing adequate flagmen, signing, striping and warning


devices, etc., during construction - both day and night. 14. All R1-1 stop signs shall be 30"x30" with diamond grade sheeting per Texas manual on uniform traffic control

15. Street name signage shall be on a 9" high sign flat blade w/reflective green background. Street names shall be upper and lowercase lettering with uppercase letters of 6" minimum and lowercase letters of 4.5" minimum. The letters shall be reflective white. Street name signs shall be mounted on stop sign post.


16. A Blue Double Reflectorized button shall be placed at all Fire Hydrant locations. The Button shall be placed 12 inches off of the centerline of the street on the same side as the hydrant.

17. The project and all parts thereof shall be subject to inspection from time to time by inspectors designated by Fort Bend County. No such inspections shall relieve the Contractor of any of its obligations hereunder. Neither failure to inspect nor failure to discover or reject any of the work as not in accordance with the drawings and specifications, requirements and specifications of Fort Bend County or any provision of this project shall be construed to imply an acceptance of such work or to relieve the Contractor of any of its obligations hereunder.

NOTE: Fort Bend County notes supersede any conflicting notes.

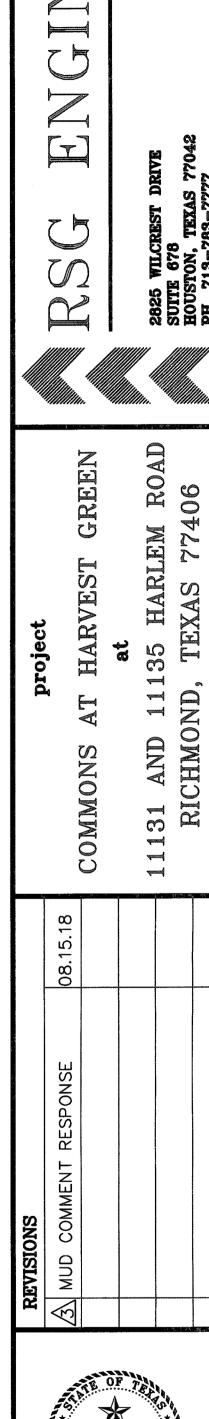


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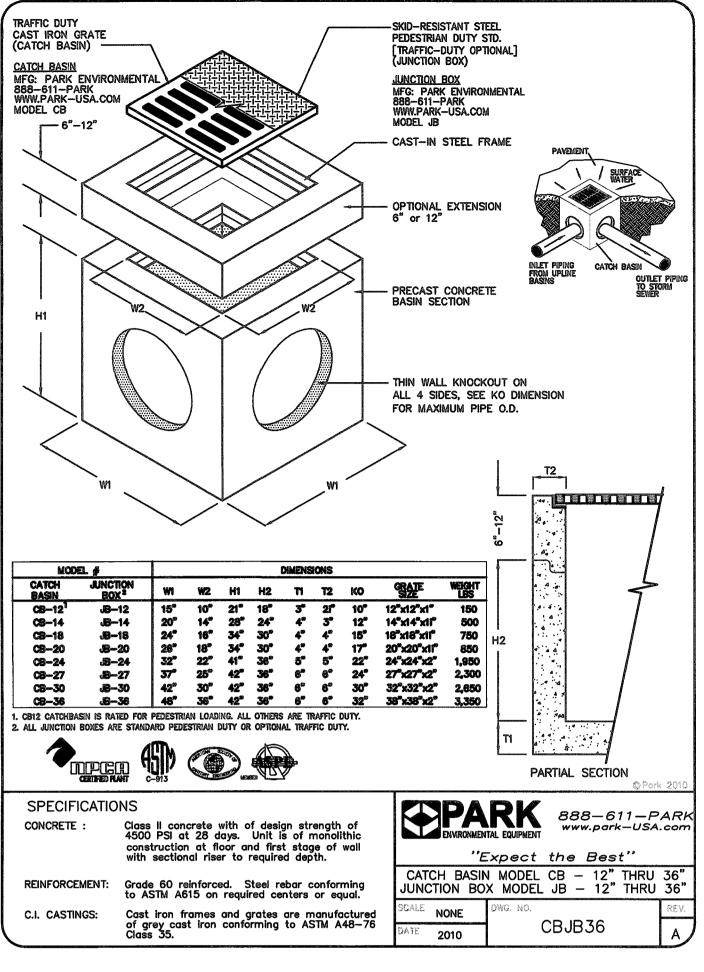
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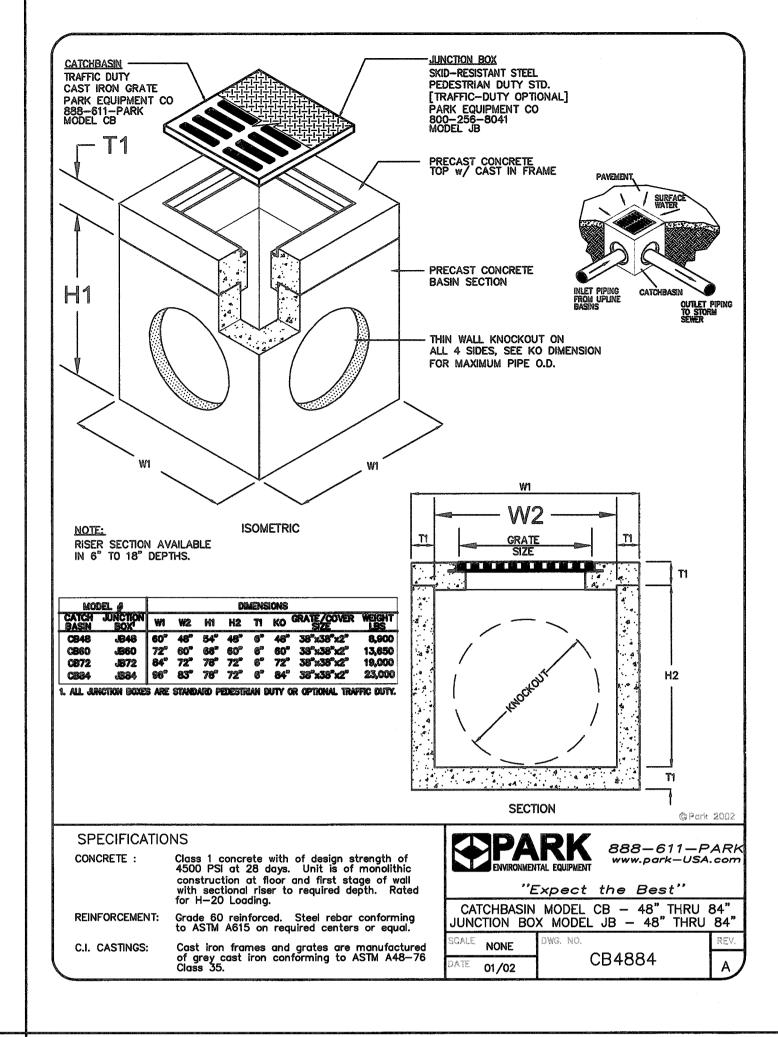
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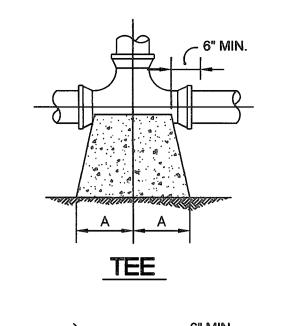


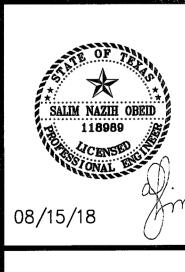
STORM SEWER BEDDING DETAIL


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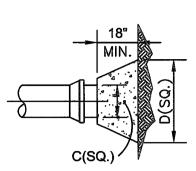




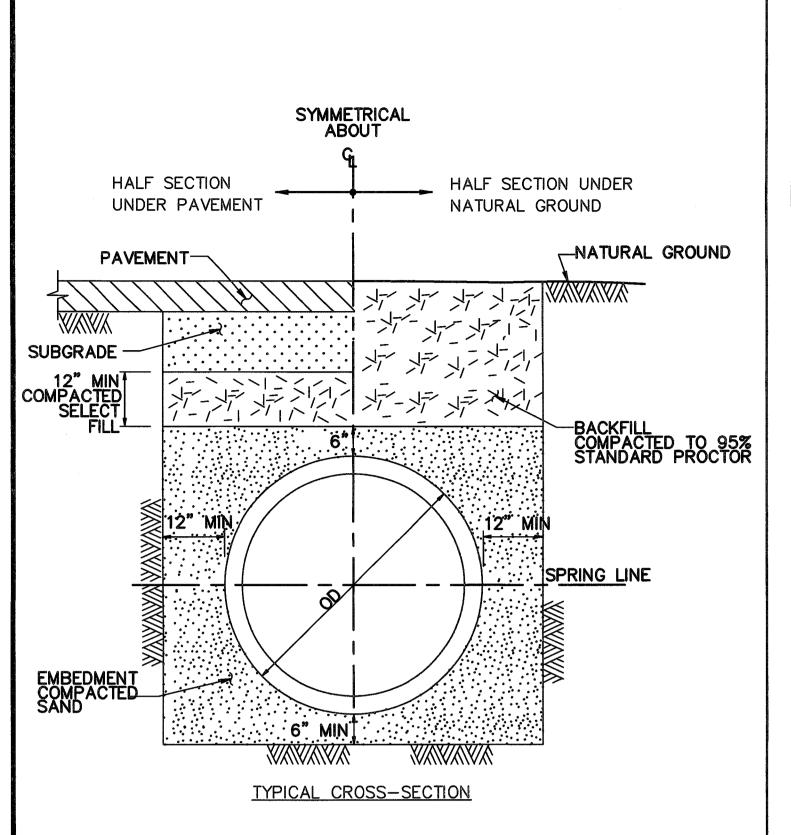

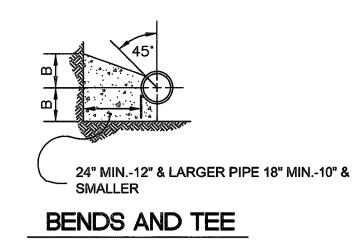

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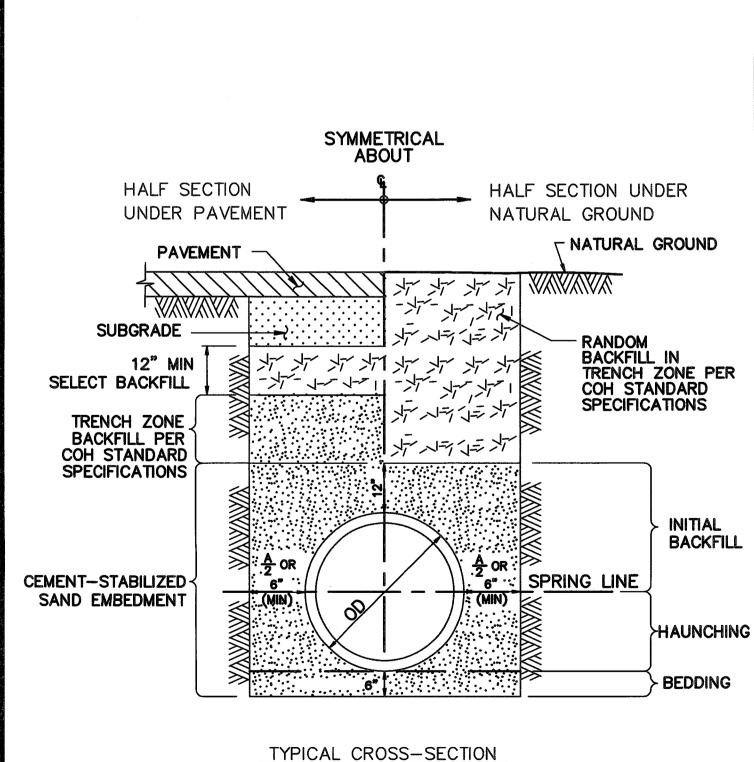
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³ /6	16"	10"	9"	10"	6"	8"	10"	12"	10"	21"
8"	22"	13"	12"	13"	8"	10"	13"	16"	12"	29"
10"	26"	17"	14"	17"	10"	13"	16"	20"	14"	36"
12"	29"	21"	16"	21"	11"	16"	18"	24"	16"	41"
14"	35"	24"	19"	24"	12"	20"	22"	27"	18"	48"
16"	38"	27"	21"	27"	12"	24"	24"	30"	20"	54"
18"	42"	30"	24"	30"	12"	24"	24"	30"	24"	60"
24"	50"	40"	30"	40"	18"	30"	30"	40"	30"	*78"
30"	60"	48"	36"	48"	20"	36"	36"	48"	36"	*96"

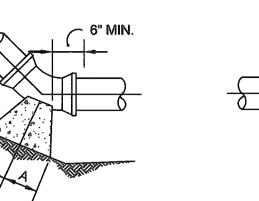Note: Dimension with asterisk (*) requires structural design.


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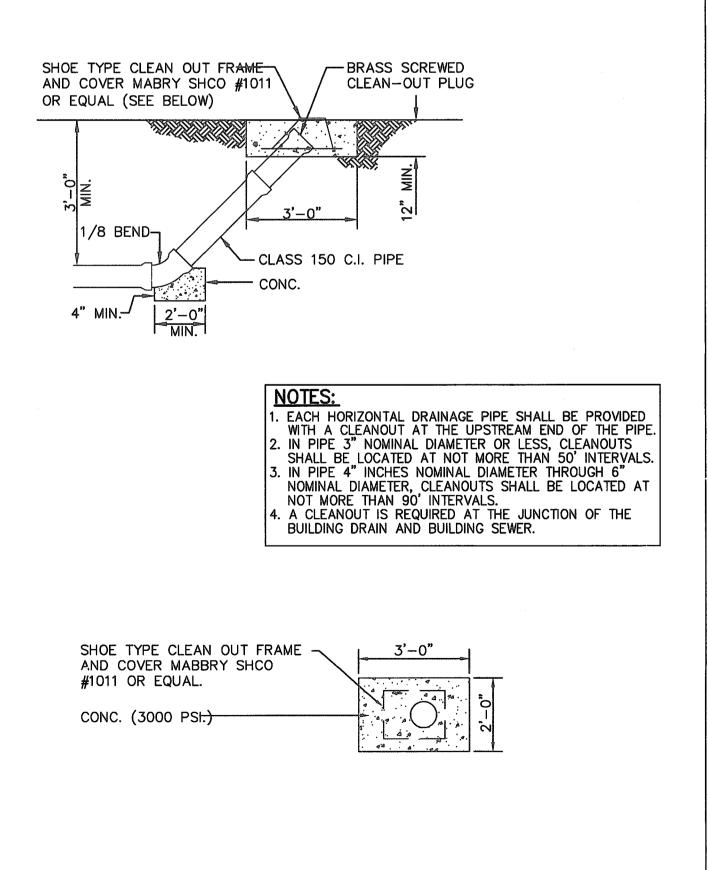
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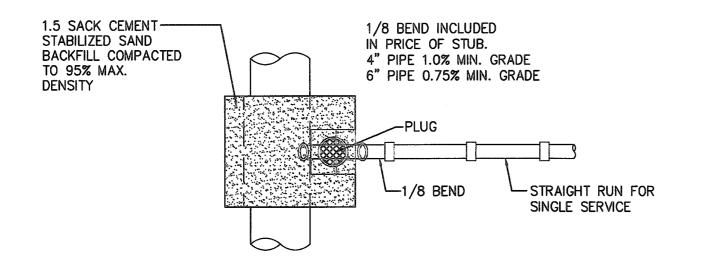
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BEDDING DETAIL

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STANDARD SANITARY SEWER

(NOT TO SCALE)



1. ALL SINGLE SEWER SERVICES AND DOUBLE SEWER SERVICES, AS SHOWN, ARE INTERCHANGEABLE, AS REQUIRED, TO CONNECT WITH STACKS, DOUBLE WYES AND WYES, AS REQUIRED, TAPS FOR PVC PIPE TO BE PVC "T" OR "Y" SADDLE.

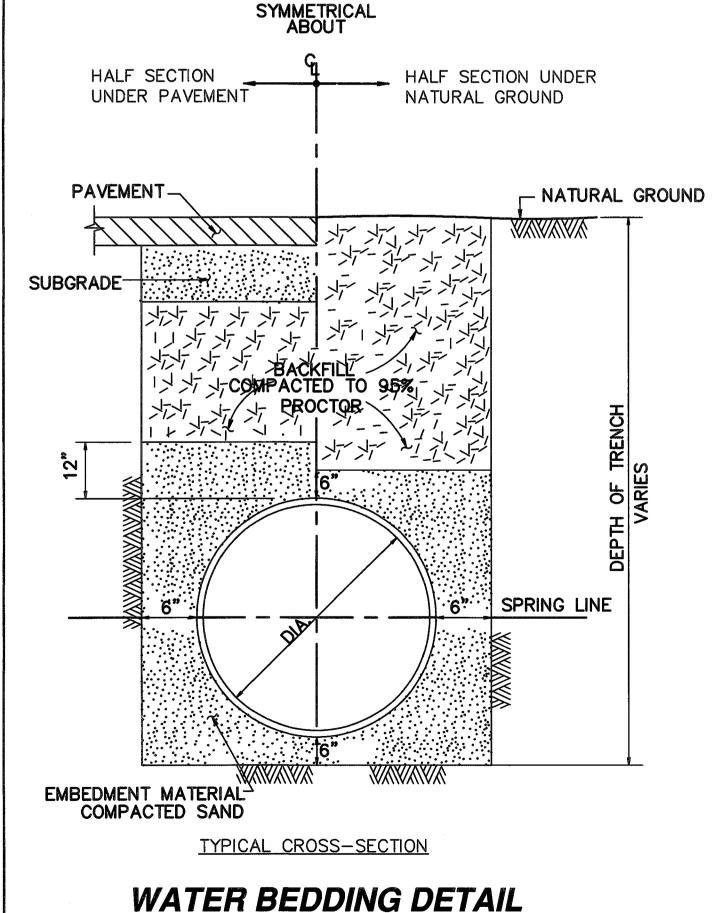2. PROVIDE LOCATOR WIRE LOOPS FROM EACH SERVICE CONNECTION TO NEAREST MANHOLE.

> STANDARD SANITARY SEWER SERVICE LEAD DETAIL (NOT TO SCALE)

GENERAL NOTES FOR SIDEWALKS AND DRIVEWAYS

- SAW CUT EXISTING CURB AT EACH END AND KNOCK OUT CURB FROM BEGINNING TO END OF PROPOSED DRIVEWAY.
- 2. SAW CUT EXISTING PAVEMENT A MINIMUM OF 18" INCHES AWAY FROM BACK OF CURB (GUTTER LINE) AND BREAK OUT TO EXPOSE EXISTING REINFORCEMENT STEEL
- COMPACT SUBGRADE FOR PROPOSED DRIVEWAY CONNECTION FROM PROPOSED SAW CUT AT EXISTING PAVEMENT TO RIGHT-OF-WAY LINE, COMPACT TO 95% OF STANDARD PROCTER DENSITY (+/- 2% OPT. MOISTURE). THE COUNTY ENGINEER RESERVES THE RIGHT TO REQUIRE LABORATORY TESTS TO BE CONDUCTED.
- 4. PLACE AND COMPACT 4" CLEAN BANK SAND.
- 5. MAINTAIN GUTTER LINE WITH FACE OF EXISTING CURB.
- 6. PROPOSED DRIVEWAY REINFORCING STEEL IS TO BE TIED TO EXISTING ROADWAY REINFORCING STEEL WITH A MINIMUM LAP OF 12 INCHES.
- 7. PROPOSED DRIVEWAY REINFORCING STEEL IS TO BE #4 DEFORMED RE-INFORCING BARS ( ASTM A615 GRADE 60, UNLESS NOTED ) SPACED AT 24 INCHES C.C., EACH WAY, WITH 12 INCHES MINIMUM LAP (6"  $\times$  6" W6  $\times$  W6 AS ALTERNATE ) FROM PROPOSED SAW CUT TO RIGHT—OF—WAY
- 8. PROPOSED DRIVEWAY, CURB, GUTTER LINE, AND GRADE SHALL MATCH EXISTING STREET.
- PROPOSED DRIVEWAY SHALL BE CONSTRUCTED WITH PORTLAND CEMENT CONCRETE, CLASS "A" STRUCTURAL (REFER TO SPECIFICATION 03301), 7 INCHES THICK, FROM PROPOSED SAW CUT TO RIGHT-OF-WAY LINE (PROPERTY LINE)
- 10. PROPOSED SIDEWALK SHALL BE CONSTRUCTED WITH PORTLAND CEMENT CONCRETE, CLASS "A" STRUCTURAL (REFER TO SPECIFICATION 03301). 4 INCHES THICK AND 4 FEET MINIMUM WIDTH. SEE DRAWING NO. FBC 24A FOR ADDITIONAL INFORMATION AND DETAILS.


CONSTRUCTION NOTES FOR SIDEWALKS & DRIVEWAYS WITH **CURB TYPE STREETS COMMERCIAL AREA** 

DRAWN BY: L. BRDECKA REVISED BY: L. BRDECKA DATE REVISED: 3-10-05 DATE DRAWN: 2-1-94 APPROVED BY: L. HOOD DRAWING NO. DATE: 2-1-94

FORT BEND COUNTY ENGINEERING DEPARTMENT


WHEN A COMMERCIAL SIDEWALK, DRIVEWAY, CURB OR GUTTER IS CONSTRUCTED, RECONSTRUCTED, REPAIRED OR REGRADED ON COUNTY RIGHT-OF-WAY. FOR USE WITH CONCRETE OR ASPHALT CURB TYPE STREETS, USE SECTIONS APPLICABLE.

A. USE FOR ALL PROPOSED EXISTING CURB REMOVAL FOR DRIVEWAYS (PLAN VIEW NOT TO SCALE)

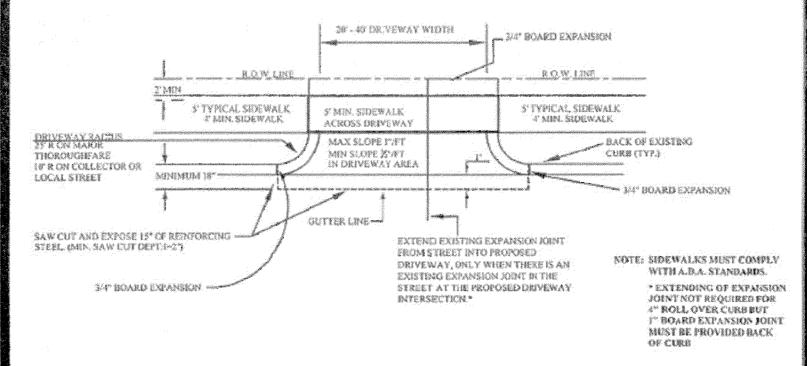

B. USE FOR ALL PROPOSED DRIVES ON CURBED TYPE STREETS

**CURB TYPE STREETS** 

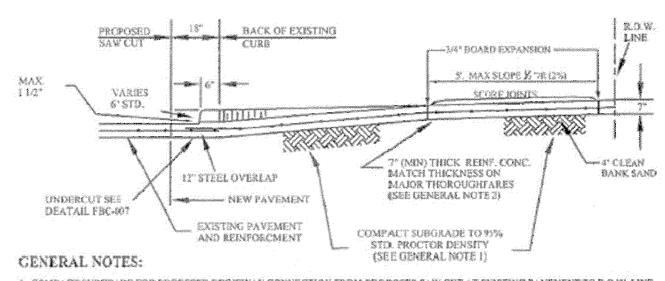


1. COMPACT SUBGRADE FOR PROPOSED DRIVEWAY CONNECTION FROM PROPOSED SAW CUT AT EXISTING PAVEMENT TO R.O.W. LINE, COMPACT TO 95% OF STANDARD PROCTOR DENSITY 9%-1% OPT. MOISTURE). THE COUNTY ENGINEER RESERVES THE RIGHT TO REQUIRE LABORATORY TESTS TO BE CONDUCTED.

2. PROPOSED DRIVEWAY REINFORCING STEEL IS TO BE #4 DEFORMED REINFORCING BARS (ASTM A615, GRADE #6, UNLESS NOTED) SPACED AT 24° C.C., EACH WAY, WITH 12" MINIMUM LAP FROM PROPOSED SAW CUT TO R.O.W. LINE.

3. PROPOSED DRIVEWAY SHALL BE CONSTRUCTED WITH PORTLAND CEMENT (5 SACKS (1908 PSI) OF CEMENT PER CUBIC VARIO OF CONCRETE), CLASS "A" STRUCTURAL (REFER TO SPECIFICTION 61361), T" THICK, FROM PROPOSED SAW CUT TO R.O.W. LINE.

4. PROPOSED SIDEWALK SHALL BE CONSTRUCTED WITH PORTLAND CEMENT (5 SACKS (1000 PSI) OF CEMENT PER CUBIC YARD OF CONCRETE), CLASS "A" STRUCTURAL (REFER TO SPECIFICTION 0030), 4" THICK. 5. FOR TYPICAL SIDEWALK DEATAIL SEE FBC-011. REVISED BY: J. NETARDU SIDEWALKS & DRIVEWAYS ON DRAWN BY: L BRDECKA DATE REVISED: 4-7-09 DATE DRAWN: 2-1-94

DRAWING NO. APPROVED BY: L. HOOD **COMMERCIAL AREA** DATE: 2-1-94 FORT BEND COUNTY ENGINEERING DEPARTMENT

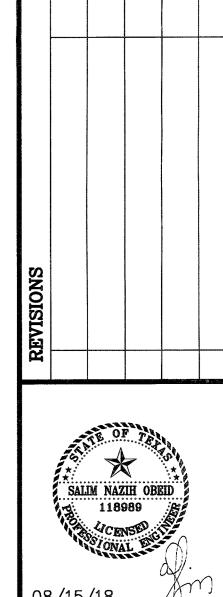

GREEN


HARVEST at

MONS

CON


S E

31 AND 11 RICHMONI

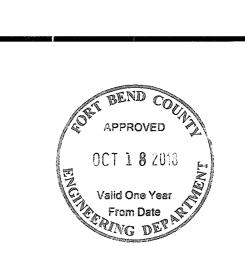

CONSTRUCTION **DETAILS** 

PROJECT No C7.3 1877.01

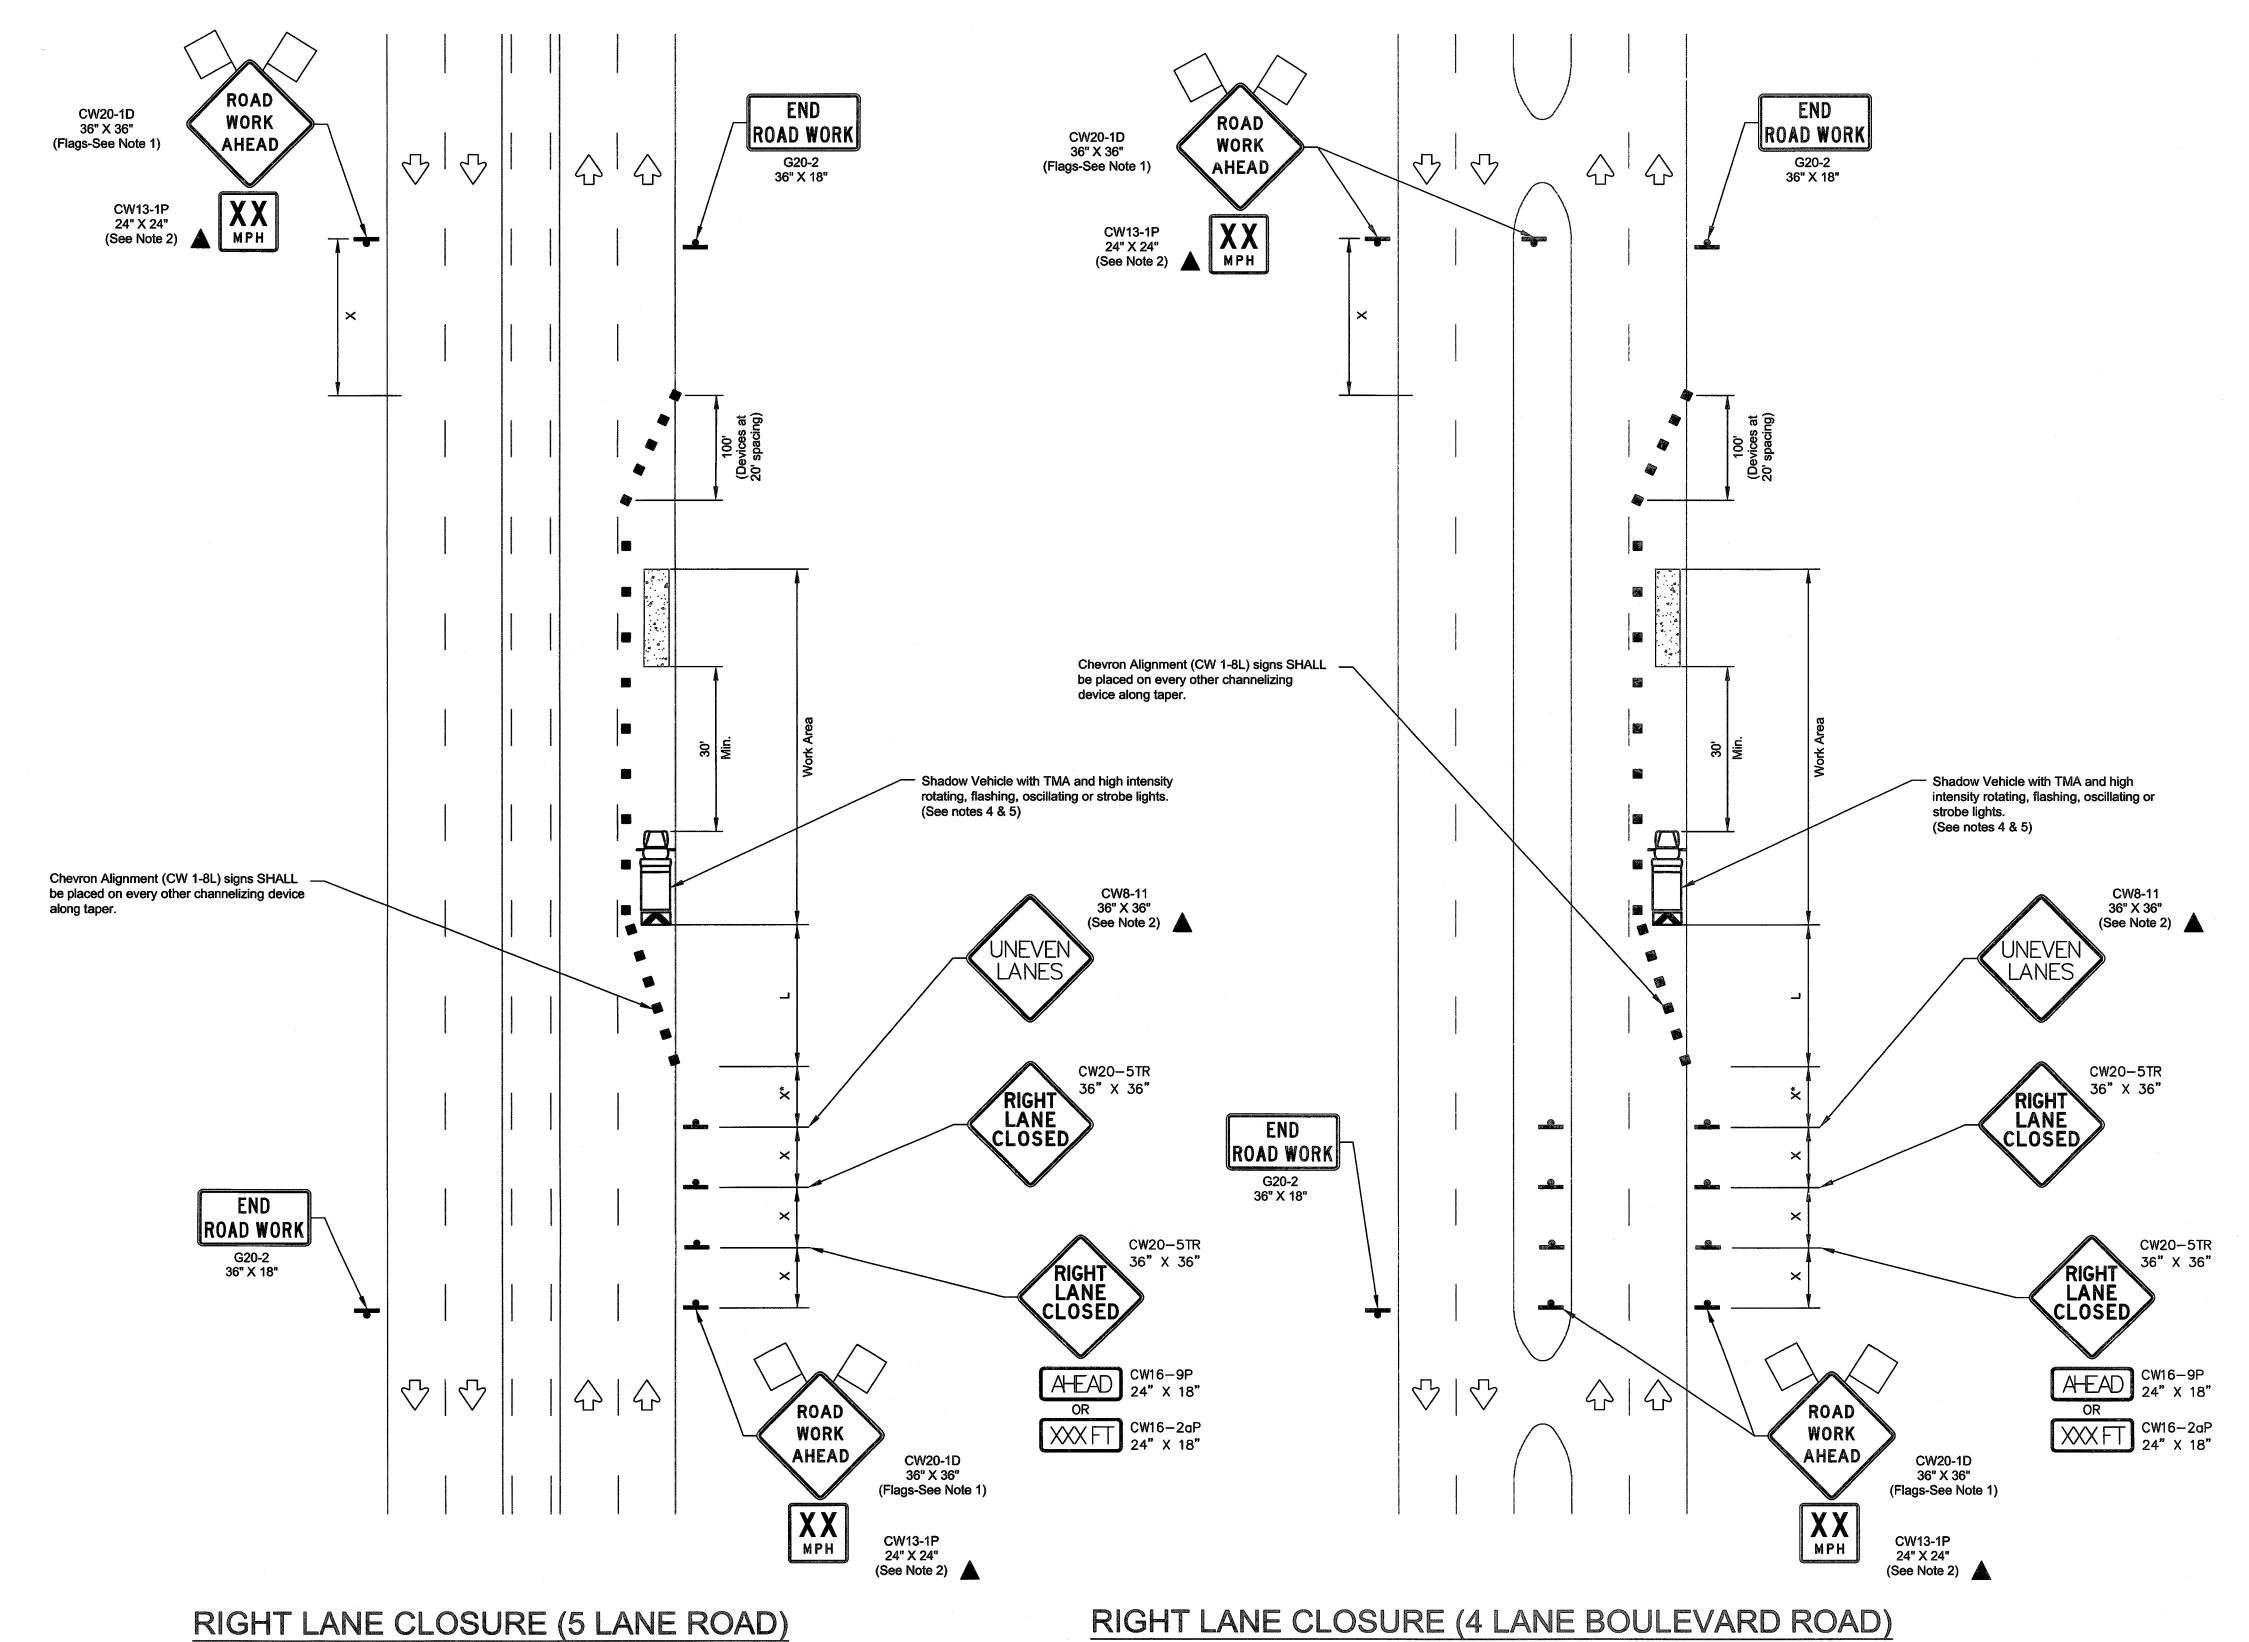

ROADV	ROADWAY		POSTED TAPER SPEED LENGTH		SPACING CHANNELIZING DEVICES		BUFFER SPACE
				TAPER	TANGENT		
HARLEM ROA	D	45	450	49	90	320	195
				-			
							1. · · · · · · · · · · · · · · · · · · ·

	LEGEND						
	Type 3 Barricade		Channelizing Devices				
	Heavy Work Vehicle		Truck Mounted Attenuator (TMA)				
	Trailer Mounted Flashing Arrow Board	M	Portable Changeable Message Sign (PCMS)				
	Sign	4	Traffic Flow				
$\overline{\Diamond}$	Flag	ПО	Flagger				


Posted Speed	Formula	D	finimum esirable Lengths "I	L"	Suggested I Spacir Channo Devi	ng of elizing	Minimum Sign Spacing "X"	Suggested Longitudinal Buffer Space
•		10' Offset	11' Offset	12' Offset	On a Taper	On a Tangent	Distance	"B"
30	ws ²	150'	165'	180'	30'	60'	120'	90'
35	11 =	205'	225'	245'	35'	70'	160'	120'
40	⁻ 60	265'	295'	320'	40'	80'	240'	155'
45		450'	495'	540'	45'	90'	320'	195'
50		500'	550'	600'	50'	100'	400'	240'
55	L=WS	550'	605'	660'	55'	110'	500'	295'
60		600'	660'	720'	60'	120'	600'	350'
65		650'	715'	780'	65'	130'	700'	410'
70		700'	770'	840'	70'	140'	800'	475'
75		750'	825'	900'	75'	150'	900'	540'

- * Conventional Roads Only
- ** Taper lengths have been rounded off.
- L=Length of Taper(FT) W=Width of Offset(FT) S=Posted Speed(MPH)

## **GENERAL NOTES**

- Flags attached to signs where shown are OPTIONAL.
   All traffic control devices illustrated are REQUIRED, except those denoted with the triangle symbol are
- 3. Inactive work vehicles or other equipment should be parked near the right-of-way line and not parked on the paved shoulder.
- 4. A Shadow Vehicle with a TMA should be used anytime it can be positioned 30 to 100 feet in advance of the area of crew exposure without adversely affecting the performance or quality of the work. If workers are no longer present but road or work conditions require the traffic control to remain in place, Type 3
  Barricades or other channelizing devices may be substituted for the Shadow Vehicle and TMA.

  5. Additional Shadow Vehicles with TMAs may be positioned off the paved surface, next to those shown in
- order to protect wider work spaces.
- Contractor shall provide and install traffic control devices in conformance with part VI of Texas Manual on Uniform Traffic Control Devices (TMUTCD Latest edition with revisions) during construction.
   No lanes shall be blocked from 7am to 9am and 2:20pm to 00pm Monday thru Friday.
   Off duty police officers/flaggers are required to direct traffic when applicable.

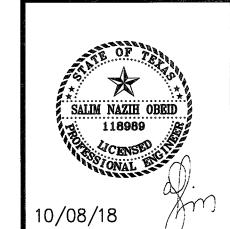


COMMONS

TRAFFIC CONTROL PLAN

DRAWN BY: FA	CHECKED: SNO		
PROJECT No	SHEET No:		
1877.01	C8.0		

APPROVED

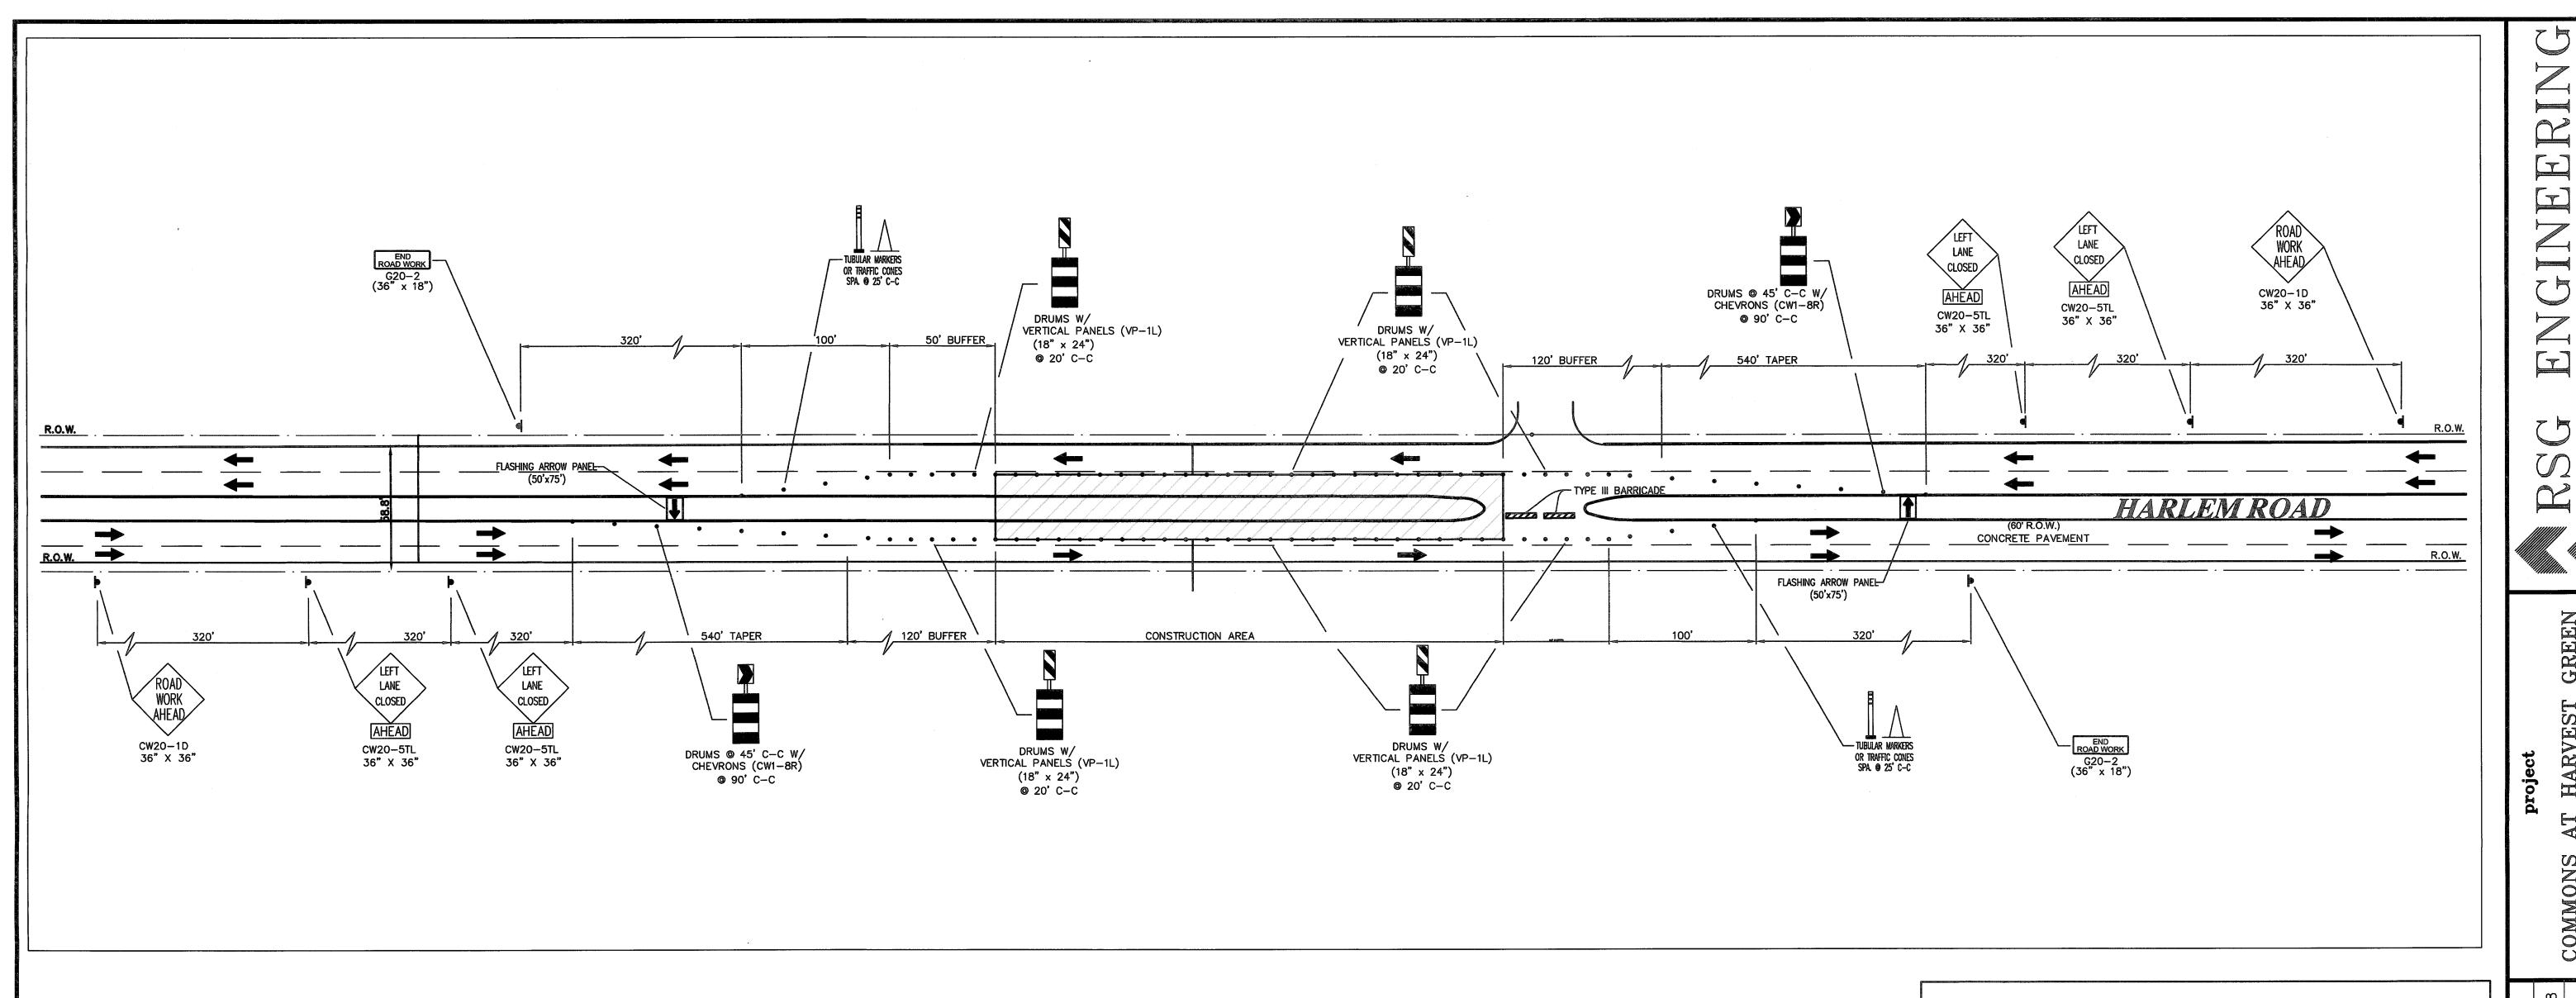

## TRAFFIC NOTES

- CONTRACTOR SHALL PROVIDE AND INSTALL TRAFFIC CONTROL DEVICES IN CONFORMANCE WITH PART VI OF THE TEXAS MANUAL ON UNIFORM TRAFFIC CONTROL DEVICES (TMUTCD - LATEST EDITION WITH REVISIONS) DURING CONSTRUCTION.
- 2. NO LANES SHALL BE BLOCKED FROM 7:00 AM TO 9:00 AM AND 2:30 PM TO 4:00 PM MONDAY THRU FRIDAY.
- 3. OFF DUTY POLICE OFFICER(S)/CERTIFIED FLAGGER(S) IS/ARE REQUIRED TO DIRECT TRAFFIC WHEN LANES ARE BLOCKED.
- 4. CONTRACTOR SHALL COVER THE EXCAVATIONS WITH STEEL PLATES ANCHORED PROPERLY DURING NON-WORKING HOURS AND ALLOW NORMAL TRAFFIC FLOW. IF COVERING IS NOT FEASIBLE, USE TRANTEX FR 336 EFX 36" DELINEATOR OR APPROVED EQUAL WITH SHEETING AND BASE EPOXIED TO PAVEMENT NEXT TO EXCAVATION DURING NON-WORKING HOURS.
- 5. APPROVED COPIES OF THE "TRAFFIC CONTROL PLANS" SHALL BE AVAILABLE FOR INSPECTION AT ALL TIMES.
- 6. IF THE CONTRACTOR CHOOSES TO USE A DIFFERENT METHOD OF "TRAFFIC CONTROL PLANS" DURING THE CONSTRUCTION THAN WHAT IS OUTLINED IN THE CONTRACT DRAWINGS, HE/SHE SHALL BE RESPONSIBLE TO PREPARE AND SUBMIT ALTERNATIVE PLANS* TO TRAFFIC SECTION OF F.B.C. FOR APPROVAL TEN WORKING DAYS PRIOR TO IMPLEMENTATION.
  - *THESE PLANS SHALL BE DRAWN TO SCALE ON REPRODUCIBLE MYLARS AND SEALED BY A LICENSED ENGINEER IN THE STATE OF TEXAS. PLANS WILL BECOME A PART OF THE CONTRACT DRAWINGS.
- IF PROJECT IS WITHIN 400 FEET FROM A SIGNALIZED INTERSECTION, THE CONTRACTOR SHALL CONTACT FORT BEND COUNTY PUBLIC INFRASTRUCTURE DEPARTMENT, SIGNAL DIVISION FIVE (5) DAYS PRIOR TO THE START OF CONSTRUCTION.

SIGN SPACING						
Posted Speed or 85% Speed (MPH)	X Min. Distance (feet)					
30 OR LESS 35	120 160					
33 40	240					
45	320					
50	400					
55	500					
65	750					

X=SIGN SPACING L=TAPER 2XL=TANGENT

# CONSTRUCTION WARNING

30		150'	165'	
35	$L = \frac{WS^2}{60}$	205'	225'	
40		265'	295'	
45		450'	495°	
50		500'	550'	
55	L=WS	550'	605'	
60		600'	660'	
65		650'	715'	

Formula

Posted

Speed

* 85th Percentile Speed may be used on roads where traffic speeds normally exceed the posted speed limit. ** Taper lengths have been rounded off.









TYPICAL TRANSITION LENGTHS

12' On a

Taper

30'

35'

40'

45°

50'

55'

60'

65'

Suggested Maximum Spacing of Device

Tangent

60'-75'

70'-90'

80'-100'

90'-110'

100'-125'

110'-140'

120'-150'

130'-175'

SUGGESTED MAXIMUM SPACING OF DEVICES

Offset

245'

320'

600'

720'


Minimum Desirable Taper Lengths **

Offset Offset

DRUMS WITH RIGHT DRUMS WITH LEFT DRUMS WITH DRUMS WITH CHEVRON SIGN VERTICAL PANEL CHEVRON SIGN VERTICAL PANEL (VP1-R)(CW1-8)(VP1-L) (CW1-8)WARNING LIGHTS ARE OPTIONAL BUT MUST BE USED DURING DARK HOURS

# LEGENDS:

	WORK AREA
	AREAS BLOCKED TO TRAFFIC
0	DRUMS WITH LEFT CHEVRON SIGN
$\triangleright$	DRUMS WITH RIGHT VERTICAL PANEL
0	DRUMS WITH RIGHT CHEVRON SIGN
	DRUMS WITH LEFT VERTICAL PANEL
$\otimes$	PLASTIC DRUMS
	28" TUBULAR MARKERS
0	28" TRAFFIC CONES
	TRAFFIC CONSTRUCTION SIGNS
I	TYPE III BARRICADE WITH 2 TYPE "A" WARNING LIGHTS
	FLAGGER = OFF DUTY POLICE OFFICER
	FLASHING ARROW PANEL
<b>→</b>	DIRECTION OF TRAFFIC FLOW

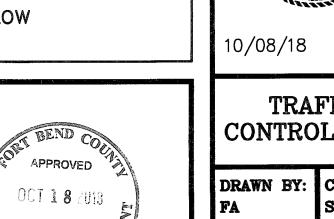

Valid One Year

From Date NO DEP

TRAFFIC CONTROL PLAN DRAWN BY: CHECKED:

HARLEM ROAD IXAS 77406


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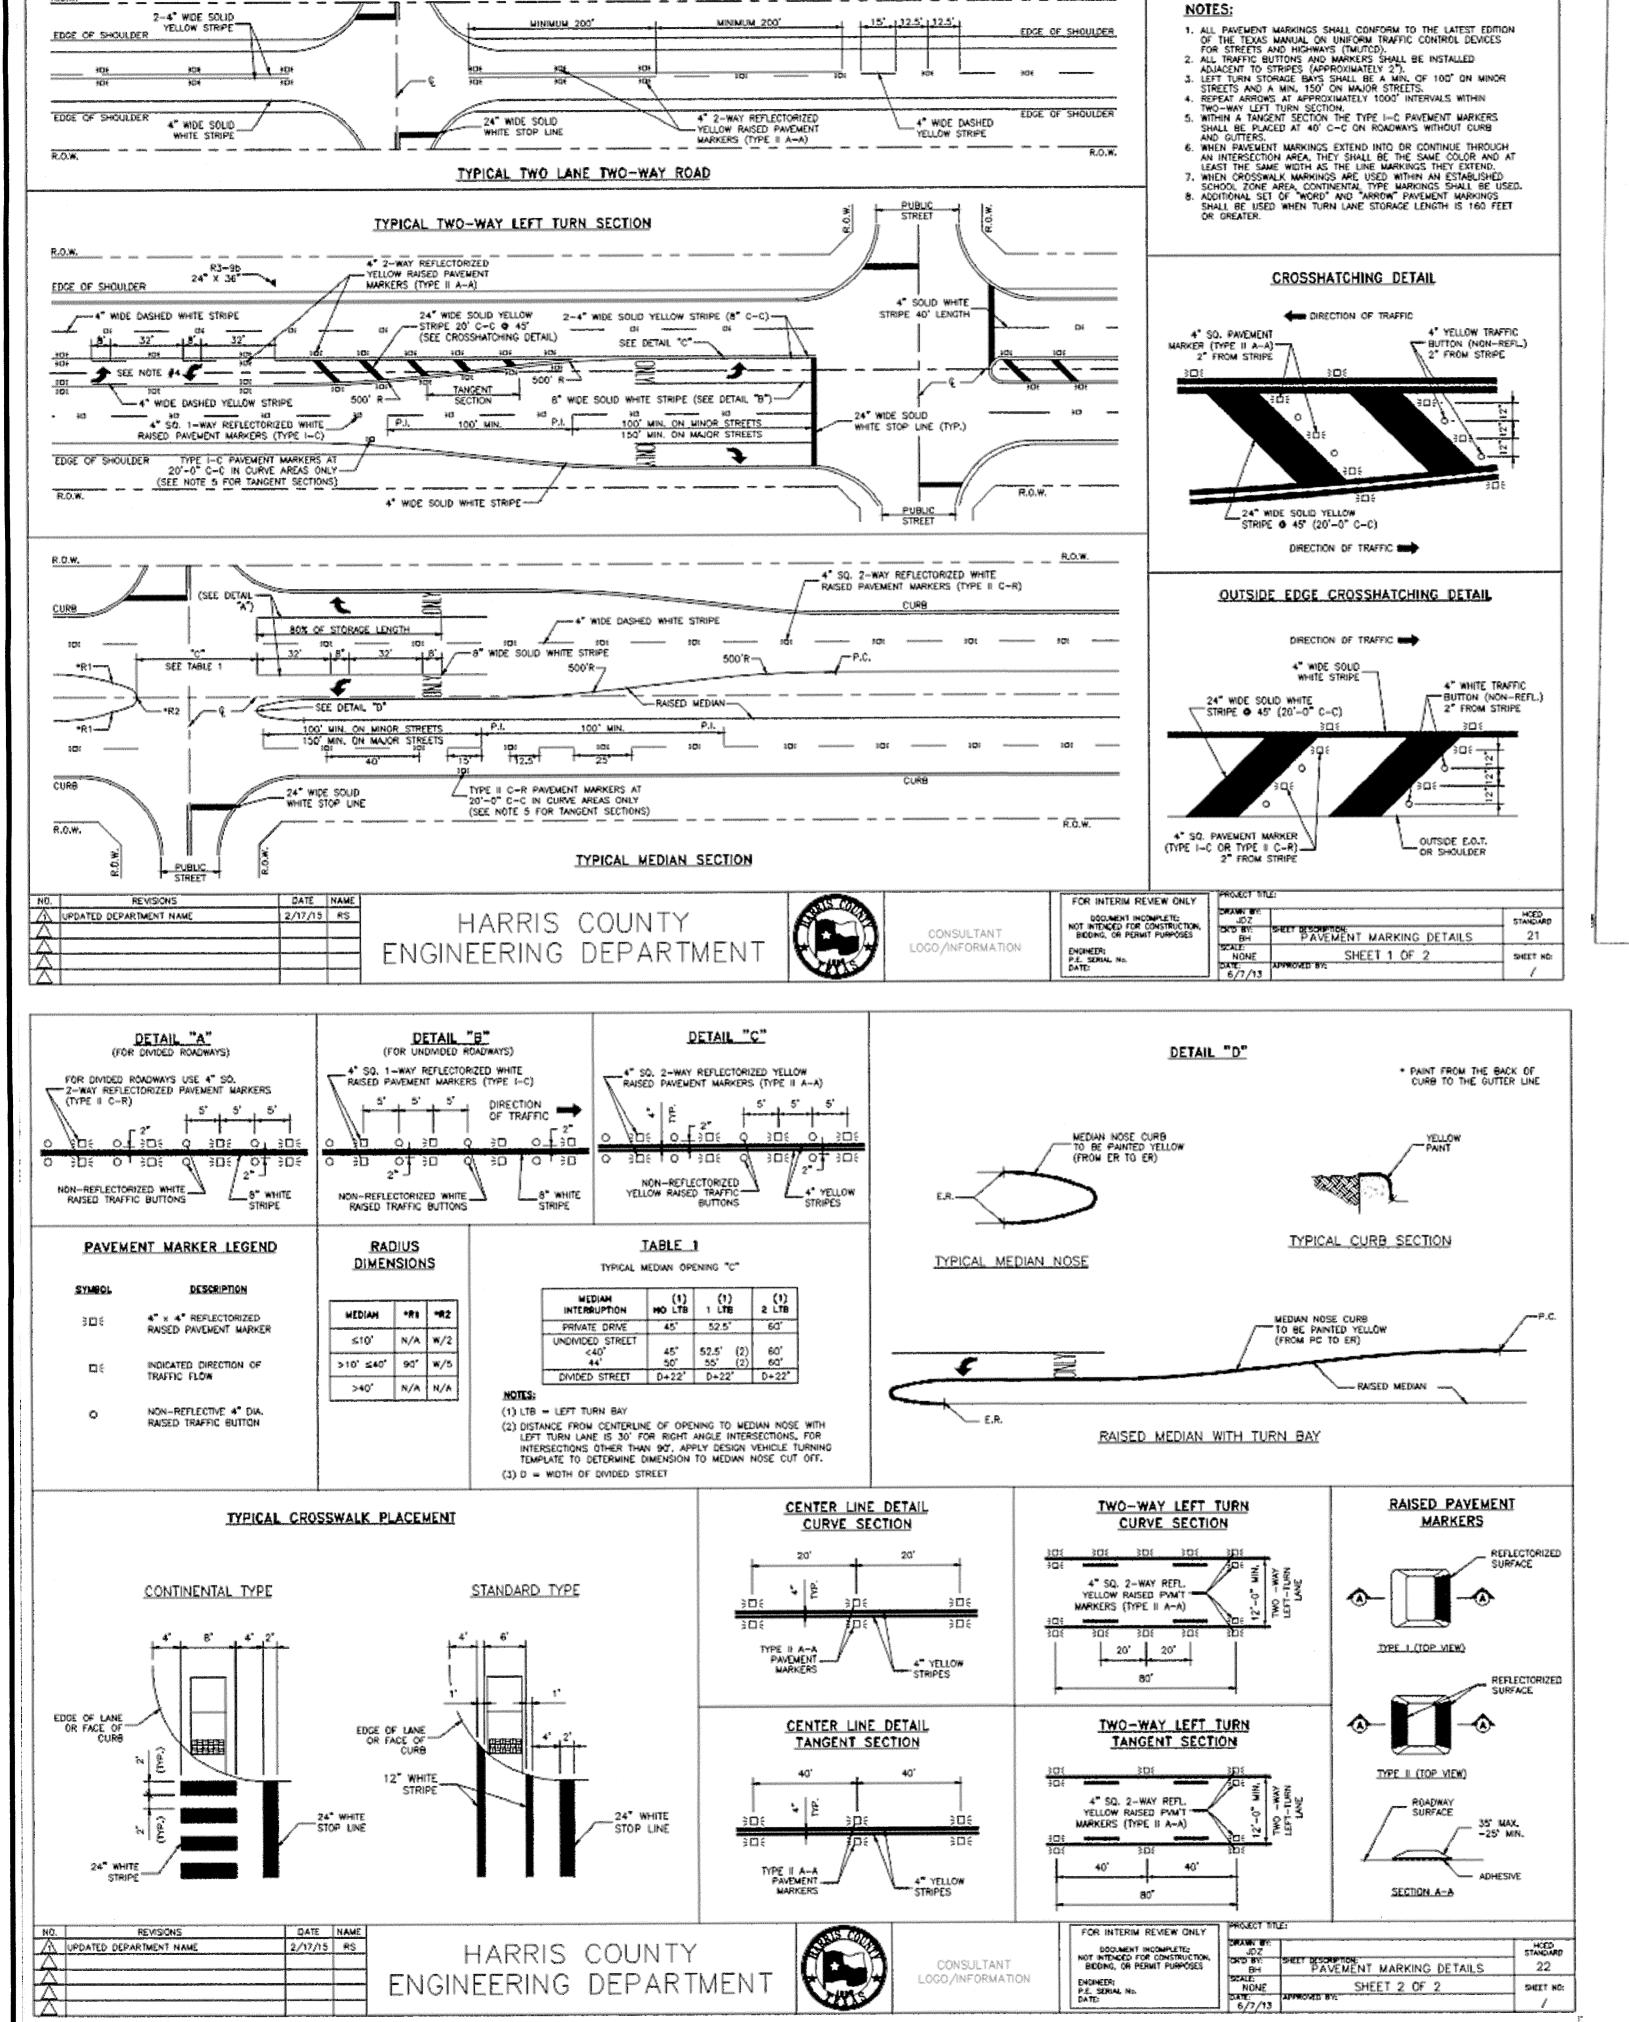
HARVEST


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PROJECT No SHEET No:





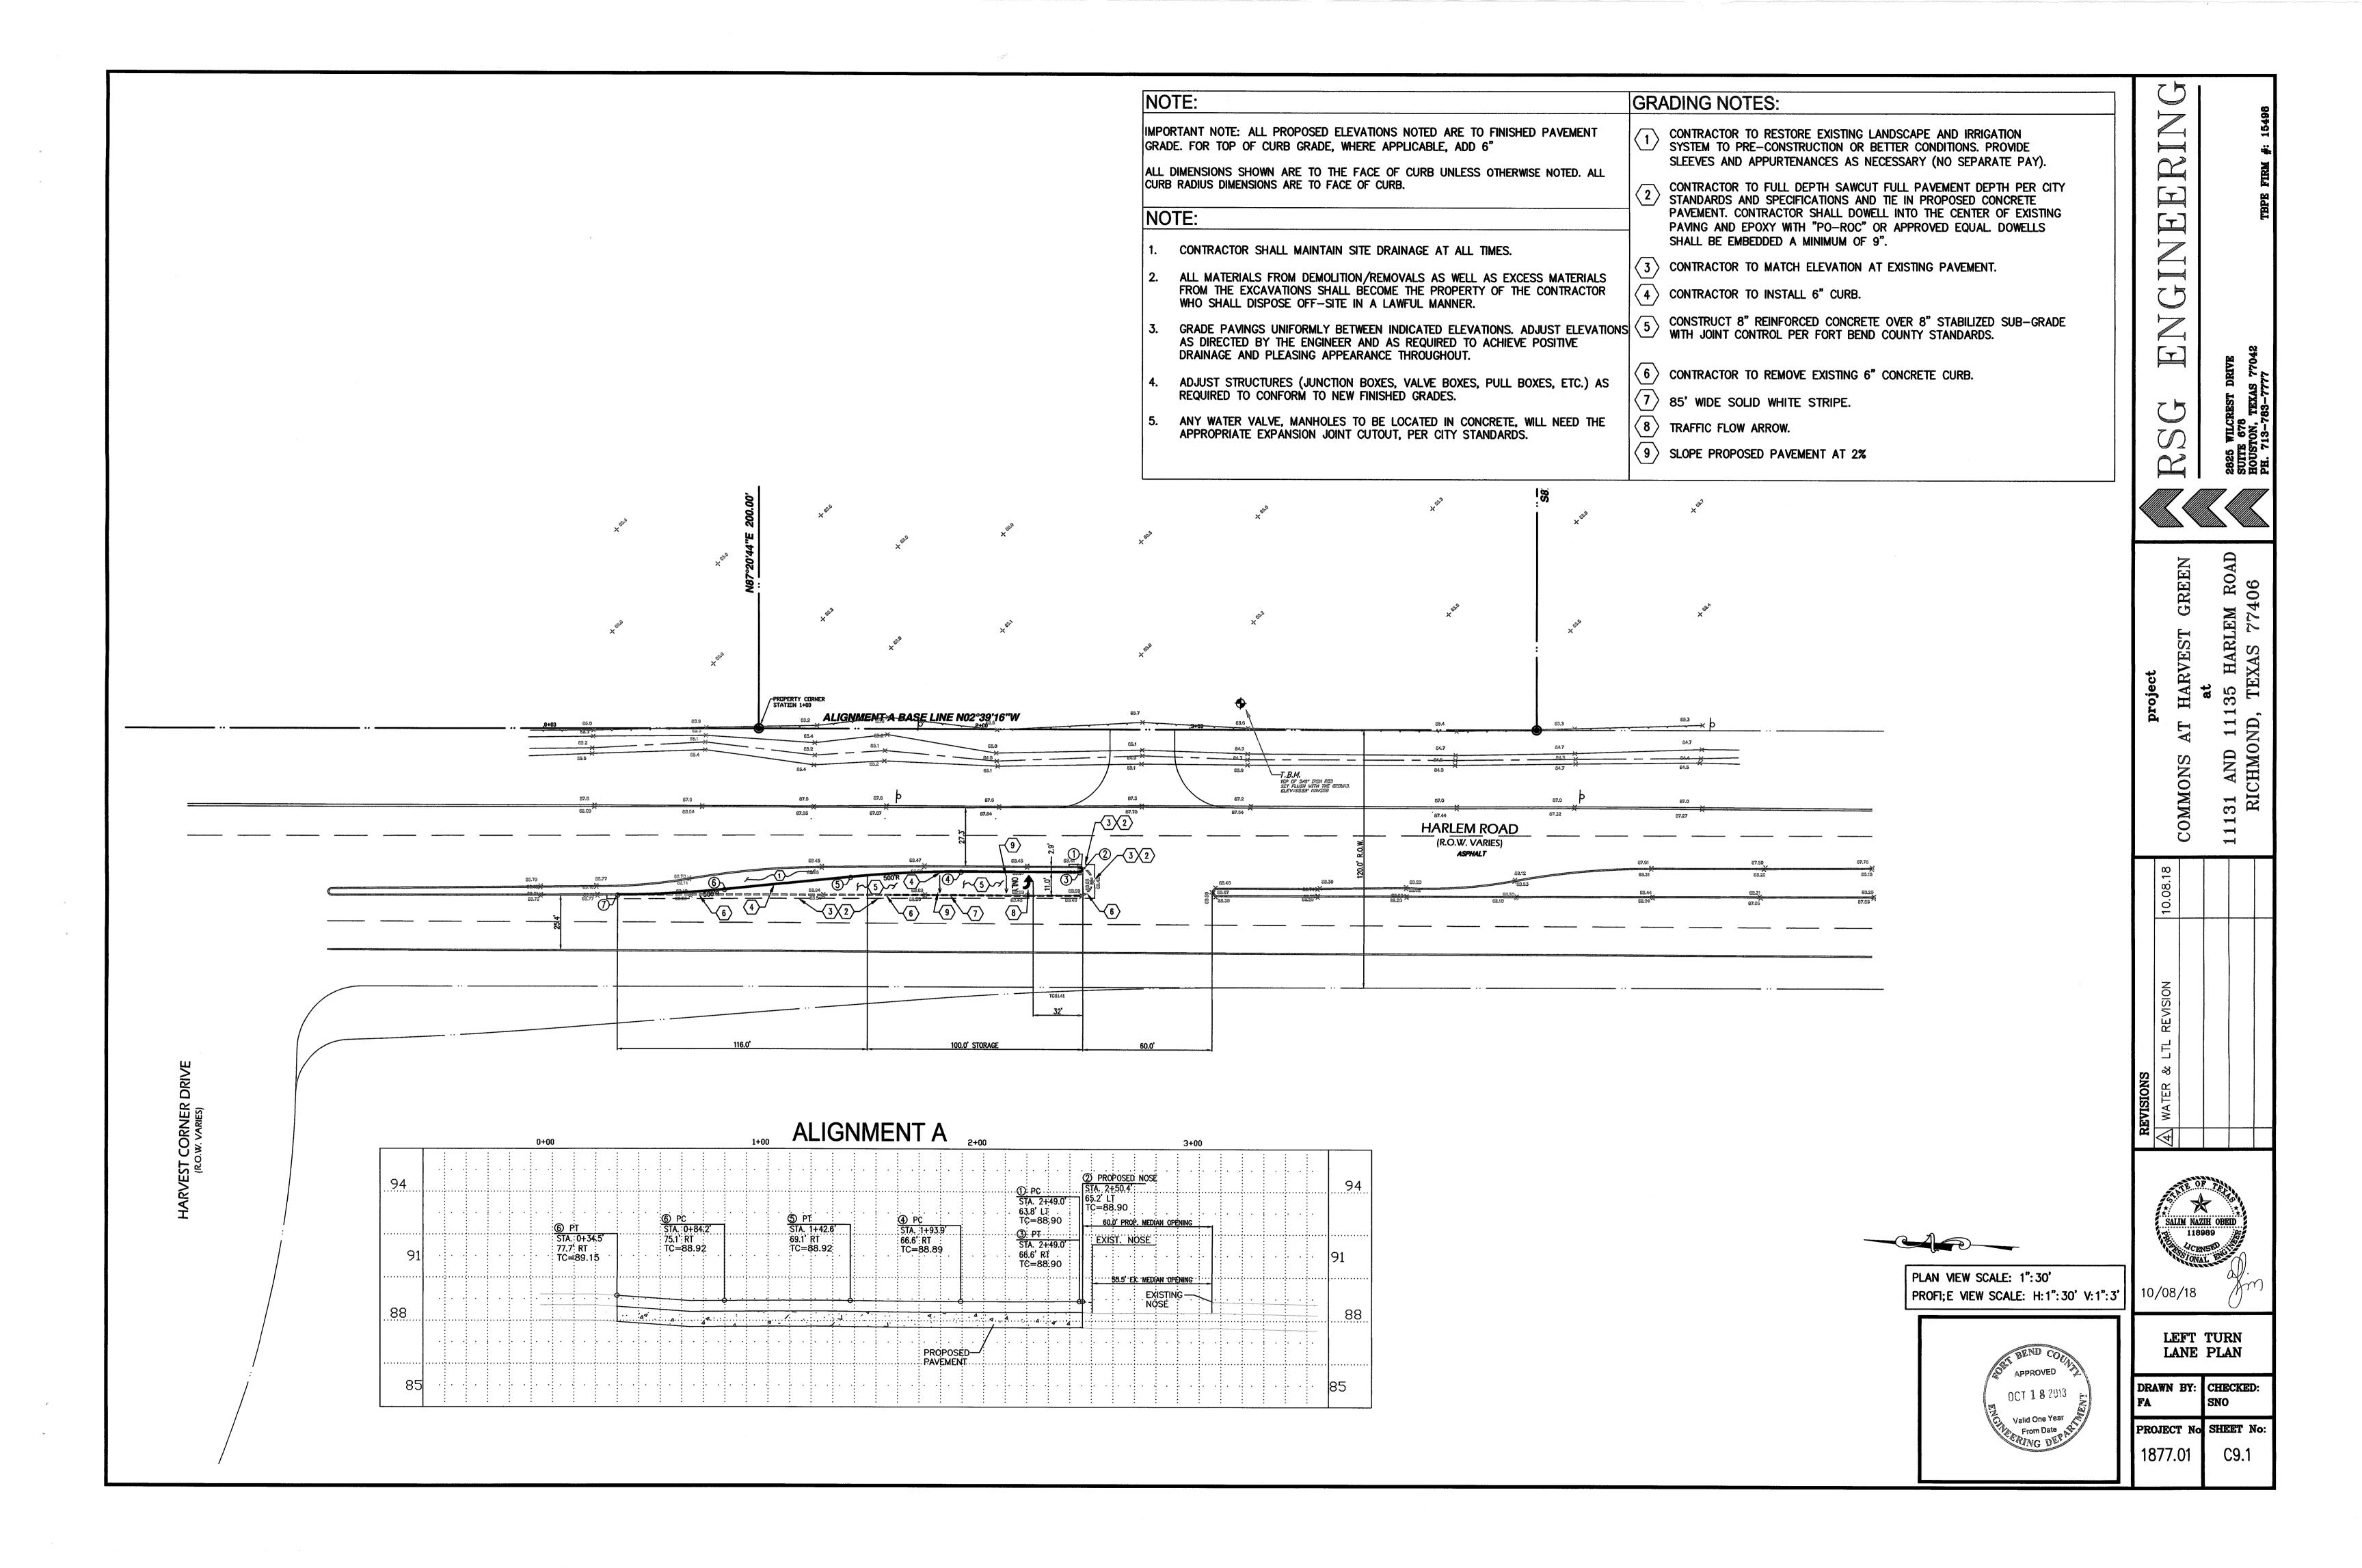

## MEDIAN DIMENSIONS

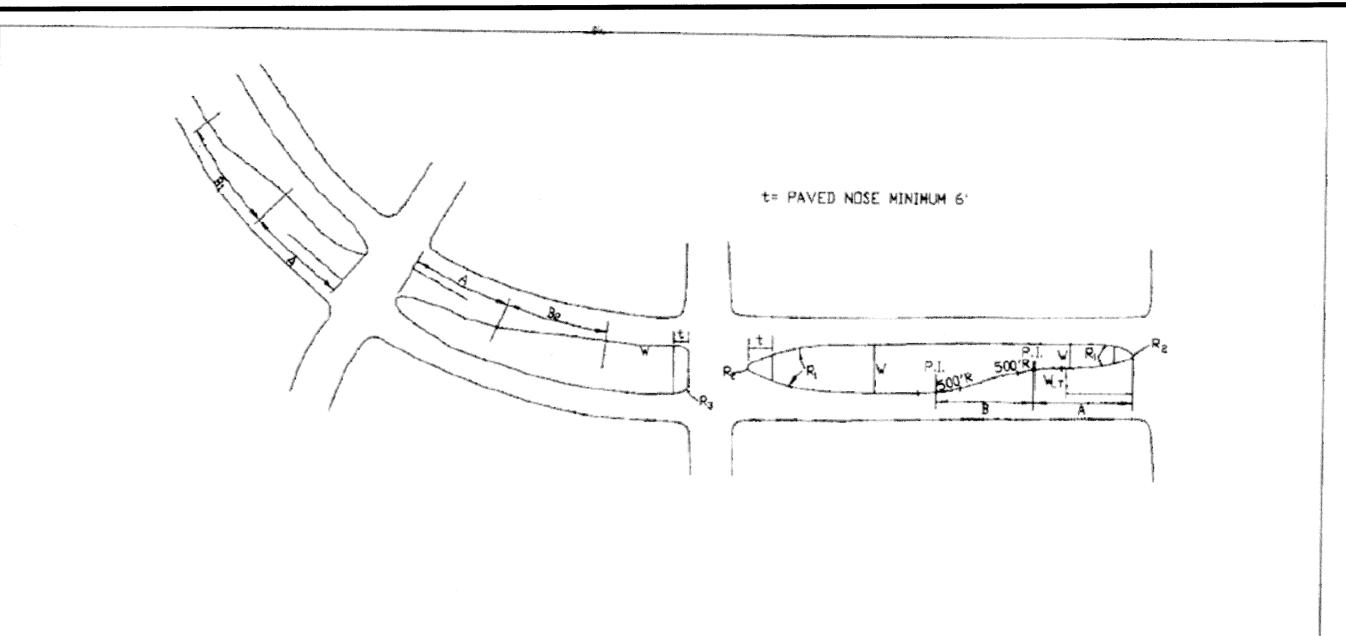w	۴,	R ₂	R ₃
≤10°	NONE	₩ 2	NONE
>10*<40*	90	₩ 5	NONE
>40'	NONE	NONE	15

#### LEFT TURN BAY DIMENSIONS

A = 150' MINIMUM AT INTERSECTION OF TWO MAJOR STREETS.

= 100' MINIMUM AT ALL OTHER INTERSECTIONS.

B = 100' MINIMUM ON STRAIGHT ROADWAY.

B₁ = TAPER LENGTH MAY BE SHORTER IF IT IS ON A
HORIZONTAL CURVE TO THE LEFT.

B_Z = TAPER LENGTH MAY BE LONGER IF CURVE IS TO THE RIGHT

W_T= 10' MINIMUM

NOTE: DIMENSIONS MAY BE ADJUSTED AS DETERMINED BY AGENCY ENGINEER.

CITY OF HOUSTON
DEPARTMENT OF PUBLIC WORKS AND ENGINEERING

MEDIAN DESIGN MEDIAN NOSE AND LEFT TURN BAY

(NOT TO SCALE)


APPROVED BY:

CITY ENGINEER

DIRECTOR OF PUBLIC

WORKS AND ENGINEERING

EFF DATE: JULY-01-2009 DWG NO: 10.06-07

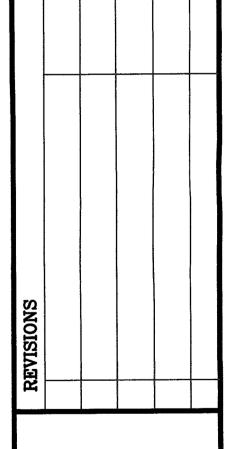

 $\mathcal{C}$ 

35 HARLEM TEXAS 774

<del>--|</del>



LEFT TURN

LEFT TURN
LANE DETAILS

BEND

APPROVED

OCT 1 8 2018

Valid One Year

DRAWN BY: FA	CHECKED: SNO
PROJECT No	SHEET No:
1877.01	C9.2