

REVIEW BY FORT BEND COUNTY COMMISSIONERS COURT

Fort Bend County

Engineering Department
301 Jackson Suite 401
Richmond, Texas 77469
281.633.7500
Permits@fortbendcountytx.gov

Right of Way X Commercial E Permit No: 2018-20	Priveway Permit
Applicant: Sundance Construction Job Location Site: 4828 Waterview Town Center Dri Bond No. Date of Bond: 8/2/2	ve, Richmond, TX 77406 2018 Amount: \$50,000.00
Laying, Construction, Maintenance, and Repair of Buried Roads, Streets, Highways, and Drainage Ditches in Fort Bo Commissioners Court of Fort Bend County, Texas," as pas	ssed by the Commissioners Court of Fort Bend County, t Bend County, Texas, to the extent that such order is not
grounds for job shutdown. 2. Written notices are required: a. 48 hours in advance of construction is b. When construction is completed and Administrator thru MyGovernmentO 3. This permit expires one (1) year from date of perm	ready for final inspection, submit notification to Permit Online.org portal. In it if construction has not commenced. It-of-ways owned and maintained by Fort Bend County only,
	d carried, it is ORDER D, ADJUDGED AND DECREED that said the Commissioners Court of Fort Bend County, Texas, and
By: County Engineer	Presented to Commissioners Court and approved. Date Recorded 1-13-20 Comm. Court No. 2 M
N/A By: Drainage District Engineer/Manager	Clerk of Commissioners Court By: Deputy



PERMIT APPLICATION REVIEW FORM FOR CABLE, CONDUIT, AND POLE LINE ACTIVITY IN FORT BEND COUNTY

Fort Bend County Engineering Department 301 Jackson Suite 401


Richmond, Texas 77469 281.633.7500 Permits@fortbendcountytx.gov

	t of way Permit										
	mercial Driveway Perr	nit									
Permit No:	2018-20660	_									
The following "Notice of Proposed Cable, Conduit, and/or Pole Line activity in Fort Bend County" and accompanying attachments have been reviewed and the notice conforms to appropriate regulations set by Commissioner's Court of Fort Bend County, Texas.											
(1) COMPLETE APPLICATION FORM:											
χ a. Name of road, street, and/or	drainage ditch affected										
X b. Vicinity map showing course of	of directions										
x c. Plans and specifications											
(2) BOND:											
County Attorney, approval wher applicable.	1										
X Perpetual bond currently posted.	Bond No:	Amount: \$50,000.00)								
Performance bond submitted.	Bond No:	Amount:	_								
Cashier's Check	Check No:	Amount:									
(3) DRAINAGE DISTRICT APPROVAL (WHE	N APPLICABLE):										
Drainage District Approval	•	Date	-								
	 										
We have reviewed this project and agree it m	neets minimum require	ements.									
Sean Eghten											
			29/2018								
Permit Administrator			Date								

READ KING

PLANS FOR CONSTRUCTION OF WATER, SANITARY SEWER, PAVING AND DRAINAGE FACILITIES TO SERVE

WATERVIEW TOWN CENTER VILLAGE EAST HIGHWAY 99 AND HARLEM ROAD RICHMOND, TEXAS 77046

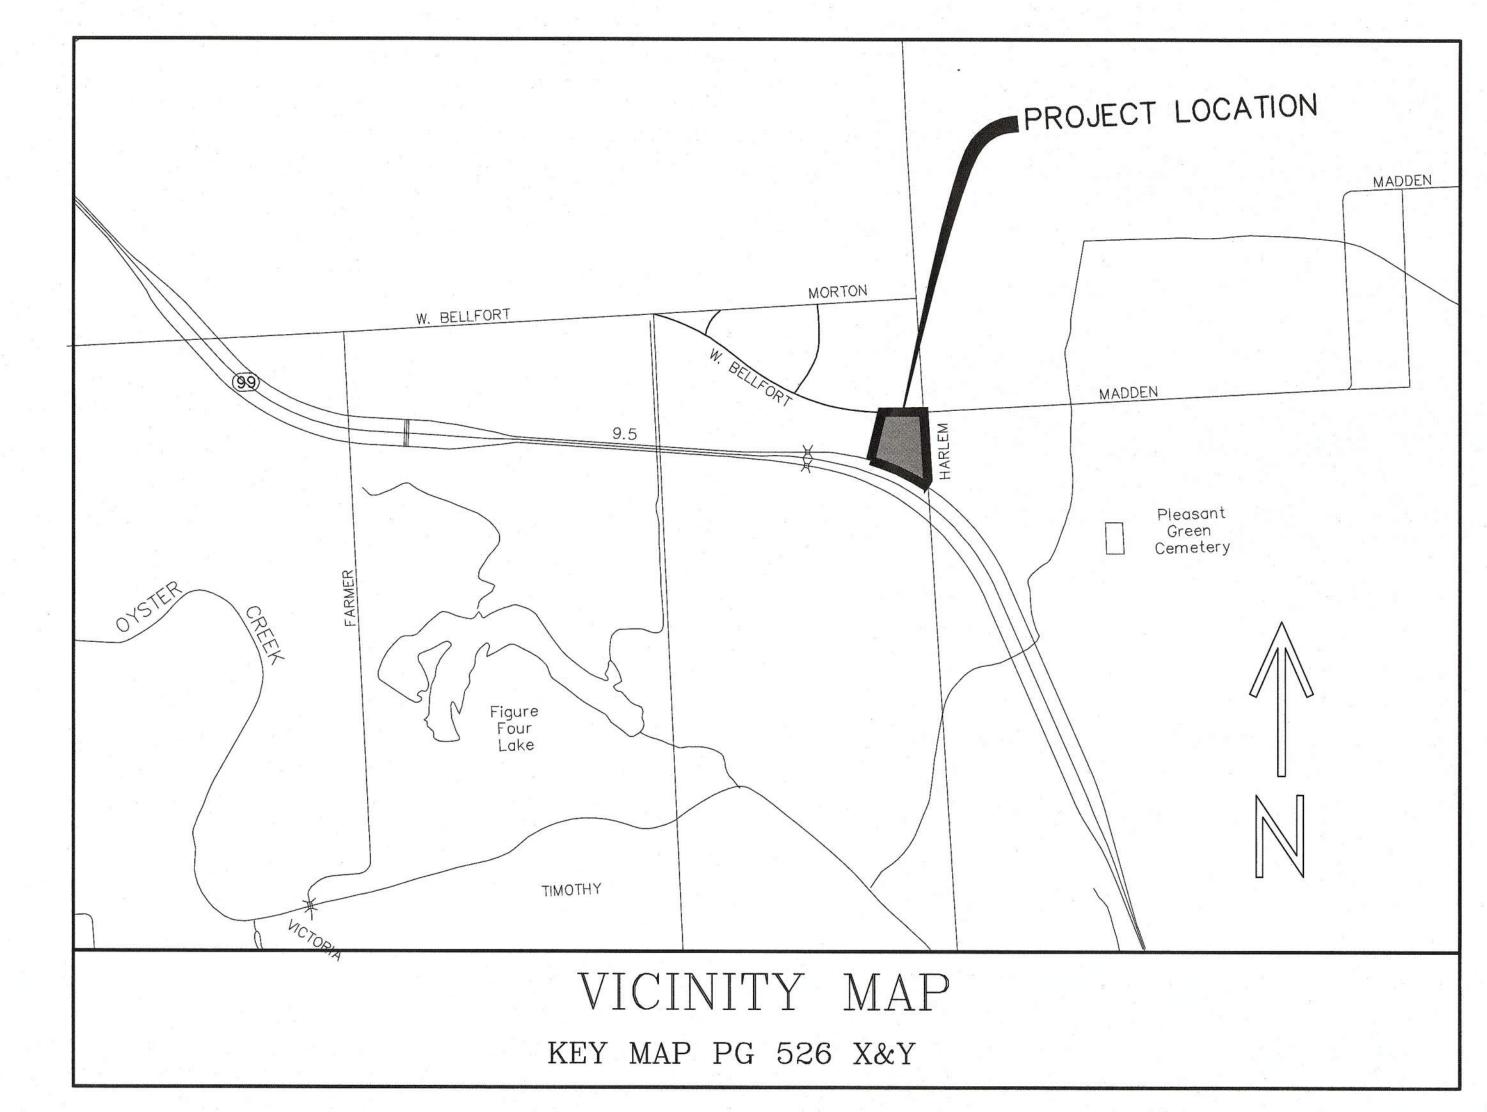

SHEET INDEX

Sheet 1	Cover Sheet
Sheet 2	Subdivision Plat - Sheet 2
Sheet 3	Notes and Details
Sheet 4	Drainage Area Map
Sheet 5	Drainage Calculations
Sheet 6	Dimensioned Site Plan
Sheet 7	Civil Site Plan
Sheet 8	Paving Plan
Sheet 9	Storm Water Pollution Prevention Site Plan
Sheet 10	Storm Water Pollution Prevention Site Plan Detail
Sheet 11	TxDOT Pedestrian Ramp Details
Sheet 12	Traffic Control Plan

Fort Bend County Municipal Utility District No. 143 General Construction Notes

- a. The City of Houston and TCEQ rules for waterline crossings must be followed. The City of Houston requires a minimum of 24 inches (24") between water and sanitary sewer crossings and a minimum of 18 inches (18") between water and storm sewer crossings.
 b. Poly-vinyl-chloride PSM (PVC) pipe shall conform to ASTM Specification D3034 and be installed
- according to ASTM D2321.
 All sanitary sewer service lines shall be constructed to true alignment and grade. Warped and sagging lines will not be permitted.
 Building tie-on connection will be made directly to the stub-out from the building plumbing at the foundation on all waste outlets.
- e. All non-single family service lines will be encased in a layer of 1.5 sack per cubic yard cement stabilized sand, six-inches (6") thick, completely around the line.

 f. All Service lines under or within one foot (1') of proposed or future driveways or parking lots shall be backfilled with 1.5 sack per cubic yard, cement stabilized sand, to within one-foot (1') of subgrade.

 g. Water-tight adapters of a type compatible with the materials being joined will be used at the point of connection of the same line to the will be used at the point.
- of connection of the service line to the building plumbing. No cement grout materials are permitted.

 h. No bends or turns at any point will be greater than 45 degrees.

 i. Each cleanout will be installed so that it opens in a direction opposite to the flow of the waste and, except in the case of "wye" branch and end-of-the-line cleanouts, cleanouts will be installed
- vertically above the flow line of the pipe.

 J. Cleanout will be made with airtight mechanical plug.

 k. Application for Sanitary Sewer Service must be filed prior to construction of the service line and the connection fee should accompany this application. Application forms are available from the District's Operator, Environmental Development Partners, 713-395-3100. Construction must not
- begin until authorized by the District.

 I. When the service line is complete, and prior to backfilling the pipe trench, the applicant for sewer service shall request an inspection of the installation. Requests for inspections shall be made to the District's Operator, Environmental Development Partners, 713-395-3100 twenty-four (24) hours in advance of the inspection.
- m. The physical connection to the District's sewer main will be made by use of an adapter of a type compatible with materials being joined. The connection shall be watertight. No cement grout materials are permitted.

 n. Any damage to the District's facility shall be repaired promptly by the applicant under the direction of the District's Engineer, Major damage will be repaired by the District's the applicant.
- of the District's Engineer. Major damage will be repaired by the District at the applicant's expense.

 o. All bathroom fixtures including toilets, urinals, etc., will have separate plumbing and will connect to the service line downstream of the grease trap.

 p. Backfilling of service lines trench must be accomplished within twenty-four (24) hours of inspection
- and approval. No debris will be permitted in the trench.

 q. During inspection of the service connection, the inspector will examine all District facilities such as manholes, valves, flush valves, and inlets on and adjacent to the lot. The connection permit will not be granted until any damage to these facilities has been repaired.
- r. No waste material which is not biologically degradable will be permitted to discharge into the District's sewage facilities, including mud and debris accumulated during service line installation. The applicant is to be fully responsible for cleaning and jetting the lines of any dirt or debris.

 s. No downspouts, yard and street drains, or gutters will be permitted to be connected into the District's sanitary sewer facilities.
- A connection permit will be granted after inspection confirms that all requirements of the District's Rules and Regulations have been met.
 The use of pipe or pipe fittings that contain more than 0.25 percent (0.25%) lead, or solders and flux that contain more than 0.2 percent (0.2%) lead, are prohibited for installation or repair of any plumbing in any Residential or Commercial facility providing water for human consumption and

connection to the District's water supply system.

- ----

- Construction General Notes
- Fort Bend County must be invited to the Pre-Construction Meeting.
 Contractor shall notify Fort Bend County Engineering Department 48 hours prior to commencing construction and 48 hour notice to any construction activity within the limits of the paving at Construction@fortbendcountytx.gov .
- Contractor is responsible for obtaining all permits required from Fort Bend County prior to commencing construction of any improvements within County road right of ways.
- All Paving Improvements shall be constructed in accordance with Fort Bend County "Rules, Regulations and Requirements relating to the Approval and Acceptance of Improvements in Subdivisions as currently amended.
 All road widths, curb radii and curb alignment shown indicates back of curb
- A continuous longitudinal reinforcing bar shall be used in the curbs.

 All continuous longitudinal reinforcing bar shall be used in the curbs.
- All concrete pavement shall be 5 ½ sack cement with a minimum compressive strength of 3500 psi at 28 days.
 Transverse expansion joints shall be installed at each curb return and at a maximum spacing of 60 feet.

 All weather access to all existing streets and driveways shall be maintained at all times.
- 4"x 12" reinforced concrete curb shall be placed in <u>front</u> of single family lots only. All other areas shall be 6" reinforced concrete curb.
- 10. At all intersection locations, Type 7 ramps shall be place in accordance with TXDOT Ped-12a standard detail sheet.
 A.D.A. Handicap Ramps shall be installed with street paving at all intersections and comply with current A.D.A. regulations.
- Curb headers are required at curb connections to Handicap Ramps, with no construction joint within 5' of ramps.
 All intersections utilizing Traffic Control measures shall have A.D.A. wheel chair ramps installed.
- All intersections utilizing Traffic Control measures shall have A.D.A. wheel chair ramps installed.
 Guidelines are set forth in the Texas "Manual on Uniform Traffic Control Devices", as currently amended, shall be observed. The Contractor shall be responsible for providing adequate flagmen, signing, striping and warning devices, etc., during construction both day and night.
- All R1-1 stop signs shall be 30"x30" with diamond grade sheeting per Texas manual on uniform traffic control devices.
- 15. Street name signage shall be on a 9" high sign flat blade w/reflective green background. Street names shall be upper and lowercase lettering with uppercase letters of 6" minimum and lowercase letters of 4.5" minimum. The letters shall be reflective white. Street name signs shall be mounted on stop sign post.
- 16. A Blue Double Reflectorized button shall be placed at all Fire Hydrant locations. The Button shall be placed 12 inches off of the centerline of the street on the same side as the hydrant.

NOTE: Fort Bend County notes supersede any conflicting notes.

Inspection. The Project and all parts thereof shall be subject to inspection from time to time by inspectors designated by Fort Bend County. No such inspections shall relieve the Contractor of any of its obligations hereunder. Neither failure to inspect nor failure to discover or reject any of the work as not in accordance with the drawings and specifications, requirements and specifications of Fort Bend County or any provision of this Project shall be construed to imply an acceptance of such work or to relieve the Contractor of any of its obligations becaused.

FORT BEND COUNTY ENGINEER

ENGINEER: Pie | Stangle, ff, frof

For Richard W. Stollers, P.E |

DATE 4/6/18


THESE SIGNATURES ARE VOID IF CONSTRUCTION HAS


NOT COMMENCED IN (1) YEAR FROM DATE OF APPROVAL.

APPROVED. CASCULAR |

DATE. 4/5/18

-					
_					
7	4/10/18	REVISED PER FORT BEND COUNTY M.U.D. No. 143			
7	4/10/18	REVISED PER FORT BEND COUNTY ENGINEERING			neston secur
10.	DATE	REVISIONS	BY	СК	APP

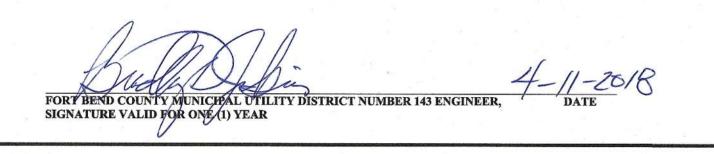

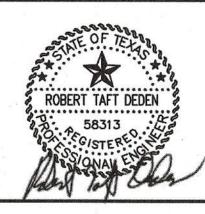

CML ENGINEERING
Texas Registered Engineering Frm F-10971

03-20-2018

CIVIL ENGINEERING
Texas Registered Engineering Firm F-10971

9328 WESTVIEW - HOUSTON, TX. 77055 (713) 461-8822 FAX (713) 461-2671 Job No.:

Drawn:


Checked:

Approved:

Scale: HORIZ.: 1" = 20'


READ KING
WATERVIEW TOWN CENTER
VILLAGE EAST
Highway 99 and Harlem Road
Richmond, Texas 77406
COVER SHEET

DATE: JANUARY 2018
SHEET 1 OF 12

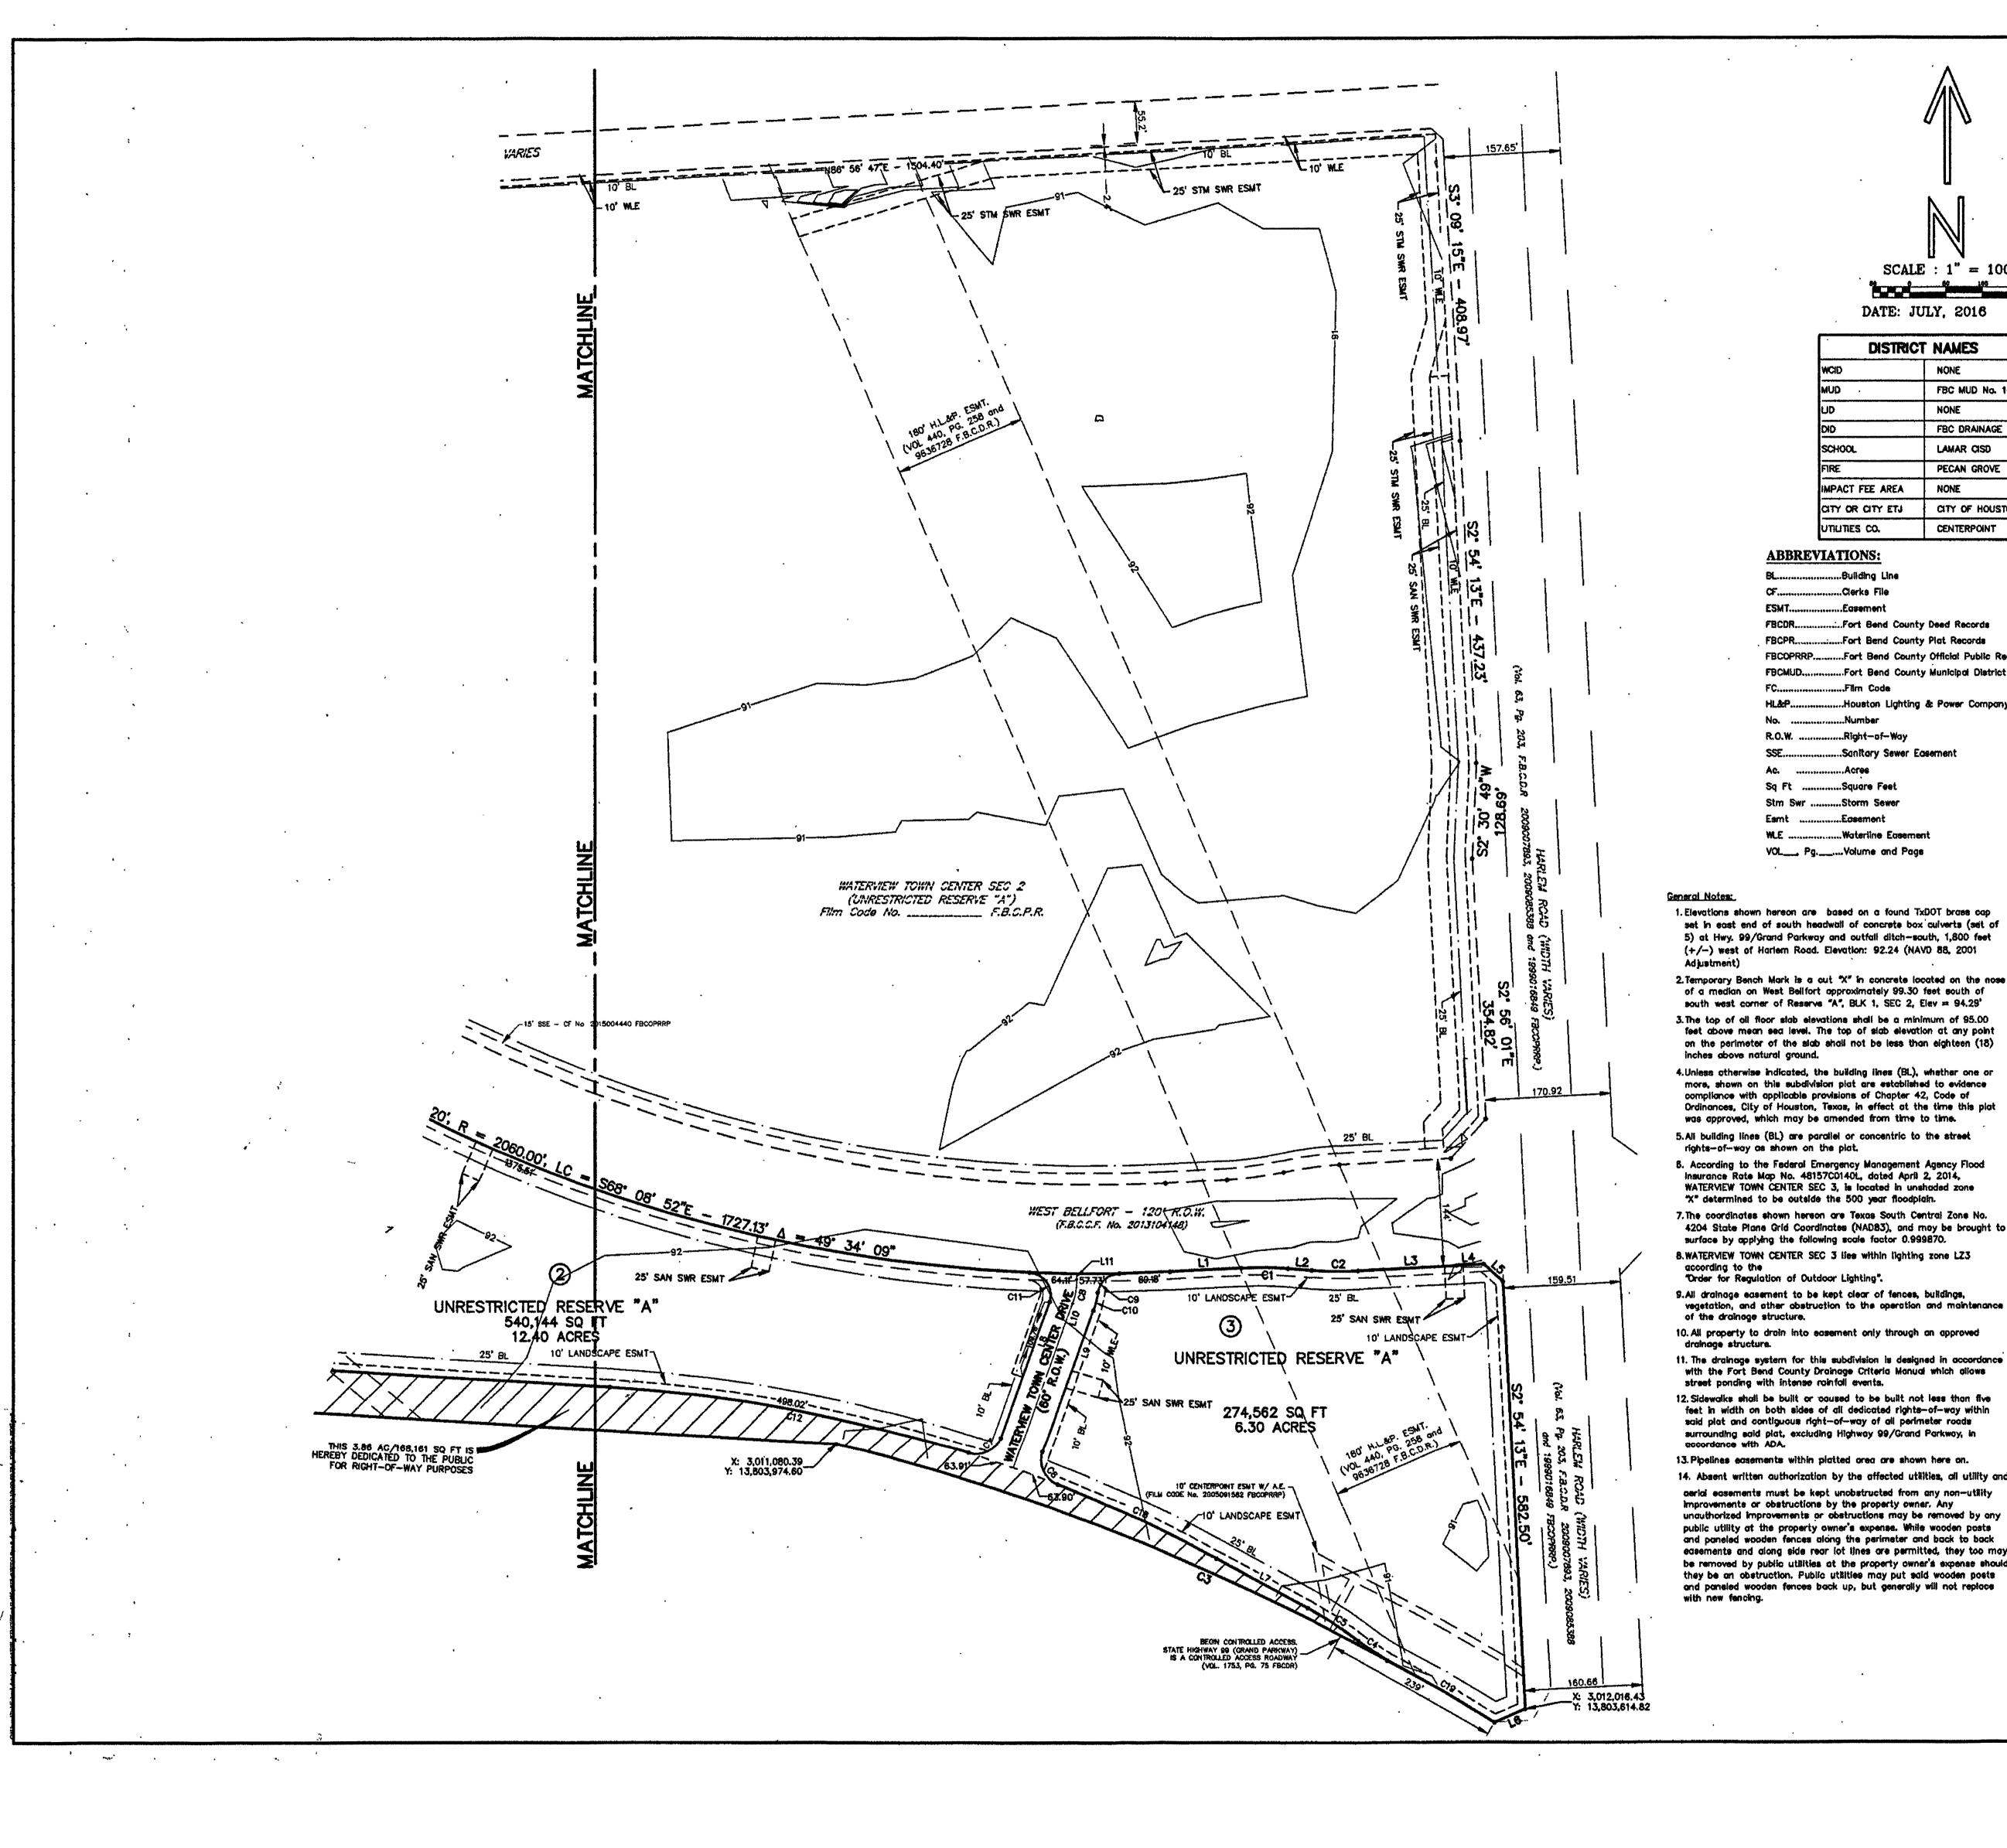

FORT BEND COUNTY MUNICIPAL UTILITY DISTRICT NUMBER 143 ENGINEER,

SIGNATURE VALID FOR ONE (1) YEAR

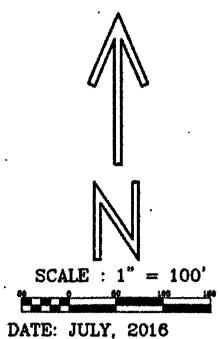

DATE: JO	11, 2010
DISTRICT	NAMES
WCID	NONE
, QUN	FBC MUD No. 143
JD.	NONE
DIC	FBC DRAINAGE
SCHOOL	LAMAR CISD
TRE	PECAN GROVE
MPACT FEE AREA	NONE
CITY OR CITY ETJ	CITY OF HOUSTON ETJ
UTILITIES CO.	CENTERPOINT

FBCMUD.....Fort Bend County Municipal District HL&P.....Houston Lighting & Power Company

R.O.W.Right-of-Way

WLEWaterline Easement

set in east end of south headwall of concrete box culverts (set of 5) at Hwy. 99/Grand Parkway and outfall ditch—south, 1,800 feet (+/-) west of Harlem Road. Elevation: 92.24 (NAVD 88, 2001

2. Temporary Bench Mark is a cut "X" in concrete located on the nose of a median on West Bellfort approximately 99.30 feet south of south west corner of Reserve "A", BLK 1, SEC 2, Elev = 94.29" 3. The top of all floor slab elevations shall be a minimum of 95.00 feet above mean sea level. The top of slab elevation at any point on the perimeter of the slab shall not be less than eighteen (18)

4. Unless otherwise indicated, the building lines (BL), whether one or more, shown on this subdivision plat are established to evidence compliance with applicable provisions of Chapter 42, Code of Ordinances, City of Houston, Texas, in effect at the time this plat

was approved, which may be amended from time to time. 5. All building lines (BL) are parallel or concentric to the street rights-of-way as shown on the plat.

8. According to the Federal Emergency Management Agency Flood Insurance Rate Map No. 48157C0140L, dated April 2, 2014, WATERVIEW TOWN CENTER SEC 3, is located in unshaded zone "X" determined to be outside the 500 year floodpigin. 7. The coordinates shown hereon are Texas South Central Zone No.

4204 State Plane Grid Coordinates (NAD83), and may be brought to surface by applying the following scale factor 0.999870. B.WATERVIEW TOWN CENTER SEC 3 lies within lighting zone LZ3


9.All drainage easement to be kept clear of fences, buildings, vegetation, and other obstruction to the operation and maintenance of the drainage structure.

10. All property to drain into easement only through an approved

12. Sidewalks shall be built or caused to be built not less than five feet in width on both sides of all dedicated rights-of-way within said plat and contiguous right—of—way of all perimeter roads

surrounding said plat, excluding Highway 99/Grand Parkway, in accordance with ADA. 13. Pipelines easements within platted area are shown here on. 14. Absent written authorization by the affected utilities, all utility and perior easements must be kept unobstructed from any non-utility

Improvements or obstructions by the property owner. Any unauthorized improvements or obstructions may be removed by any public utility at the property owner's expense. While wooden posts and paneled wooden fences along the perimeter and back to back easements and along side rear lot lines are permitted, they too may be removed by public utilities at the property owner's expense should they be an obstruction. Public utilities may put said wooden posts and paneled wooden fences back up, but generally will not replace

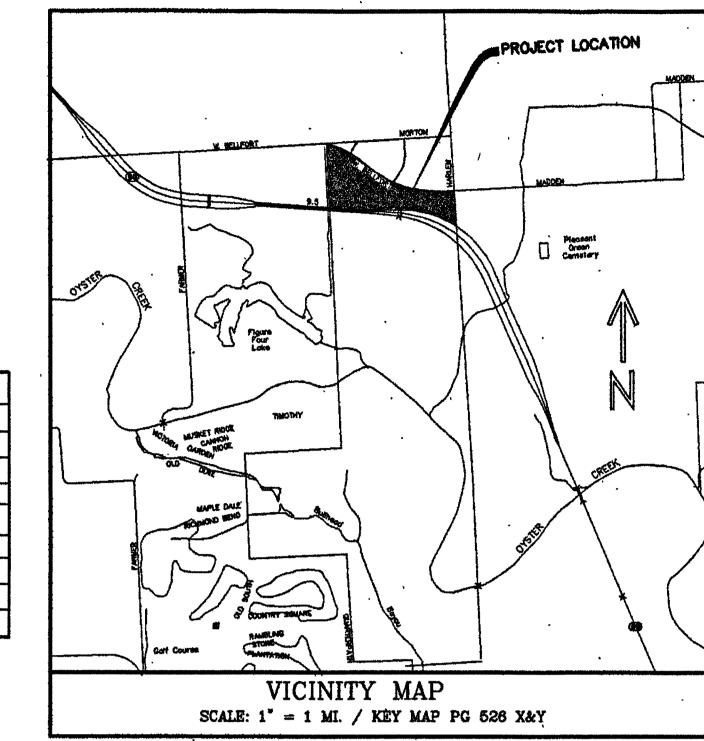

s of Reat F	roperty			
			Curve Tab	le
Curve #	Radius	Length	Delta	Chord Bearing — Distance
C1	500.00	63.35	7" 15" 35"	N89* 18' 12"W - 63.31
C2	500.00	63.35	7" 15' 35"	\$89° 18' 12"E - 63.31
C3	3064.79	974.29	18" 12" 51"	N67' 06' 07"W - 970.19
C4	485.00	47.85	5" 39" 10"	S55' 35' 04"E - 47.83
C5	515.00	82.00	9" 07" 24"	N57" 19" 11"W — B1.92
C6	35.00	53.87	88" 10" 43"	\$24' 34' 11"E - 48.70
C7	35.Q0	53.87	88* 11' 18" -	N63' 36' 13"E - 48.71
C8	100.00	33.03	18" 55' 19"	N10" 03" 30"E - 32.88
C3	30.00	42.26	80' 42' 11"	S48" 38" 25"W - 38.85
C10	130.00	25.48	11" 13" 51"	N13" 54" 15"E - 25.44
C11	30.00	56.09	107' 07' 45"	N34° 03' 18"W — 48.27
C12	2010.00	863.59	24" 37" 01"	N74" 11" 24"W - 856.96
C13	547.00	371.47	38' 54' 34"	\$22° 58' 19"W - 364.37 ·
C14	517.00	351.09	38' 54' 34"	S22' 58' 19"W - 344.38
C15	487.00	276.28	32° 30° 15″	519° 46° 10"W — 272.59
C16	160.00	17.44	6" 14" 48"	N45" 34" 18"E - 17.44
C17	130.00	28.76	12" 40" 25"	S42" 21' 29"W - 28.70
C18	2010.00	237.77	6* 46' 39"	N65' 16 ¹ 13"W - 237.63
C19	3064.79	167.30	3* 07' 39*	N59" 33" 31"W 167,28
C20	35.00	54.98	30, 00, 00 ,	N5* 59* 26"W - 49.50

C21 35.00 21.69 35° 30° 29" N68° 44° 40"W - 21.35

		Line Table)
ance	Line #	Bearing	Distance
	£.t	N87" 04" 00"E	97.56'
	1.2	S85' 40' 24"E	32.20'
	L3	N87" 04' 00"E	133.15'
	L4	N87" 15" 11"E	36.92'
	L5	\$47° 36° 52″E	35.54
	L6	567" 16" 41"W	45.86'
	L7	N61" 52" 53"W	140.90'
	LB	519" 30" 35"W	195.10
	L9	S19" 31' 10"W	206.84'
	L10	S19" 31" 10"W	240.80*
	- L11	S0° 35' 51"W	7.77
	. L12	S1" 52" 44"E	35.90'
	L13	S42" 25' 36"W	80.18
	L15	N86" 42' 37"E	35.81*
	L16	S48" 41' 42"W	55.30
	L17	\$32° 55′ .30″W	377.35° _.
	L18	53° 30' 06"W	21.82*
	Ł19	N86" 29" 54"W	436.09
	L20	N86' 29' 54"W	427.07 ⁴
	L21	S86' 29' 54"E	392.95'
	1.22	N2" 01" 36"W	29.68'
	L23	N50" 59" 26"W	41.13'

FILED AND RECORDED OFFICIAL PUBLIC RECORDS



Laura Richard, County Clerk Fort Bend County, Texas

WATERVIEW TOWN CENTER SEC 3

A SUBDIVISION OF 60.4787 ACRES OF LAND SITUATED IN THE THE WILLIAM MORTON LEAGUE SURVEY, A-62 FORT BEND COUNTY, TEXAS

3 BLOCKS 3 RESERVES 0 LOTS


* OWNER * 99 GRAND MISSION, LLC * SURVEYOR *

Prejean & Company, Inc. # LAND PLANNER * 713-461-8822

M2L ASSOCIATES INC. ' ROSE MAINER

SHEET 2 OF

BY CK APP NO. DATE

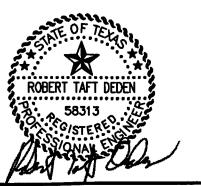

DEDEN SERVICES, LLC


CIVIL ENGINEERING
Texas Registered Engineering Firm F-10971


9328 WESTVIEW HOUSTON, TX. 77055 (713) 461-8822 FAX (713) 461-2671


Job No.:	
Drawn:	W
Checked:	
Approved:	
Scale: N.T.S.	


READ KING WATERVIEW TOWN CENTER VILLAGE EAST Highway 99 and Harlem Road Richmond, Texas 77406 SUBDIVISION PLAT

DATE: JANUARY 2018 SHEET 2 OF 12

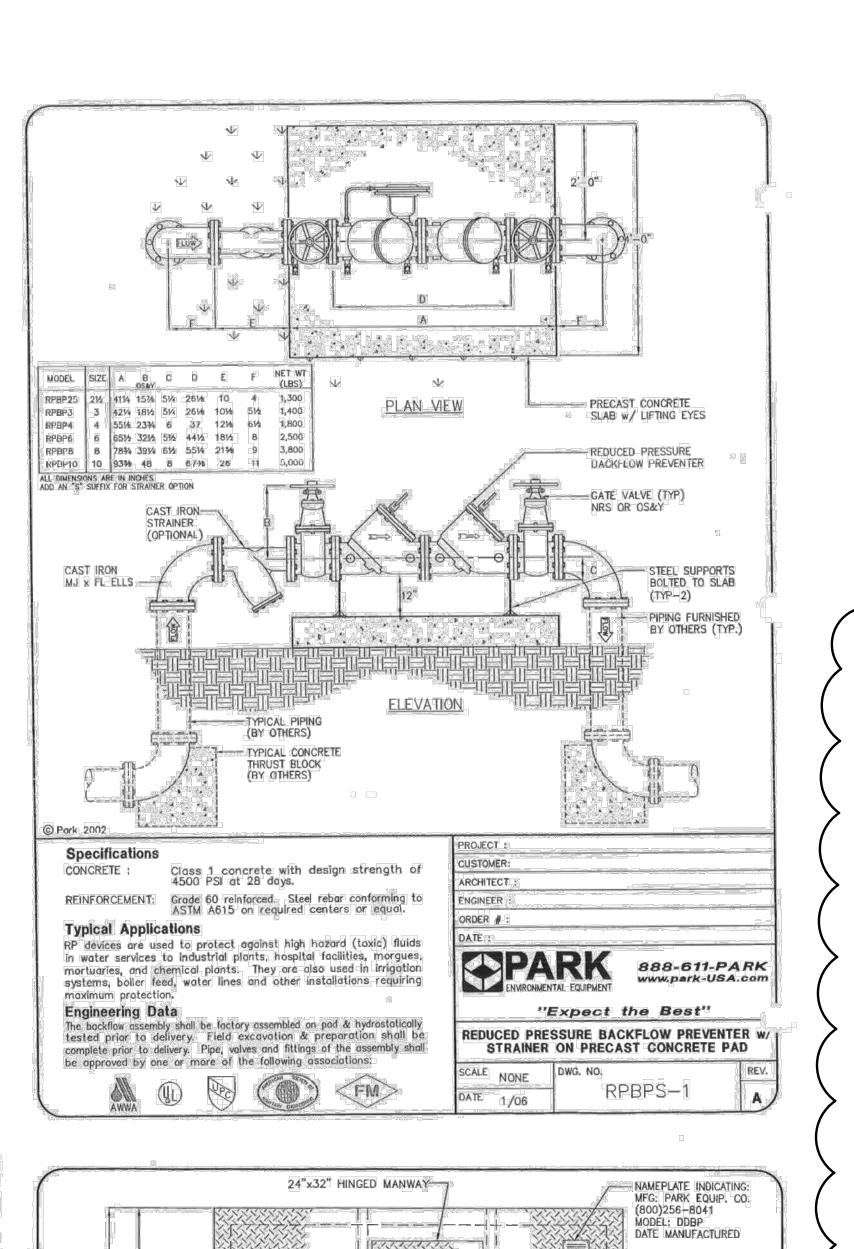

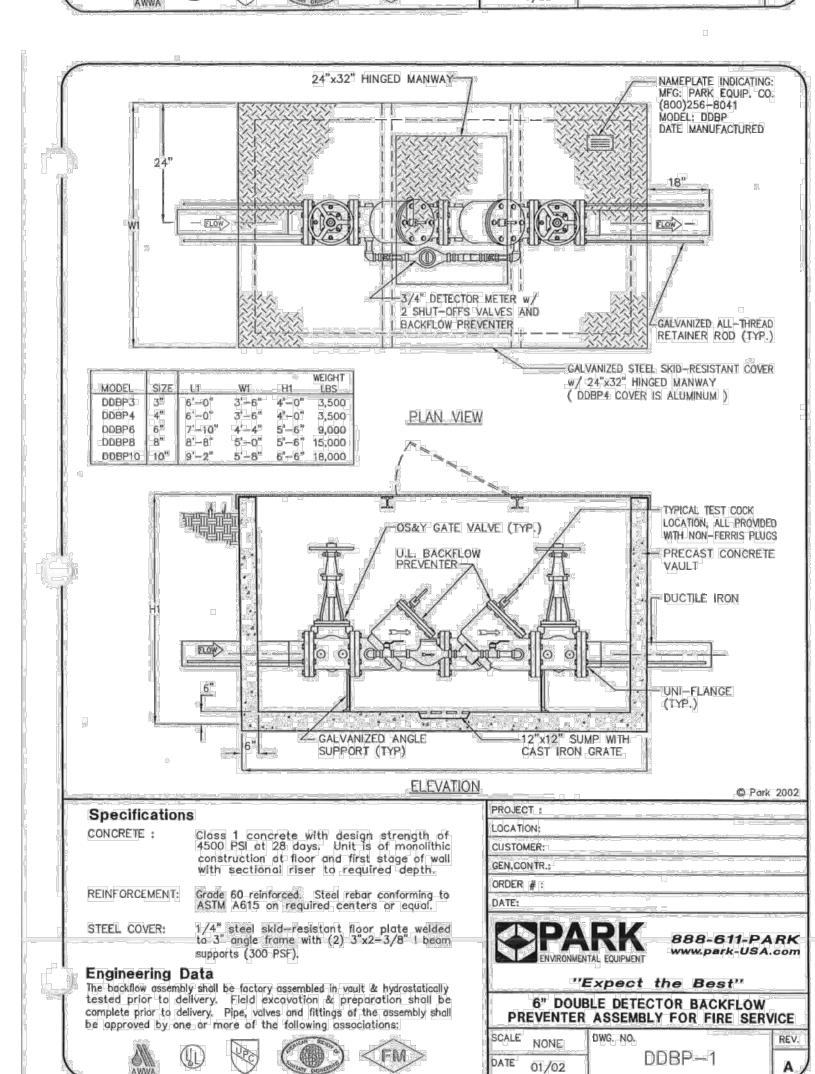

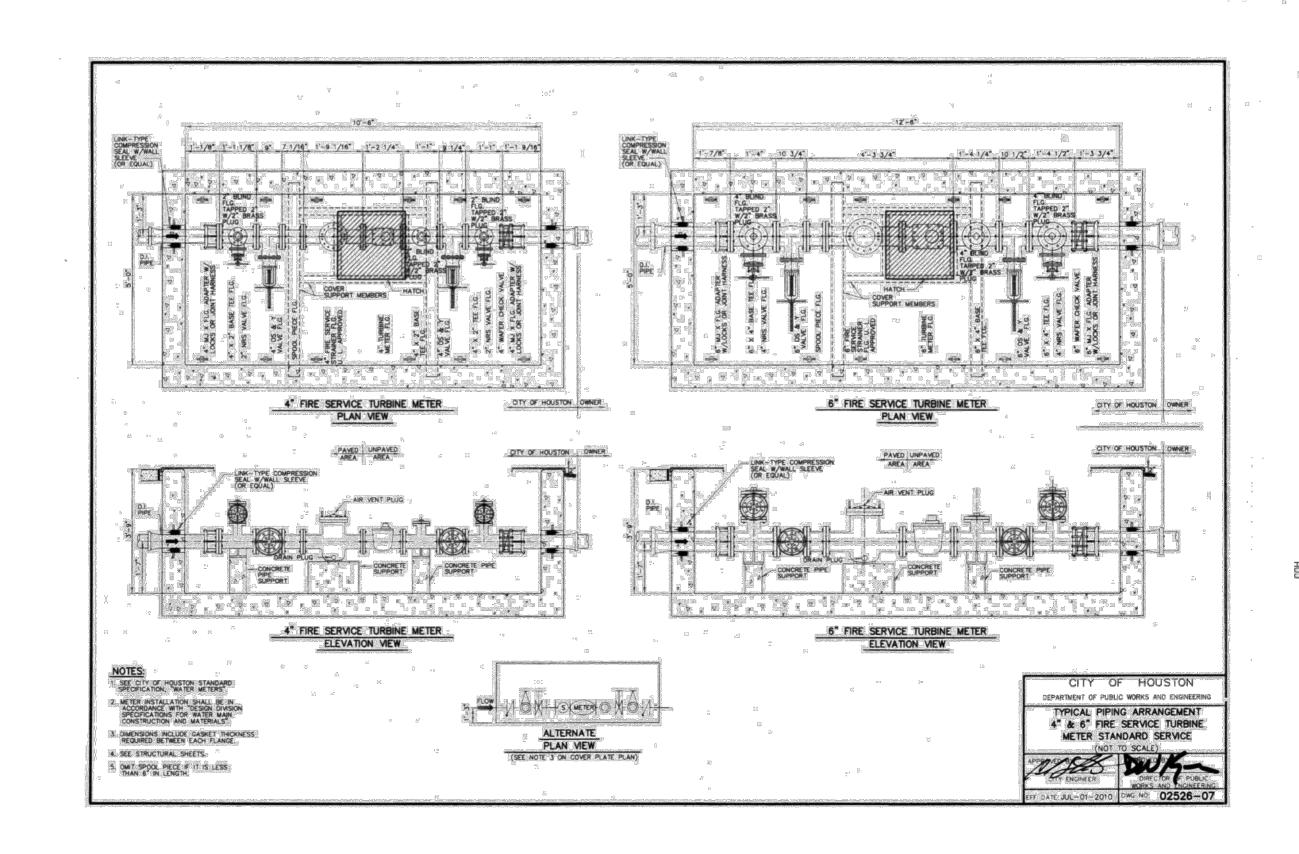

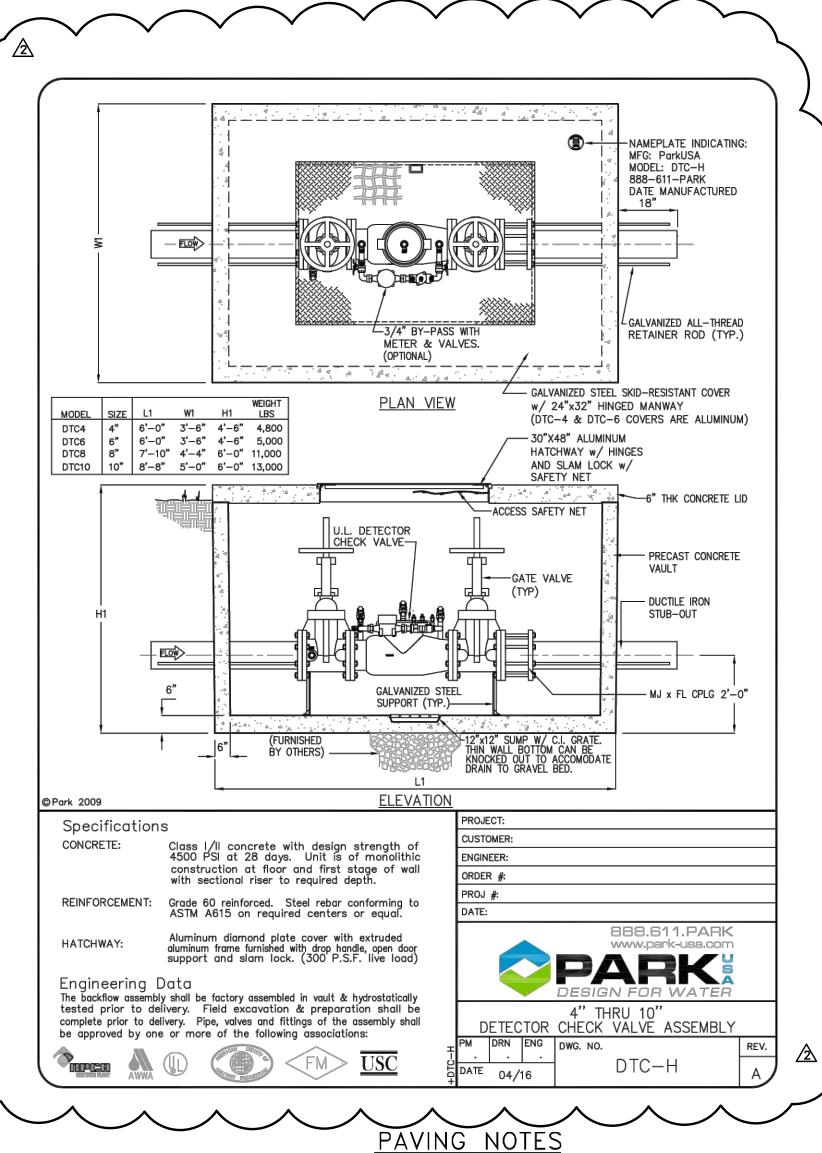

1. FAILURE TO MEET THE REQUIREMENTS THROUGH THE TESTING PROCEDURE WILL RESULT IN THE REJECTION OF THAT PORTION DEEMED TO BE DEFICIENT. THE PROPOSED PAVEMENT DEPTHS SHOWN ON THE PLAN DETAIL SHEETS IS CONSISTENT WITH THESE NOTES AND SHALL BE USED TO DETERMINE THE REQUIREMENT IN EACH

2. FAILURE OF A PAVEMENT TO MEET THESE MINIMUM REQUIREMENTS WILL RESULT IN

3. PAVEMENTS EXCEEDING DEPTH OR STRENGTH REQUIREMENTS WILL BE ACCEPTED IF

4. TRANSVERSE EXPANSION JOINTS ARE REQUIRED AT MAXIMUM SPACING OF 40'-0" C-C. WITH JOINTS AND VERTICAL CURB JOINTS TO BE SEALED WITH LIQUID RUBBER

THE REJECTION OF PAVEMENT, IMMEDIATE REMOVAL AND REPLACEMENT OF SUBSTANDARD PAVEMENT SECTIONS WILL BE NECESSARY TO SATISFY THESE

5. DENSITY TESTING SHALL BE DONE IMMEDIATELY PRIOR TO PLACEMENT OF

6. CONCRETE CYLINDERS @ 4 EACH, SLUMP, AND AIR ENTRAINMENT TESTS ARE

8. ALL CONCRETE SHALL BE 4000 PSI COMPRESSIVE STRENGTH AT 28 DAYS.

9. ALL SUBGRADE SHALL BE PREPARED ACCORDING TO SOILS REPORT AND

7. CONTRACTOR TO SUBMIT CONSTRUCTION JOINT AND EXPANSION JOINT PLAN TO

STEEL SHALL BE #4 REBAR ON 18-INCHES C-C, E.W.. ALL CAR AREAS SHALL BE 6-INCH REINFORCED CONCRETE AND TRUCK AREAS SHALL BE 8-INCH REINFORCED

COMPACTED TO A MINIMUM OF 95% STANDARD PROCTOR DENSITY UNDER CONCRETE

AREAS AND 90% STANDARD PROCTOR DENSITY IN LANDSCAPE OR DETENTION AREAS.


BOTH CRITERIA MEET THE MINIMUM ESTABLISHED REQUIREMENTS.


REINFORCING STEEL FOR CONCRETE PAVING.


CONCRETE.

REQUIRED FOR EACH 150 CY. OF CONCRETE PAVING.

OWNER FOR APPROVAL PRIOR TO CONSTRUCTION.

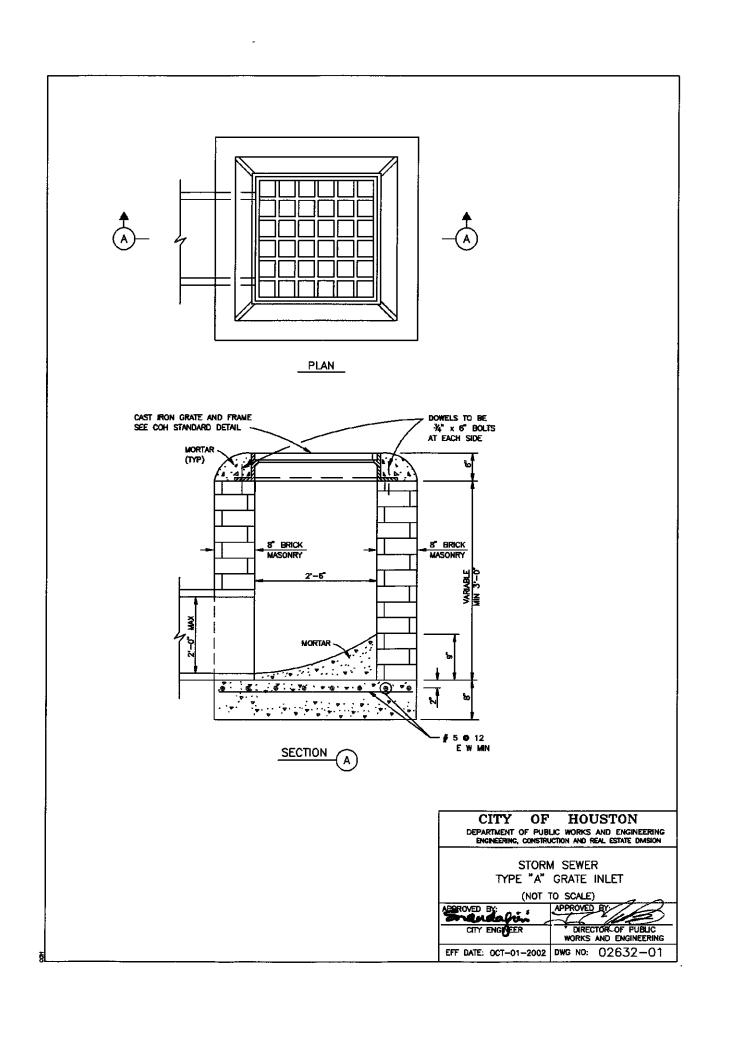

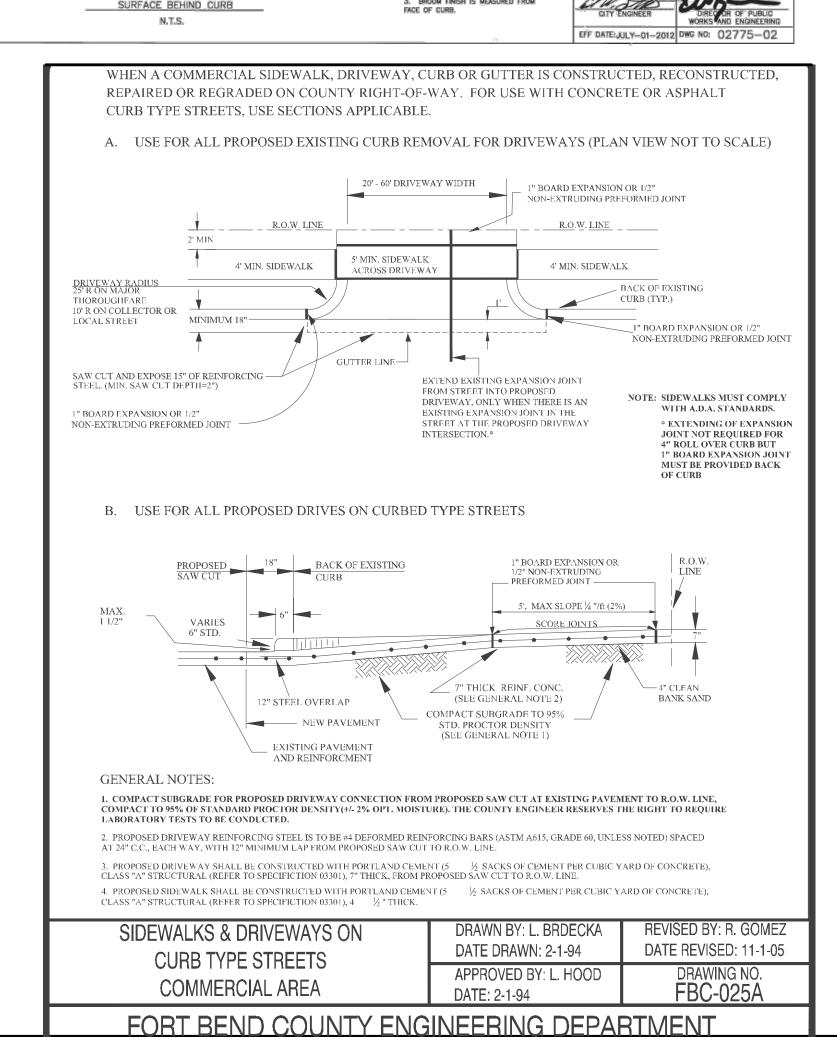

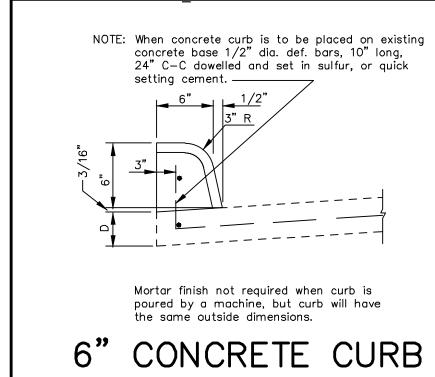

A MIN OF B" INTO ROADWAY

AS REO'D. SLOPE AS REO'D.

STREETS WITH NON-WALKING

SLOPE 1:50

GROOVED SURFACE

SINDE 1:10

GROOVED SURFACE

SINDE 1:11

SINDE 1:12

ACHIEVE 1:12

MAX

TRUNCATED DOMES

6° MINI TO 10° MAX OF BROOM
FINISH ONLY

ACHIEVE 1:12

MAX

#4 Bars @ 18" O.C.E.W. Concrete `8" Subgrade To Be Lime Stabilized w/8% Lime/Flayash per Soils Report. Subgrade To Then Be Compacted To 95% Standard Proctor Density (ASTM 698) CONCRETE THICKNESS = 6" or 8" AS SHOWN ON PLANS

L6" MIN. RAMP

6" MIN TO 10" MAX OF BROOM FINISH ONLY

DEPARTMENT OF PUBLIC WORKS AND ENGINEERING

WHEEL CHAIR RAMP DETAILS


ELEVATION LOOKING UP RAMP

RAMP CONSTRUCTION FOR EXISTING PAVEMENT

GROOVED EXPANSION JOINT

3. BROOM FINISH IS MEASURED FROM

CONCRETE PAVEMENT

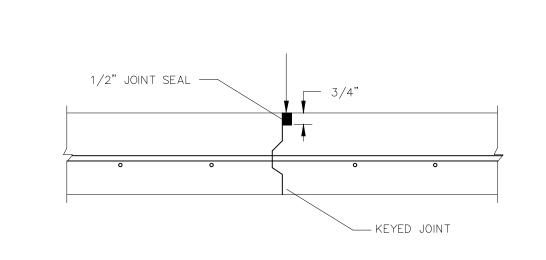

CONSTRUCTION JOINT SEAL AND KEYWAY

Not To Scale

OR PLASTIC CAP 1" BOARD EXPANSION JOINT FILLER -(REDWOOD) PAVING EXPANSION JOINT STEEL TO MEET A.S.T.M. STD THE END OF EACH CURB RADIUS AND SPECIFICATION FOR CONCRETE REINFORCING BARS. UNITS TO SPACED APPROXIMATELY 40' APART. BE SPACED AT 16" O.C. Not To Scale

DEVELOPMENT COORDINATOR 4-518

4/10/18 | REVISED PER FORT BEND COUNTY M.U.D. No. 143 /1\ | 4/10/18 | REVISED PER FORT BEND COUNTY ENGINEERING NO. DATE REVISIONS BY CK APP

SIGNATURE VALID FOR ONE (1) YEAR



DEDEN SERVICES, LLC CIVIL ENGINEERING Texas Registered Engineering Firm F-10971


03-20-2018

Job No.: 9328 WESTVIEW HOUSTON, TX. 77055 (713) 461-8822 FAX (713) 461-2671

Drawn: Checked: Approved: Scale: AS SHOWN

READ KING WATERVIEW TOWN CENTER VILLAGE EAST **Highway 99 and Harlem Road** Richmond, Texas 77406 NOTES AND DETAILS

DATE: JANUARY 2018

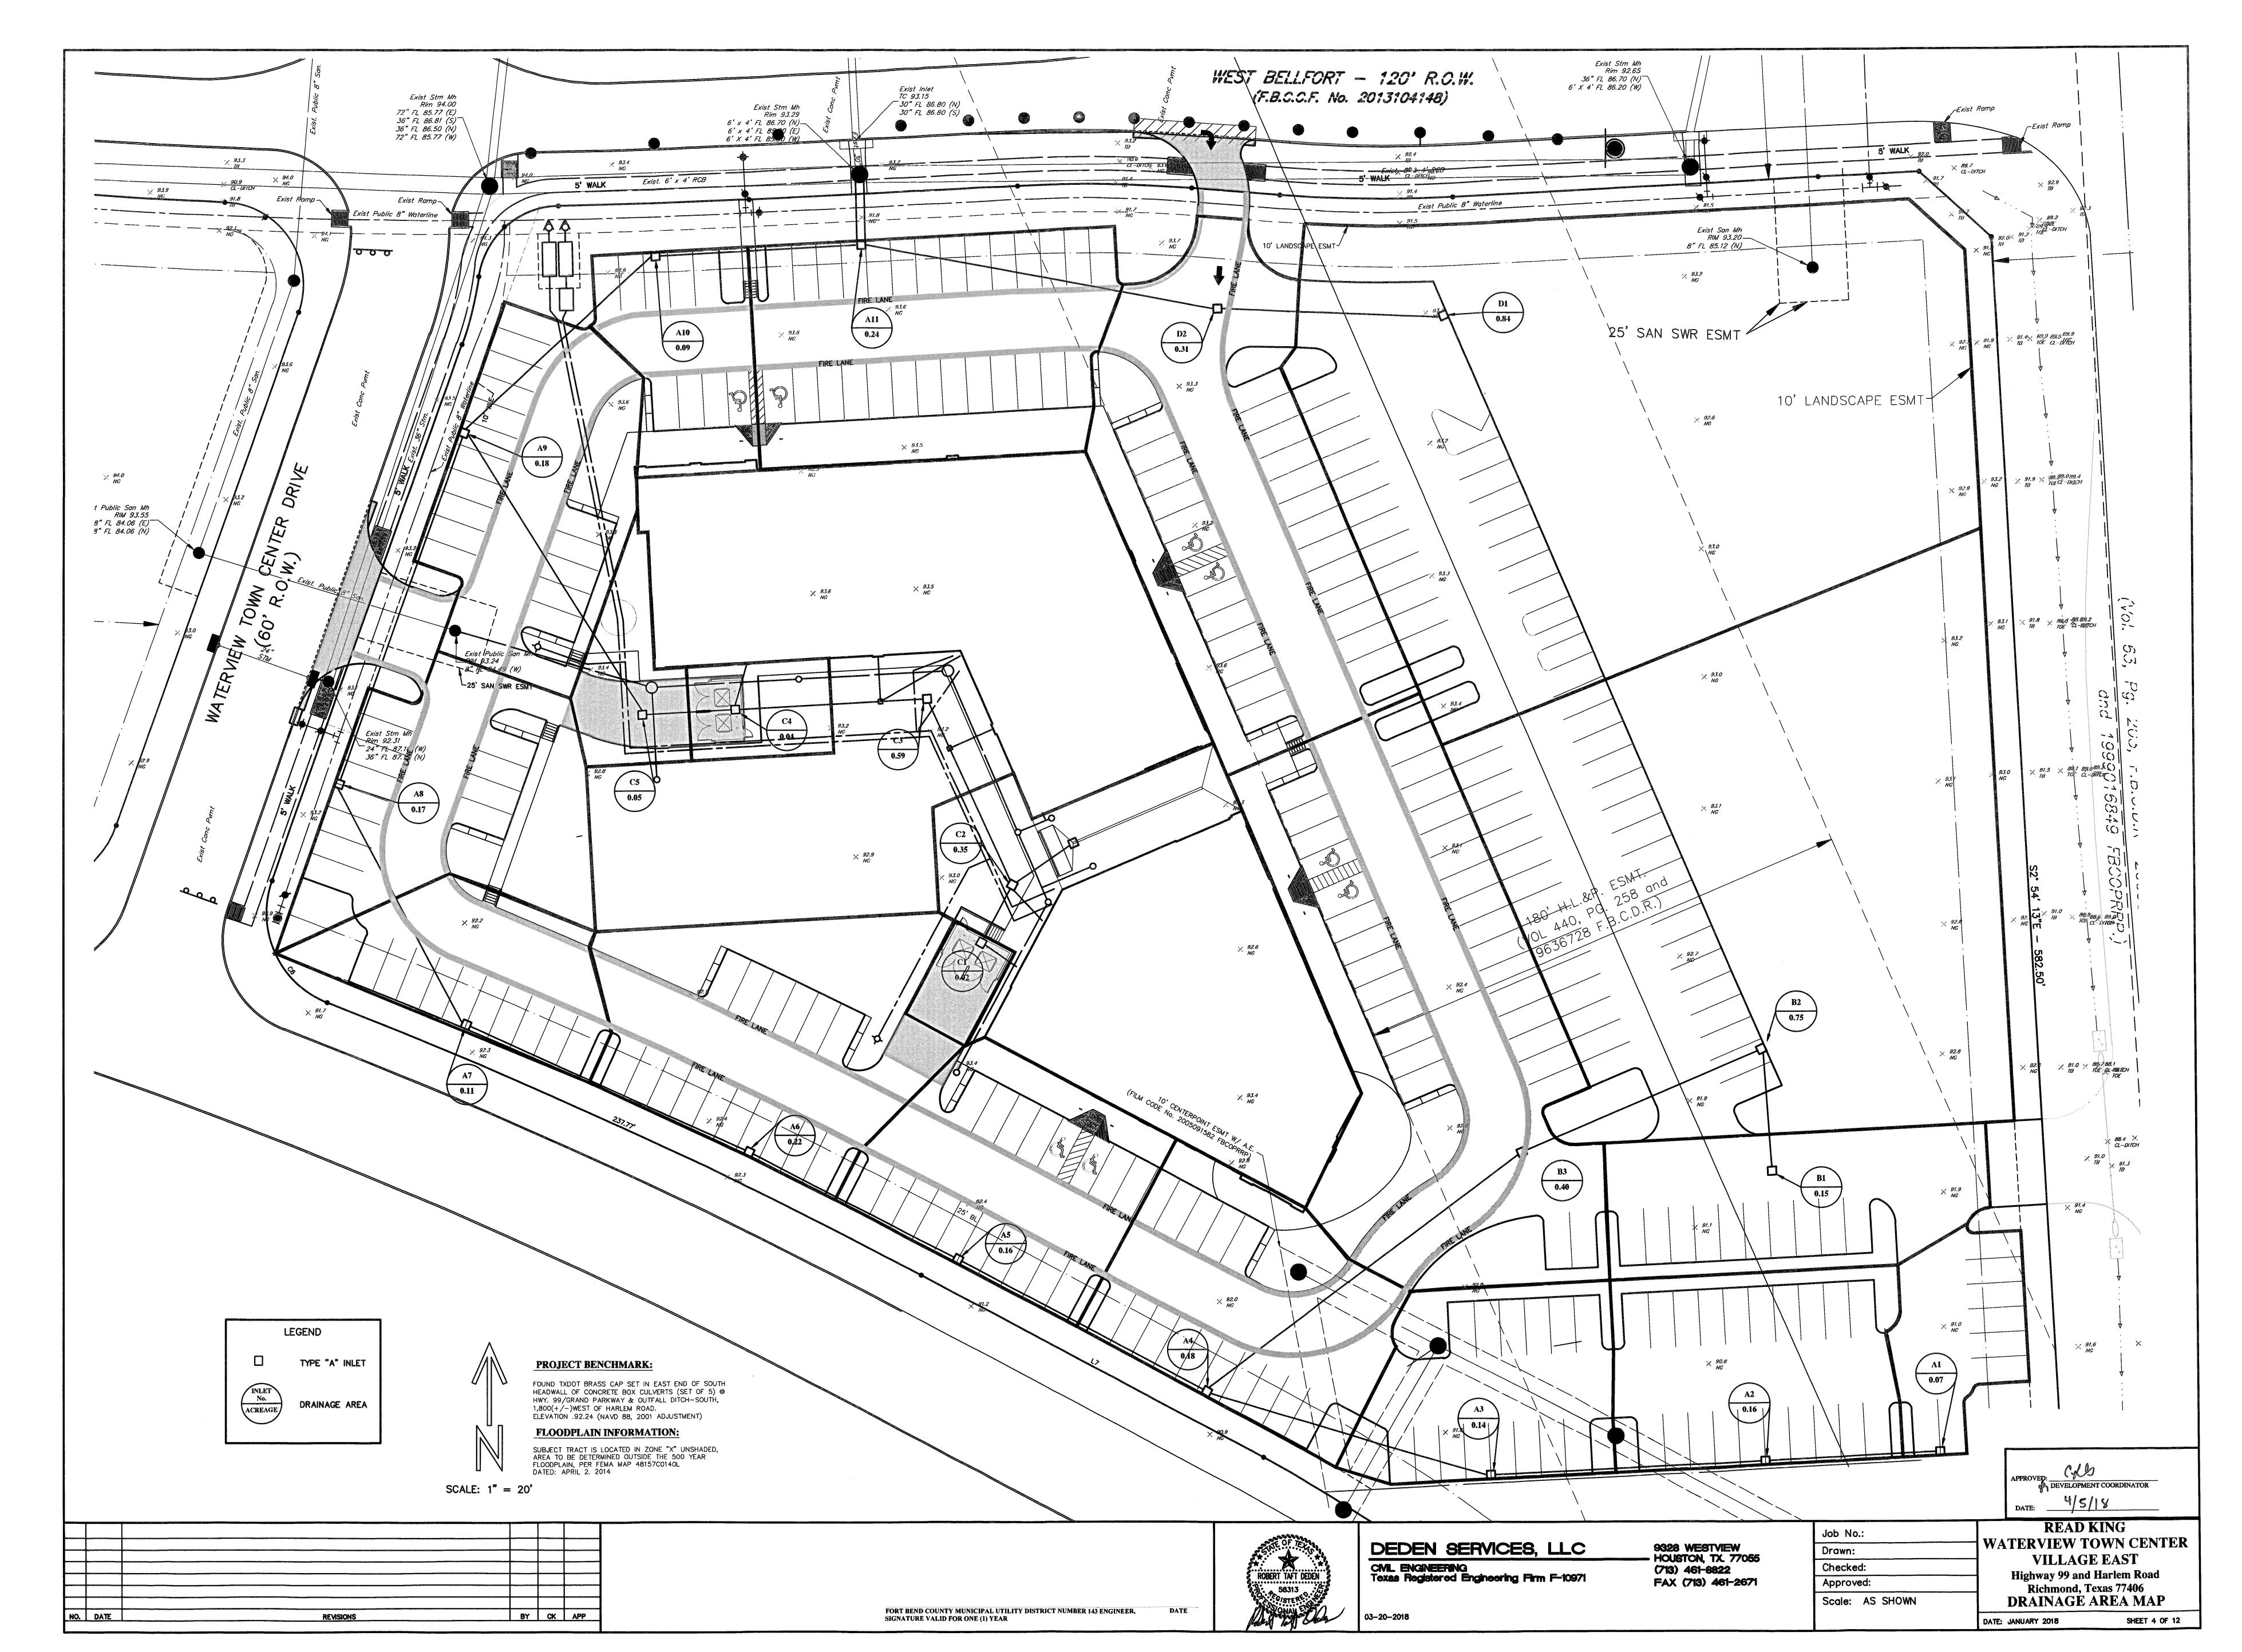

LJA Engineering, Inc. Project: 99 Grand Mission Collector Roads - Waterview Town Center Village East COH 2 YR LJA Job No. 2145-2119D - 2145-2128 16.2 System: Storm Date: 10/13/2015 & 02/22/2017 LINE A,B,C,D,F,G,J,K,L 25-YR W.S.E. 0.8315 Checked by: LINE E 25-YR W.S.E. 81.09 Design Frequency: 2 years 2 YR D.S. FLOWLINE ACT.V SLOPE delta H ELEV. HYD. GRAD. TG HG DIST
V FALL UP- DOWN- fps HYD. ft UP- DOWN- INLET UP- BELOW TG REACH fps (ft) STREAM STREAM GRAD. (%) in FT FT % cfs SYSTEM 2 LINE B

 2
 0.00
 3.43
 27.42
 3.25
 0.80
 2.60
 9.04
 9.04
 303

 3
 0.00
 8.51
 29.58
 3.12
 0.80
 2.50
 13.15
 22.19
 135

 4
 5.55
 14.06
 30.93
 3.05
 0.80
 2.44
 0.00
 35.72
 185

 5
 0.00
 14.06
 30.93
 3.05
 0.80
 2.44
 0.00
 35.72
 181

 6
 0.00
 18.81
 31.77
 3.00
 0.80
 2.40
 12.36
 48.08
 191

 7
 0.00
 18.81
 31.77
 3.00
 0.80
 2.40
 0.00
 48.08
 214

 8
 0.00
 25.23
 32.66
 2.96
 0.80
 2.37
 16.49
 64.57
 227

 9
 5.16
 30.39
 33.24
 2.93
 0.80
 2.34
 0.00
 76.65
 305

 10
 0.00
 30.39
 33.24
 2.93
 0.80
 2.34
 0.00
 76.65
 21

 JUNCTION BOX
 0.00

 6
 4
 0.10
 97.97
 4.1
 0.00
 86.20
 85.90
 0.38
 0.001
 0.003
 91.38
 92.50
 1.12

 6
 4
 0.10
 97.97
 4.1
 0.00
 85.90
 85.77
 0.92
 0.005
 0.007
 91.38
 91.37
 93.15
 1.77

 6
 4
 0.10
 97.97
 4.1
 0.00
 85.77
 85.58
 1.49
 0.013
 0.024
 91.37
 91.35
 93.80
 2.43

 6
 6
 0.10
 170.52
 4.7
 0.00
 85.27
 85.09
 0.99
 0.004
 0.008
 91.34
 93.80
 2.43

 6
 6
 0.10
 170.52
 4.7
 0.00
 85.27
 85.09
 0.99
 0.004
 0.008
 91.34
 93.80
 2.45

 6
 6
 0.10
 170.52
 4.7
 0.00
 85.09
 84.90
 1.34
 0.008
 0.015
 91.34
 91.32
 92.50
 1.16

 SYSTEM 2
LINE BA
A1 A2 0.07 0.07 21.28 3.89 0.80 2.95 0.00 0.21 63 18 0.3000 5.77 3.3 0.00 88.40 88.21 0.12 0.00 0.000 91.50 91.50 92.50 1.00 A3 0.17 0.24 22.78 3.57 0.80 2.85 0.00 0.89 99 18 0.3000 5.77 3.3 0.00 88.21 87.91 0.39 0.004 0.004 91.50 91.50 92.50 1.00 A4 0.14 0.38 22.43 3.52 0.80 2.81 0.00 1.09 107 18 0.3000 5.77 3.3 0.00 87.59 9.61 0.011 0.011 91.50 91.49 92.50 1.00 A5 0.16 1.84 26.13 3.33 0.80 2.66 0.00 1.51 102 24 0.2000 10.14 3.2 0.00 87.59 97.39 0.48 0.001 0.014 91.48 91.48 92.50 1.01 A7 0.22 2.23 26.52 3.31 0.80 2.66 0.00 1.96 85 24 0.2000 10.14 3.2 0.00 87.39 87.22 0.62 0.07 0.06 91.48 91.48 92.50 1.02 A7 0.22 2.23 26.52 3.31 0.80 2.64 0.00 2.55 113 24 0.2000 10.14 3.2 0.00 87.29 86.99 0.81 0.013 0.014 91.48 91.48 92.50 1.02 A9 0.18 0.11 2.34 26.61 3.30 0.80 2.64 0.00 2.84 99 24 0.2000 10.14 3.2 0.00 87.29 86.99 0.81 0.013 0.014 91.48 91.46 92.80 1.32 A9 0.18 2.52 28.77 3.29 0.60 2.63 0.00 3.31 135 24 0.2000 10.14 3.2 0.00 86.99 86.99 0.81 0.013 0.014 91.48 91.46 92.80 1.54 A9 0.18 2.52 28.77 3.29 0.80 2.63 0.00 3.31 135 24 0.2000 10.14 3.2 0.00 86.99 86.99 0.81 0.013 0.014 91.48 91.46 91.45 9
 0.15
 0.15
 22.16
 3.62
 0.80
 2.89
 0.00
 0.43
 45
 18
 0.3000
 5.77
 3.3
 0.00
 88.37
 0.25
 0.002
 0.001
 91.58
 92.60
 1.02

 0.75
 0.90
 24.82
 3.42
 0.80
 2.74
 0.00
 2.49
 96
 18
 0.3000
 5.77
 3.3
 0.00
 88.37
 88.08
 1.40
 0.056
 0.053
 91.58
 91.52
 92.60
 1.02

 0.40
 1.30
 25.47
 3.37
 0.80
 2.70
 0.00
 3.57
 144
 24
 0.3000
 12.42
 4.0
 0.00
 88.08
 1.13
 0.025
 0.035
 91.52
 91.49
 92.80
 1.28

 0.02
 0.02
 20.02
 3.79
 0.80
 3.03
 0.00
 0.06
 24
 18
 1.0000
 10.53
 6.0
 0.00
 89.52
 89.28
 0.03
 0.00
 91.58
 93.80
 2.22

 0.35
 0.37
 23.39
 3.52
 0.80
 2.82
 0.00
 1.05
 74
 18
 1.0000
 10.53
 6.0
 0.00
 89.28
 88.54
 0.59
 0.010
 0.007
 91.58
 93.80
 2.22

 0.59
 0.96
 24.93
 3.41
 0.80
 2.73
 0.00
 2.66
 70
 18
 1.0000
 10.53
 6.0
 0.00
 88.54
 67.84
 1.50
 0.063
 0.044
 91.58
 93.80
 2.22

 0.04
 1.00
 25.00
 3.41
 0.80
 2.73
 0.00
 2.77
 34
 18
 0.3000
 5.77
 3.3
 0.00
 87.84
 87.74
 1.56
 0.069
 0.023
 91.51
 93.80
 2.27

 0.05
 LJA Engineering, Inc. Project: 99 Grand Mission Collector Roads - Waterview Town Center Village East **COH 100 YR** 125.4 LJA Job No. 2145-2119D - 2145-2128 21.8 By: AB & MEF Date: 10/13/2015 & 02/22/2017 0.75 LINE A,B,C,D,F,G,J,K,L 5-YR W.S.E. 91.24 LINE E 5-YR W.S.E. 81.09 Design Frequency: 100 (1.25) yr years

FROM	то	ADDED	TOTAL	TC	Intensity	C	CI	Additional	CUM	REACH		LINE/BOX			DESIGN		D.S.	OTHER	FLOWLI	IE AC	T.V SLOPE	E delta H	ELEV H	HYD. GRAD.	TG	HG
JUNCTION	JUNCTION	AREA			microny		- 0:		D(100 YR1.25		SIZE	WIDTH	HEIGHT	SLOPE	Q	V	FALL	LOSSES	UP- D		awayada da aya aya aya aya aya aya aya aya	ft		DOWN-		
		ac	ac					cfs	cfs		in	P T	FT	%	cfs	fps	(ft)	ft	STREAM ST		GRAD. (%)		M STREAM		
SYSTEM 2				****						twister and the second		and the same of th		The second secon			· · · · · · · · · · · · · · · · · · ·							Name and Association of the Contract of the Co	***************************************	
LINE B																										
1	2	0.00	3.43	27.42	3.25	0.80	2.60	0.00	50.04	303		6	4	0.10	97.97	4.08	0	0	86.20	35.90 2.0	9 0.026	0.079	93.28	93.20	92.50	
2	3	0.00	8.51	29.58	3.12	0.80	2.50	0.00	104.20	135		6	4	0.10	97.97	4.08	0	0	85.90	35.77 4.	4 0.113	0.151	93.20	93.05	93.15	
3	4	5.55	14.06	30.93	3.05	0.80	2.44	0.00	127.72	185		6	4	0.10	97.97	4.08	0	0	85.77	35.58 5.3	2 0.169	0.312	93.05	92.74	93.80	
4	5	0.00	14.06	30.93	3.05	0.80	2.44	0.00	127.72	181		6	6	0.10	170.52	4.74	0	0	85.27	35. 09 3.	55 0.056	0.101	92.74	92.64	93.80	
5	6	0.00	18.81	31.77	3.00	0.80	2.40	0.00	181.08	191		6	6	0.10	170.52	4.74	0	0	85.09	34.90 5.0	0.112	0.215	92.64	92.43	92.50	
6	7	0.00	18.81	31.77	3.00	0.80	2.40	0.00	181.08	214		7	6	0.10	209.01	4.98	0	0	84.39	34.18 4.:	0.075	0.160	92.43	92.27	93.30	
7	8	0.00	25.23	32.66	2.96	0.80	2.37	0.00	238.57	227		7	6	0.10	209.01	4.98	0	0	84.18	33.96 5.	8 0.130	0.294	92.27	91.97	92.50	
8	9	5.16	30.39	33.24	2.93	0.80	2.34	0.00	291.66	305		7	6	0.10	209.01	4.98	0	0	83.96	33.65 6.	0.194	0.591	91.97	91.38	92.50	
9	10	0.00	30.39	33.24	2.93	0.80	2.34	0.00	291.66	82		8	6	0.10	248.53	5.18	0	0	75.30	75.22 6.	8 0.137		91.38		93.40	
10	JUNCTION BOX	0.00	30.39	33.24	2.93	0.80	2.34	0.00	291.66	21		8	6	0.10	248.53	5.18	0	0	83.64	33.62 6.	0.137	0.029	91.27	91.24	93.20	
SYSTEM 2																										
LINE BA						S										<u> </u>										
A1	A2	0.07	0.07	21.26	3.69	0.80	2.95	0.00	0.21	63	18			0.30	5.77	3.26	0	0	88.40			the second se				
A2	A3	0.17	0.24	22.78	3.57	0.80	2.85	0.00	0.68	99	18			0.30	5.77	3.26	0	0		37.91 0.		The second second second			92.50	
A3	A4	0.14	0.38	23.43	The second secon	0.80	2.81	0.00	1.07	107	18		The state of the s	0.30	5.77	3.26	0	0			0.010			93.86		
A4	A5	0.16	1.84	26.13	the second secon	0.80	2.66	0.00	4.90	102	24			0.20	10.14	3.23	0	0			6 0.047				92.50	
A5	A6	0.17	2.01	26.31	3.32	0.80	2.66	0.00	5.34	85	24		and the same of th	0.20	10.14	3.23	0	0		37.22 1.					92.50	
A6	A7	0.22	2.23	26.52	3.31	0.80	2.64	0.00	5.90	113	24			0.20	10.14	3.23	0	0			0.067			93.69		_
A7	A8	0.11	2.34	26.61	3.30	0.80	2.64	0.00	6.18	99	24		100-77-2-2-2-2-2-2-2-2-2-2-2-2-2-2-2-2-2-	0.20	10.14	3.23	0	0		36.79 1.	0.074					<u> </u>
A8	A9	0.18	2.52	26.77	3.29	0.80	2.63	0.00	6.63	135	24			0.20	10.14	3.23	0	0		36.52 2.				93.50	93.00	
A9	A10	0.02	3.59	27.52	3.24	0.80	2.59	0.00	9.31	95	24			0.20	10.14	3.23	0	0		36.09 2.					93.00	
A10	A11	0.09	3.68	27.58	3.24	0.80	2.59	0.00	9.53	75	24			0.20	10.14	3.23	0	0			0.176				93.50	
A11	Ex B2	0.09	4.92	28.24	3.20	0.80	2.56	0.00	12.59	26	36			0.10	21.15	2.99	0	1 0	85.93	35.90 1.	78 0.035	0.009	93.21	93.20	93.00	
LINE BB		·	<u> </u>				T											T	T 00 50 T			1 2001	T 00.00	20.05	T 60.00	
<u>B1</u>	B2	0.15	0.15		3.62	0.80	2.89	0.00	0.43	45	18		Magazina de la companya de la compa	0.30	5.77	3.26	0	<u> </u>		38.37 O.	25 0.002	*			92.60	
82	B3	0.75	0.90	24.82	3.42	0.80	2.74	0.00	2.46	96	18		· · · · · · · · · · · · · · · · · · ·	0.30	5.77	3.26	0	0	88.37					93.90	92.60	
B3	A4	0.40	1.30	25.47	3.37	0.80	2.70	0.00	3.51	144	24			0.30	12.42	3.95			80.88	87.65 1.	12 0.024	0.034	93.90	93.86	85.80	
LINE BC	44	T 000		1 66 66			A AA	1 000	0.00	A.	14			4 44	40.50	P 00			00.50	20.00 6	20 1 2000	0.000		00.07	T 00.00	т-
<u>C1</u>	C2	20.0		20.02	3.79	0.80	3.03	0.00	0.06	24	18			1.00	10.53	5.96	<u> </u>	<u> </u>			0.000			93.67		
CS	C3	0.35		23.39		0.80	2.82	0.00			18			1.00	10.53	5.96	<u> </u>	<u> </u>			59 0.010			93.66		
<u>C3</u>	C4	0.59		24.93		0.80	2.73	0.00	2.62		18			1.00	10.53	5.96	<u> </u>	<u> </u>			18 0.062			93.62		
C4	C5	0.04		25.00		0.80	2.73	0.00	2.73	34	18			0.30	5.77	3.26	1 0	1 0			54 0.067			93.59		
<u>C5</u>	<u>A9</u>	0.05	<u> 1.05</u>	25.09	3.40	0.80	2.72	0.00	2.86	122	18			0.30	5.77	3.26		1 0	87.74	5/.3/ 1.	61 0.073	L 0.089	93.59	93.50	<u> </u>	
A AA P CON CONTRACTOR																										
LINE BD				64.50	7 22		7 8 40 4	1 000	1 000	64			America de la companya de la company	T 0.00		T 000		1 -	T 0700 T	00 0E 1	30 1 2040	0.000	AA AA	1 00 04	T 00.00	_
D1	D2	0.84		24.70		0.80	2.74	0.00	2.30	83	18		and the second s	0.30	5.77	3.26		<u> </u>			0.048	0.039		93.24	92.80	4
D2	A11	0.31	1.15	25.25	3.39	0.80	2.71	0.00	3.12	131	24			0.20	10.14	3.23	1 0	0	85.95	80.69 O.	9 0.019	0.025	93.24	93.21	92.80	1

READ KING Job No.: WATERVIEW TOWN CENTER Drawn:

03-20-2018

DEDEN SERVICES, LLC CML ENGINEERING Texas Registered Engineering Firm F-10971

9328 WESTVIEW - HOUSTON, TX. 77055 (713) 461-8822 FAX (713) 461-2671

VILLAGE EAST Checked: Highway 99 and Harlem Road Approved: Richmond, Texas 77406 Scale: AS SHOWN DRAINAGE CALCS

DATE: JANUARY 2018


SHEET 5 OF 12


BY CK APP


REVISIONS

FORT BEND COUNTY MUNICIPAL UTILITY DISTRICT NUMBER 143 ENGINEER, SIGNATURE VALID FOR ONE (1) YEAR

NO. DATE

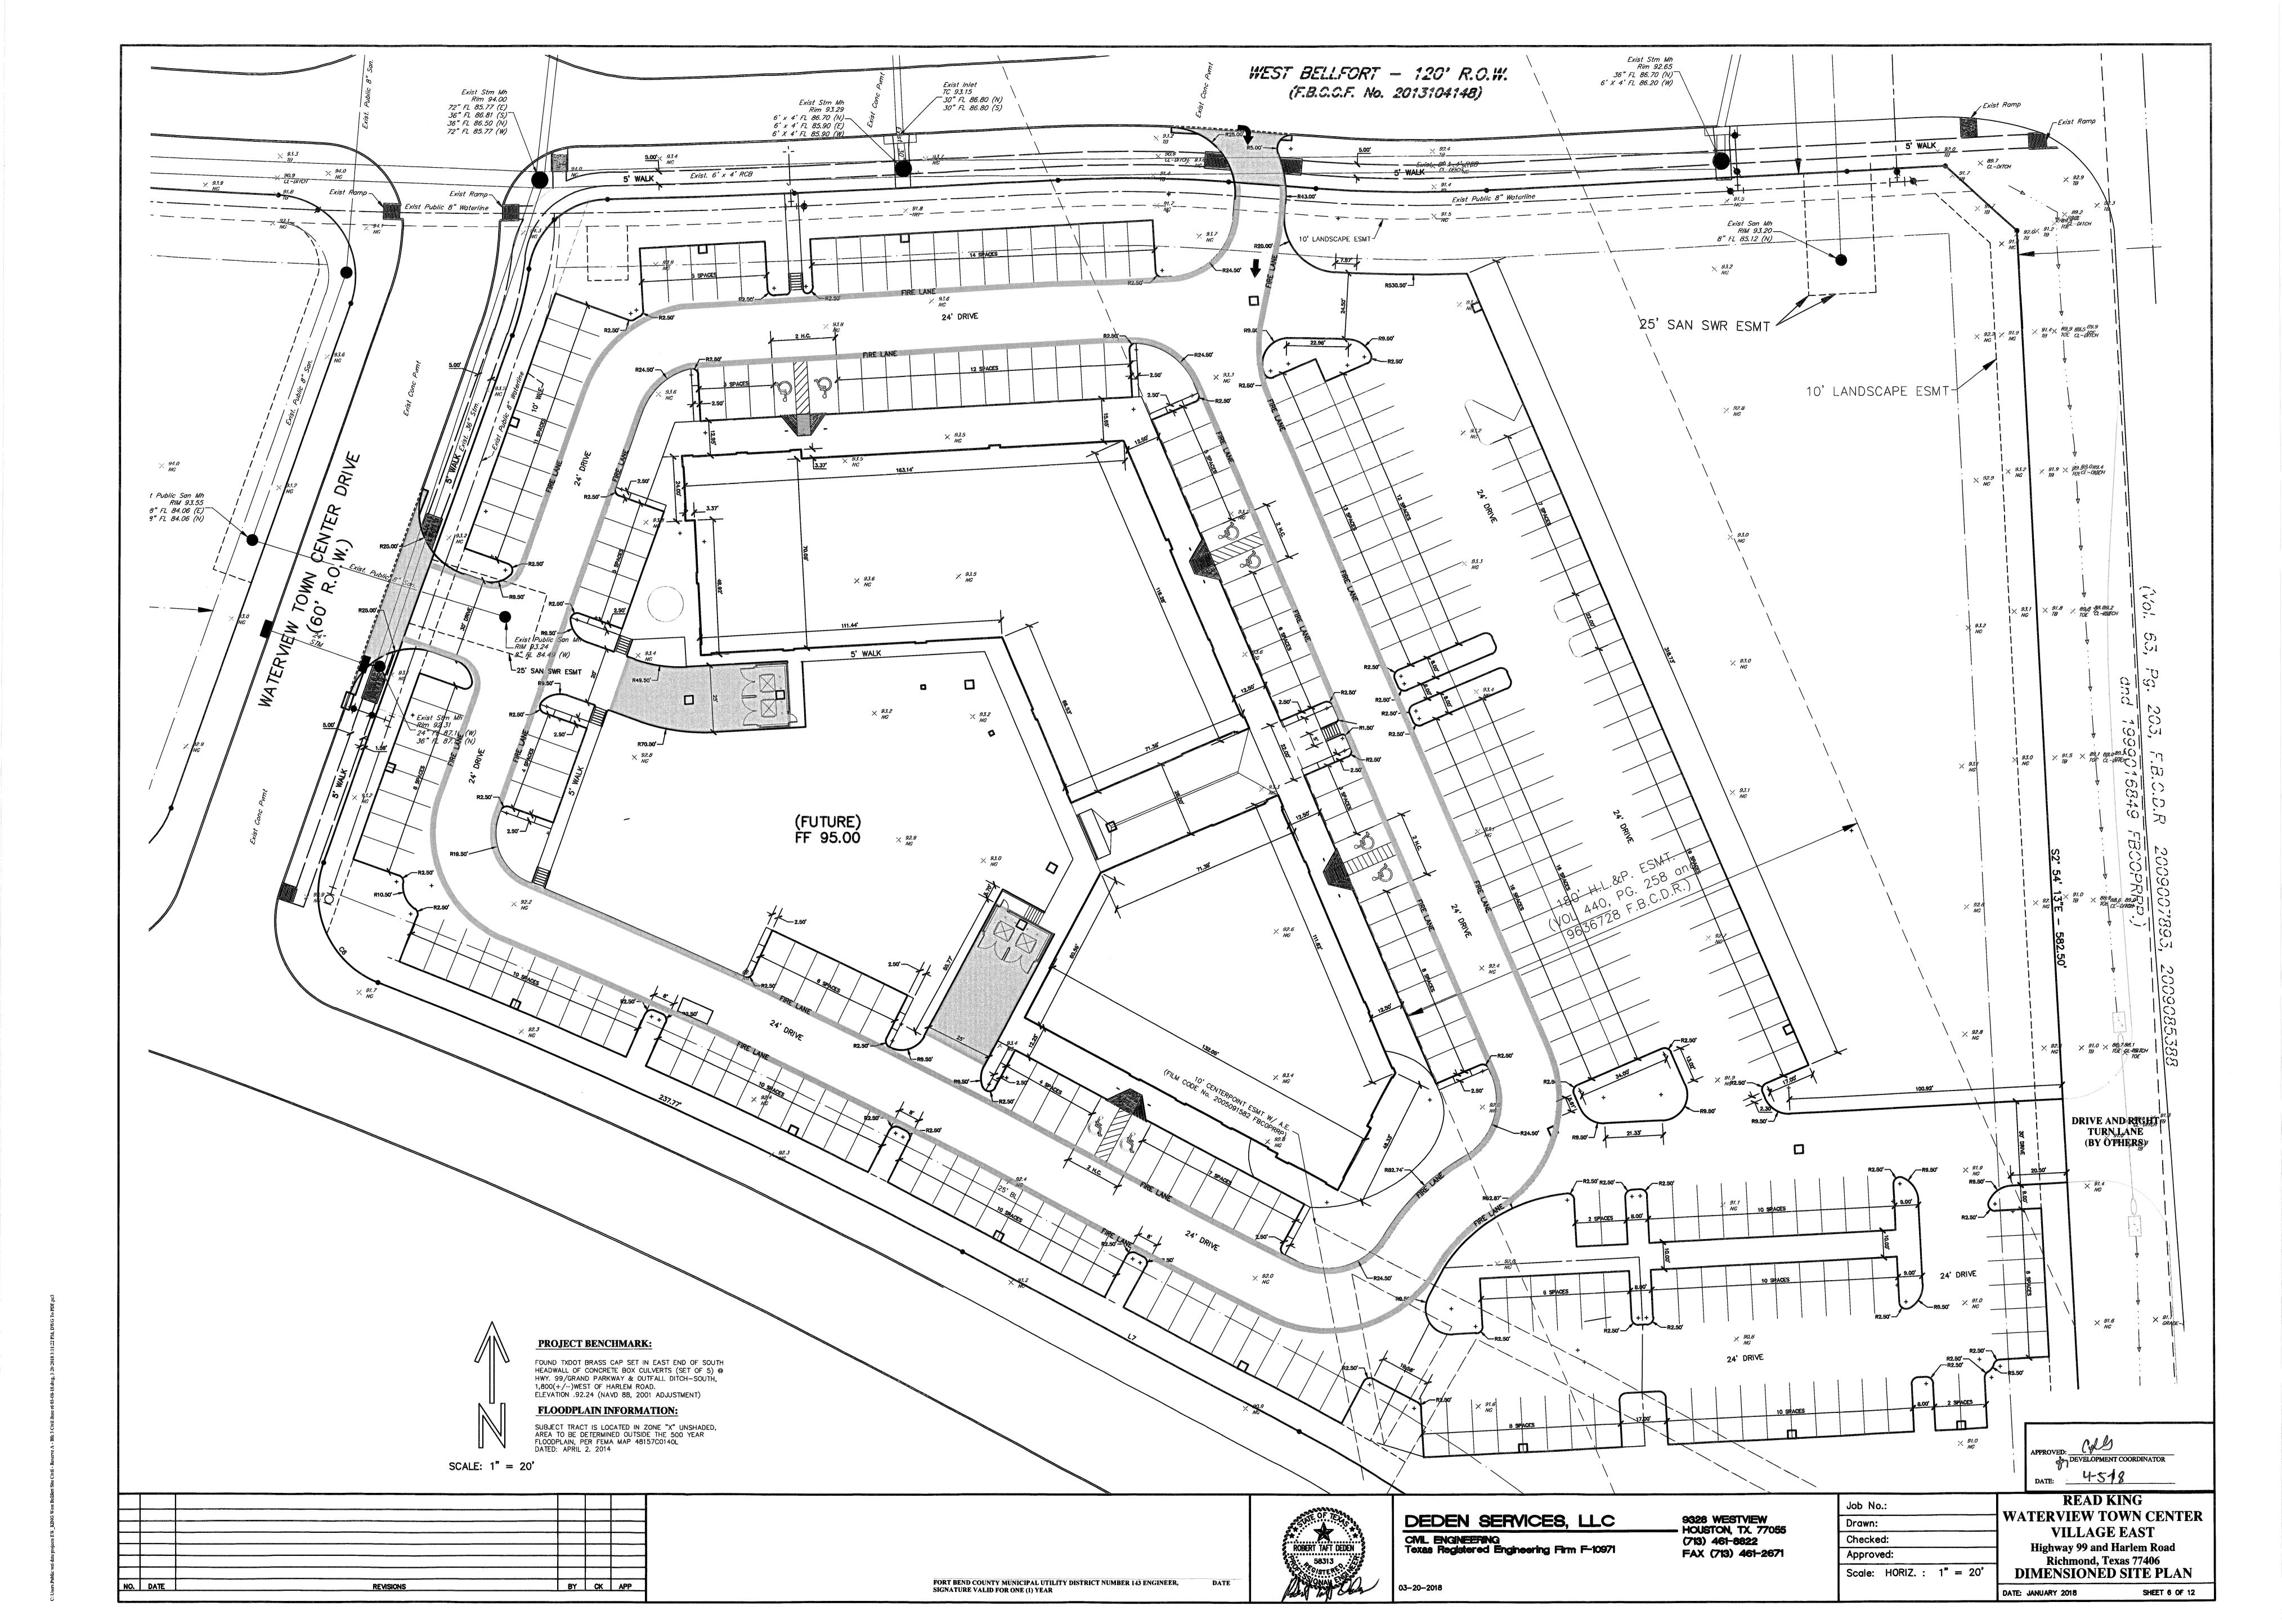


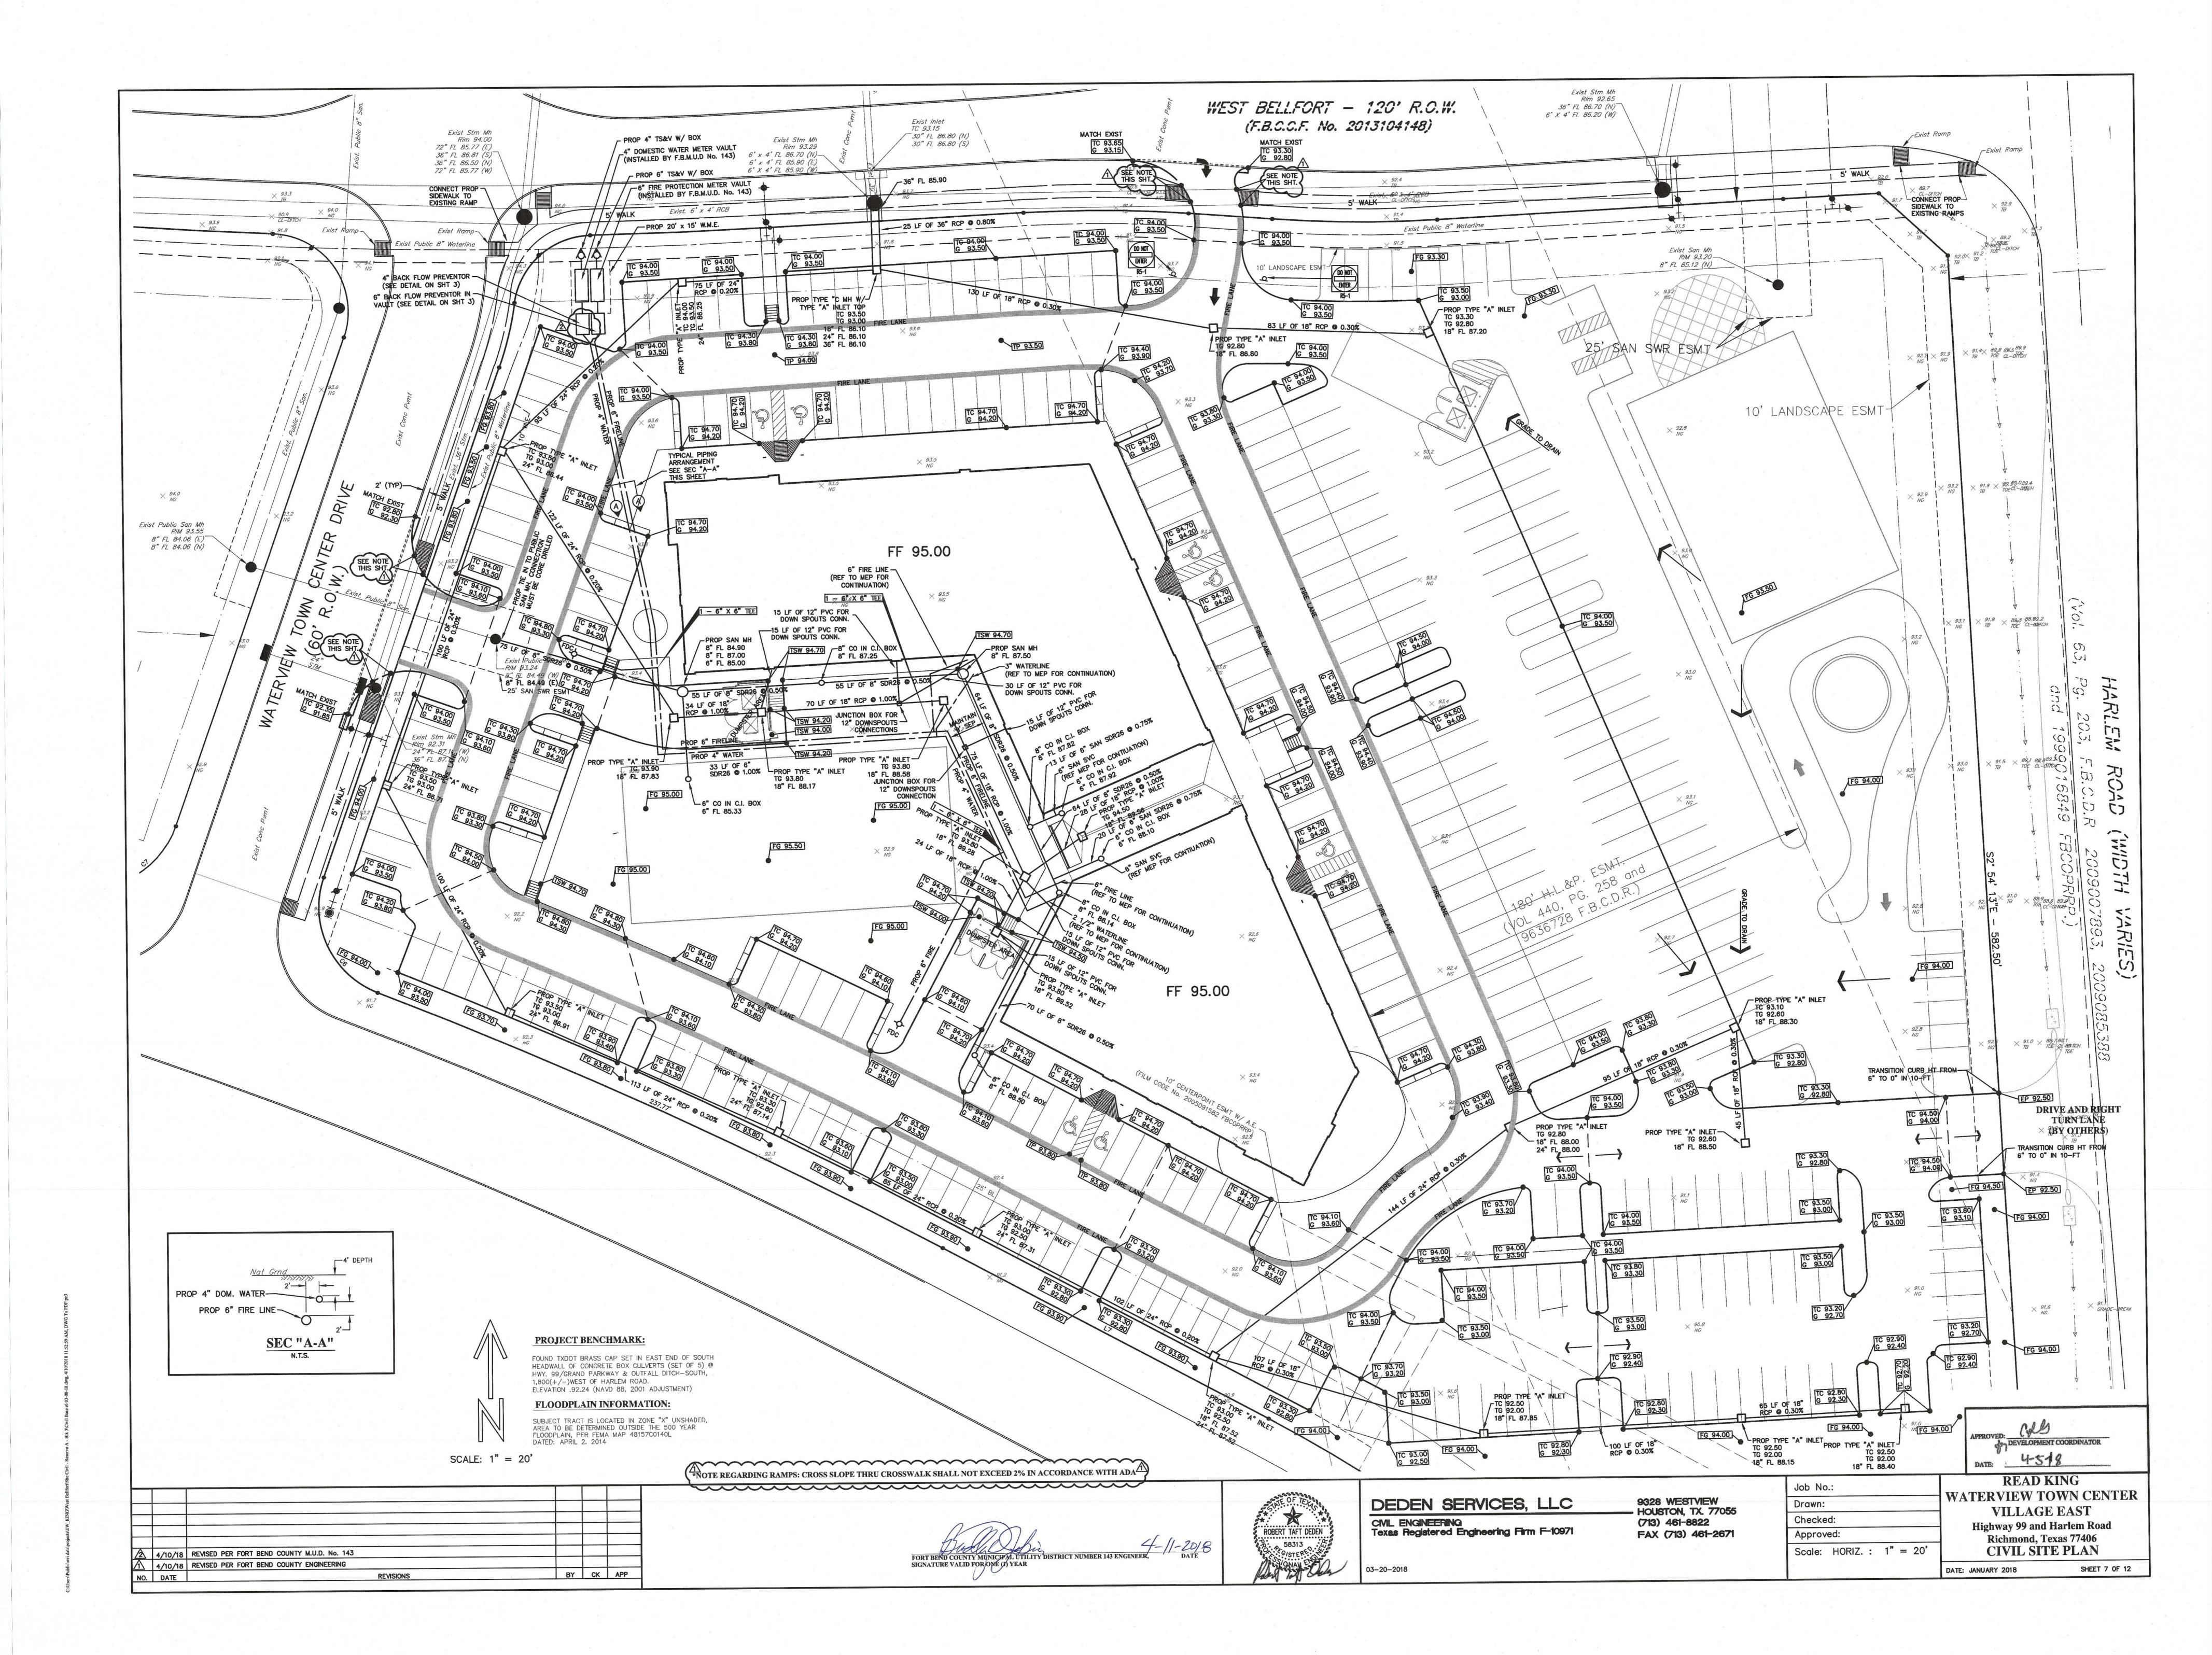


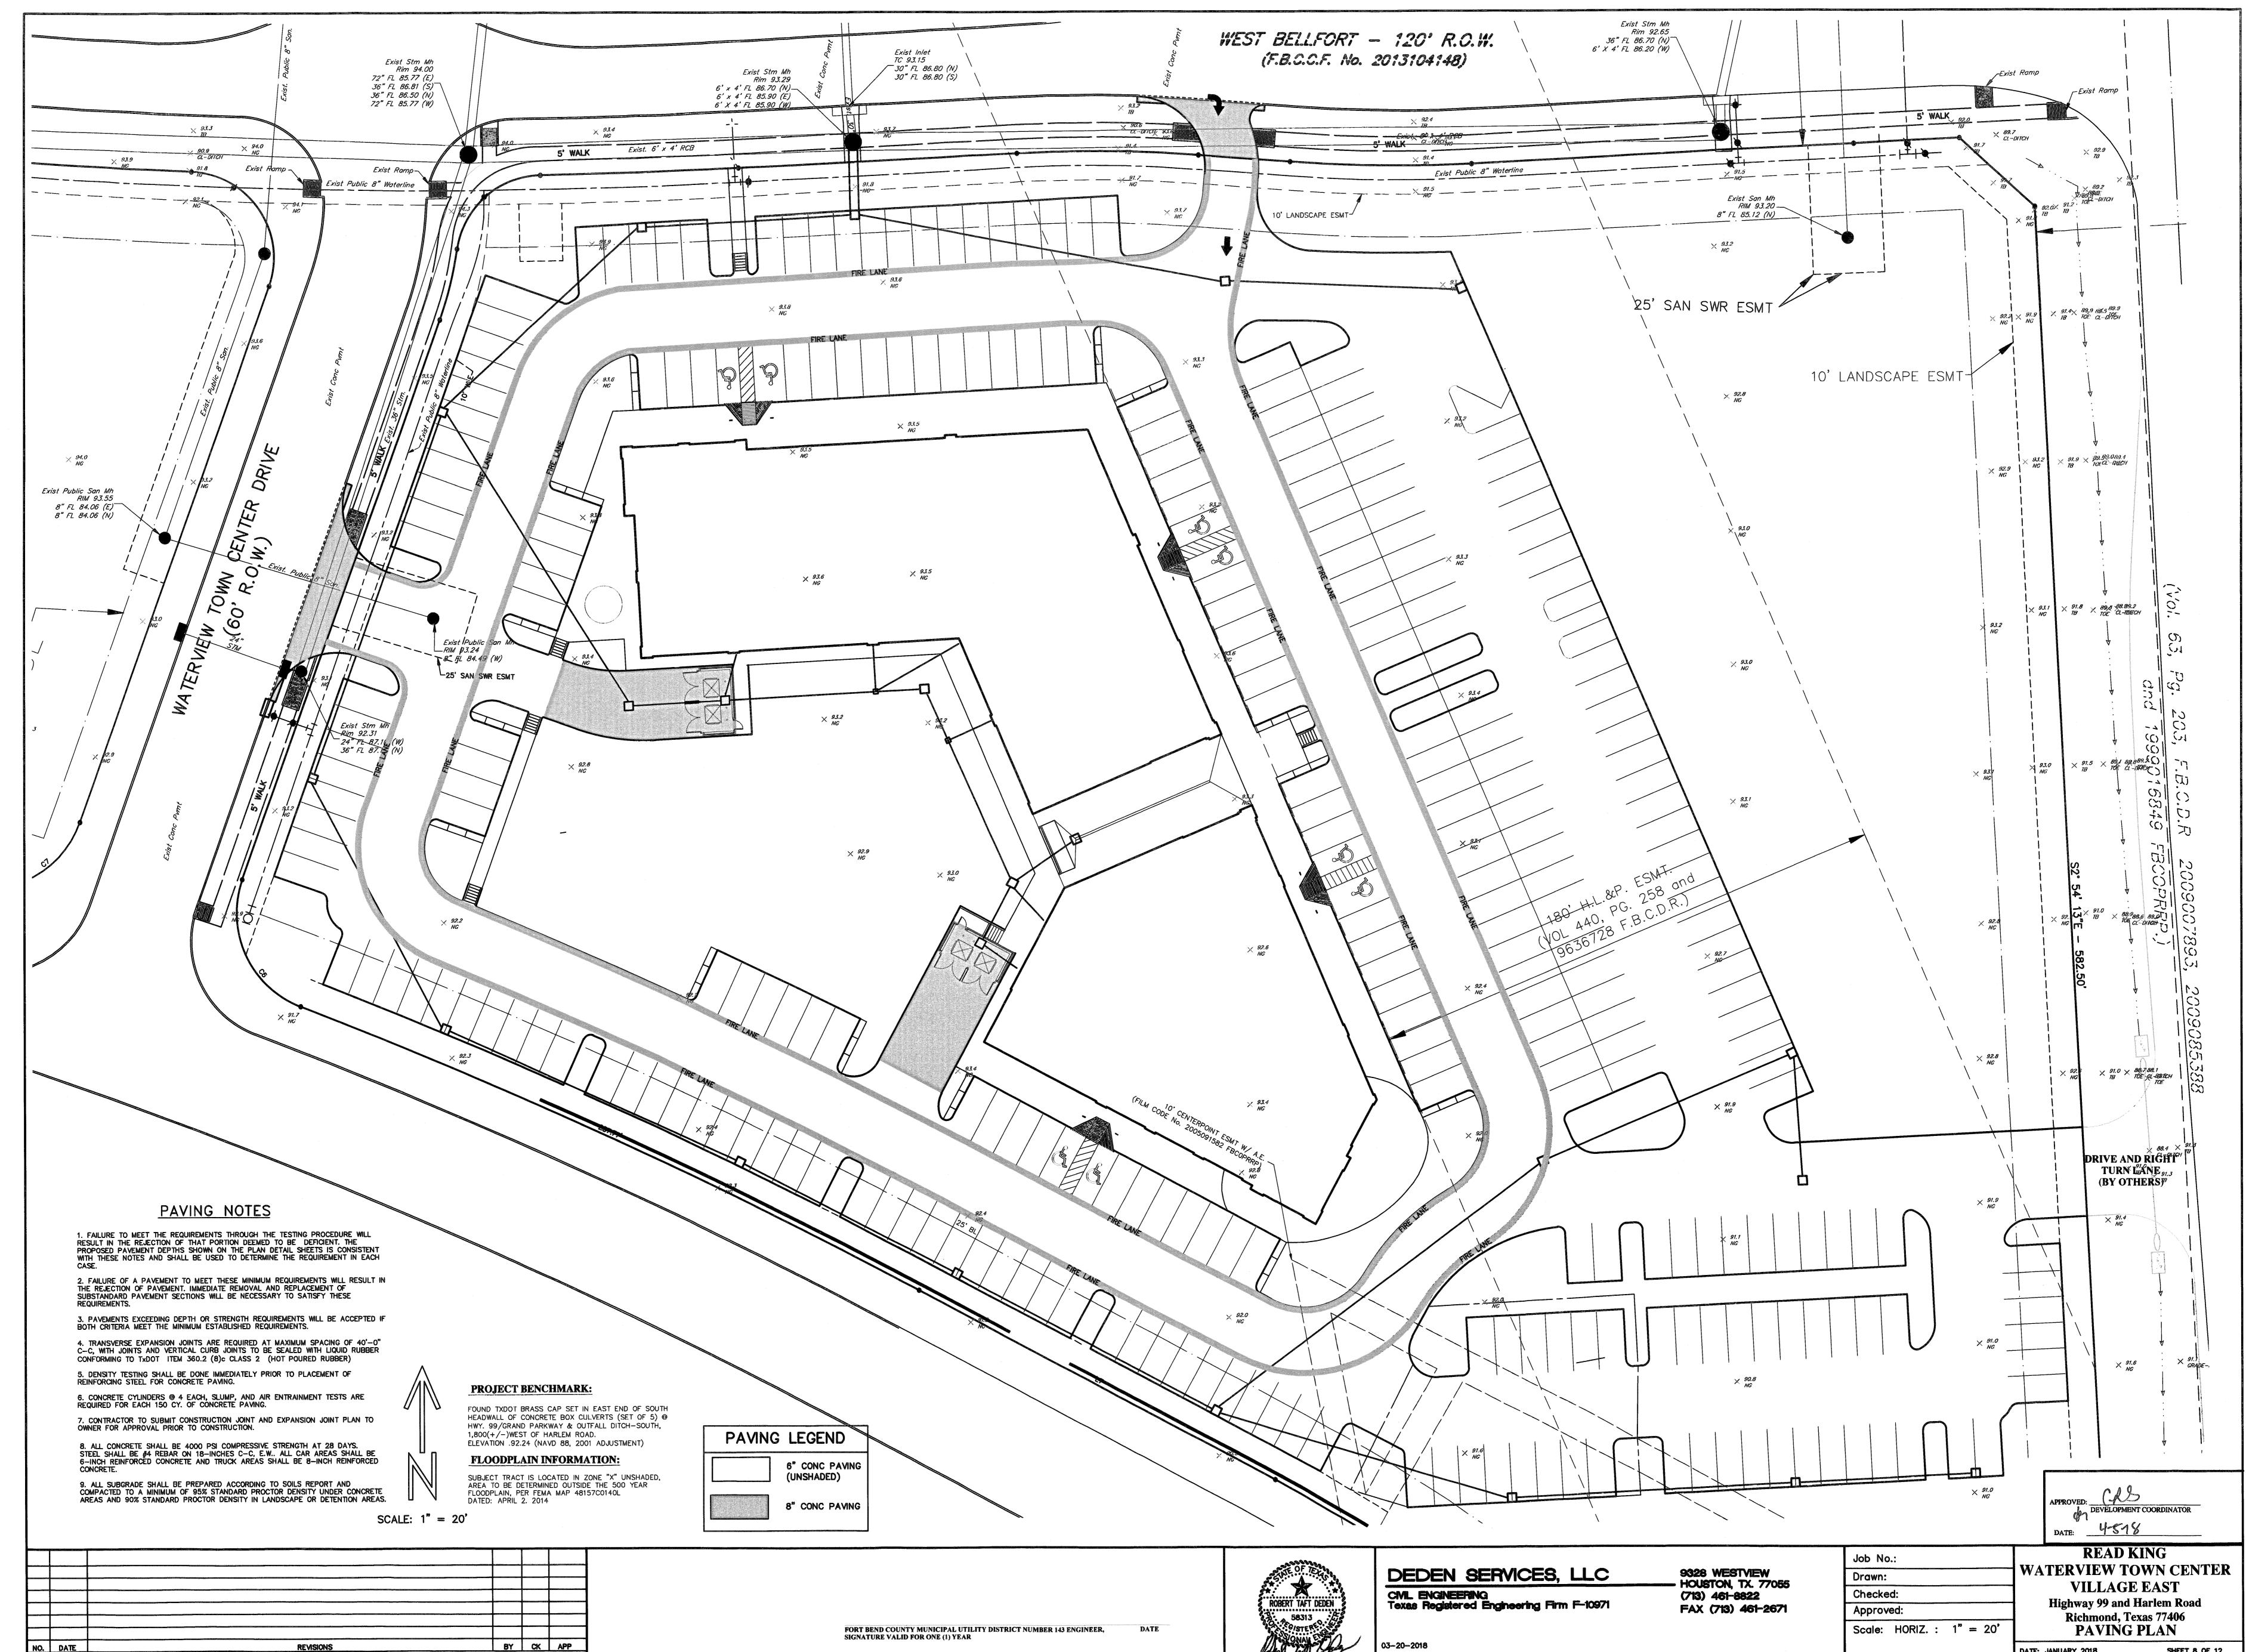




DATE: JANUARY 2018 SHEET 8 OF 12

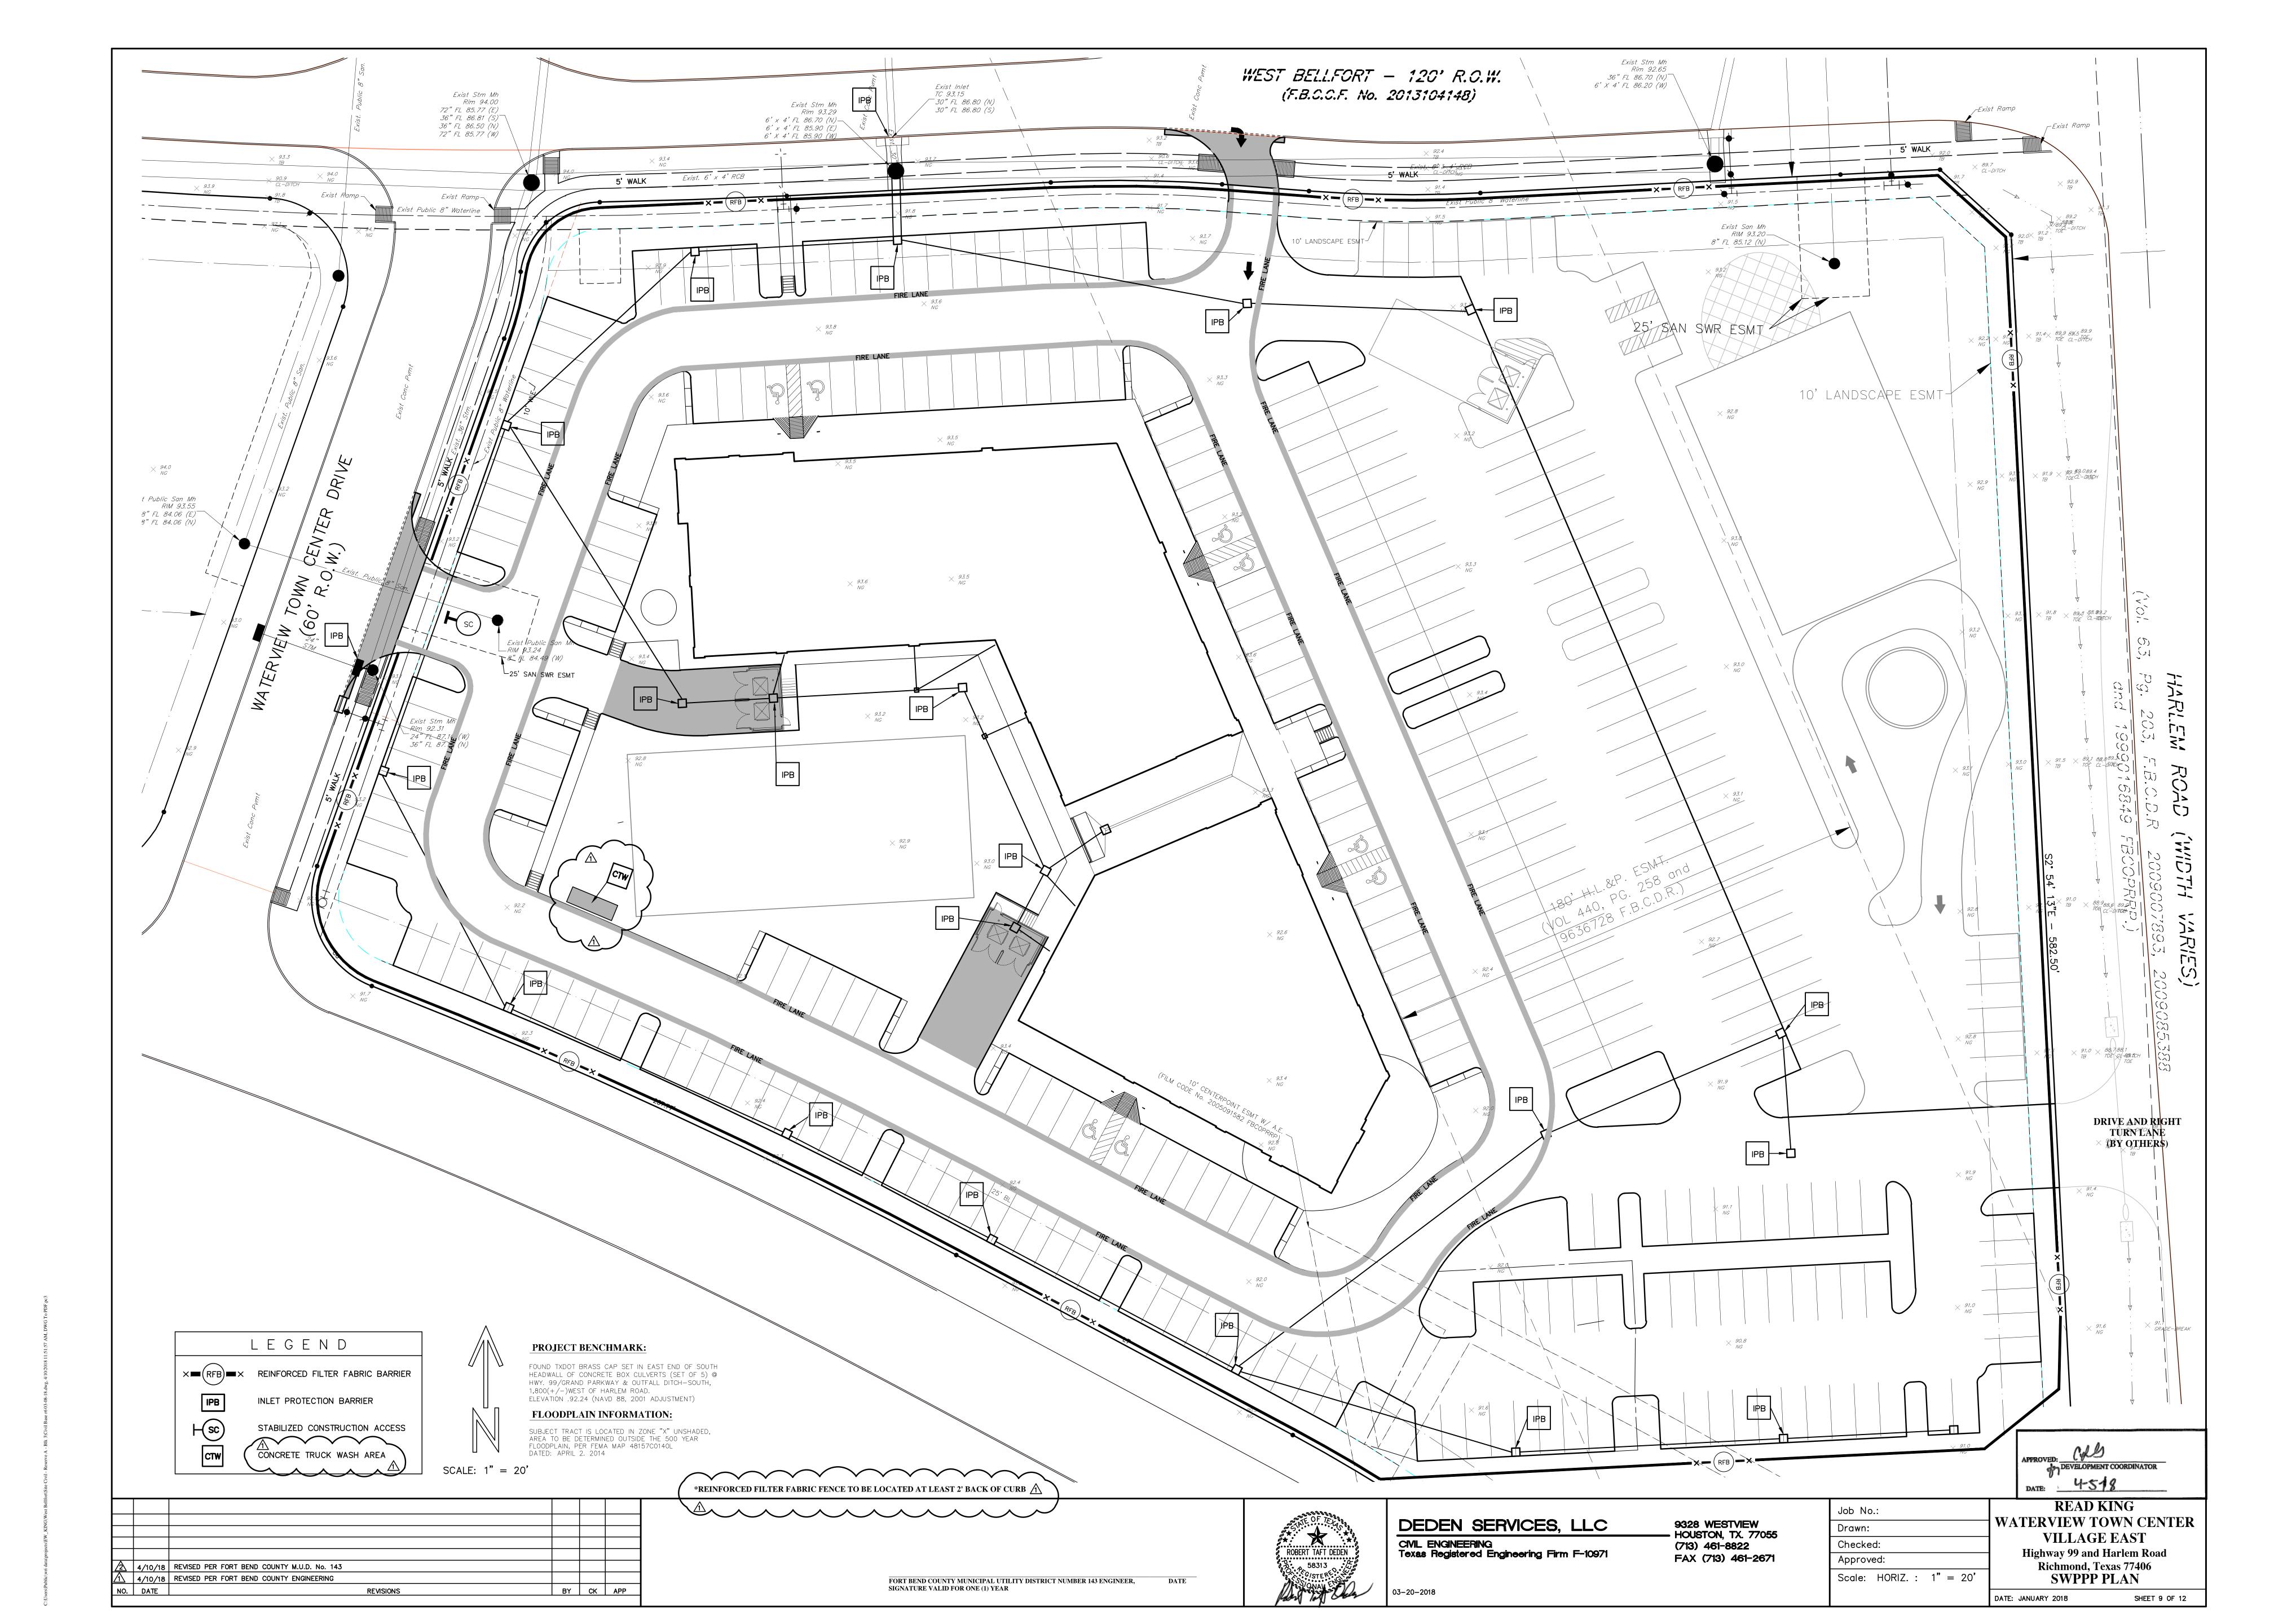

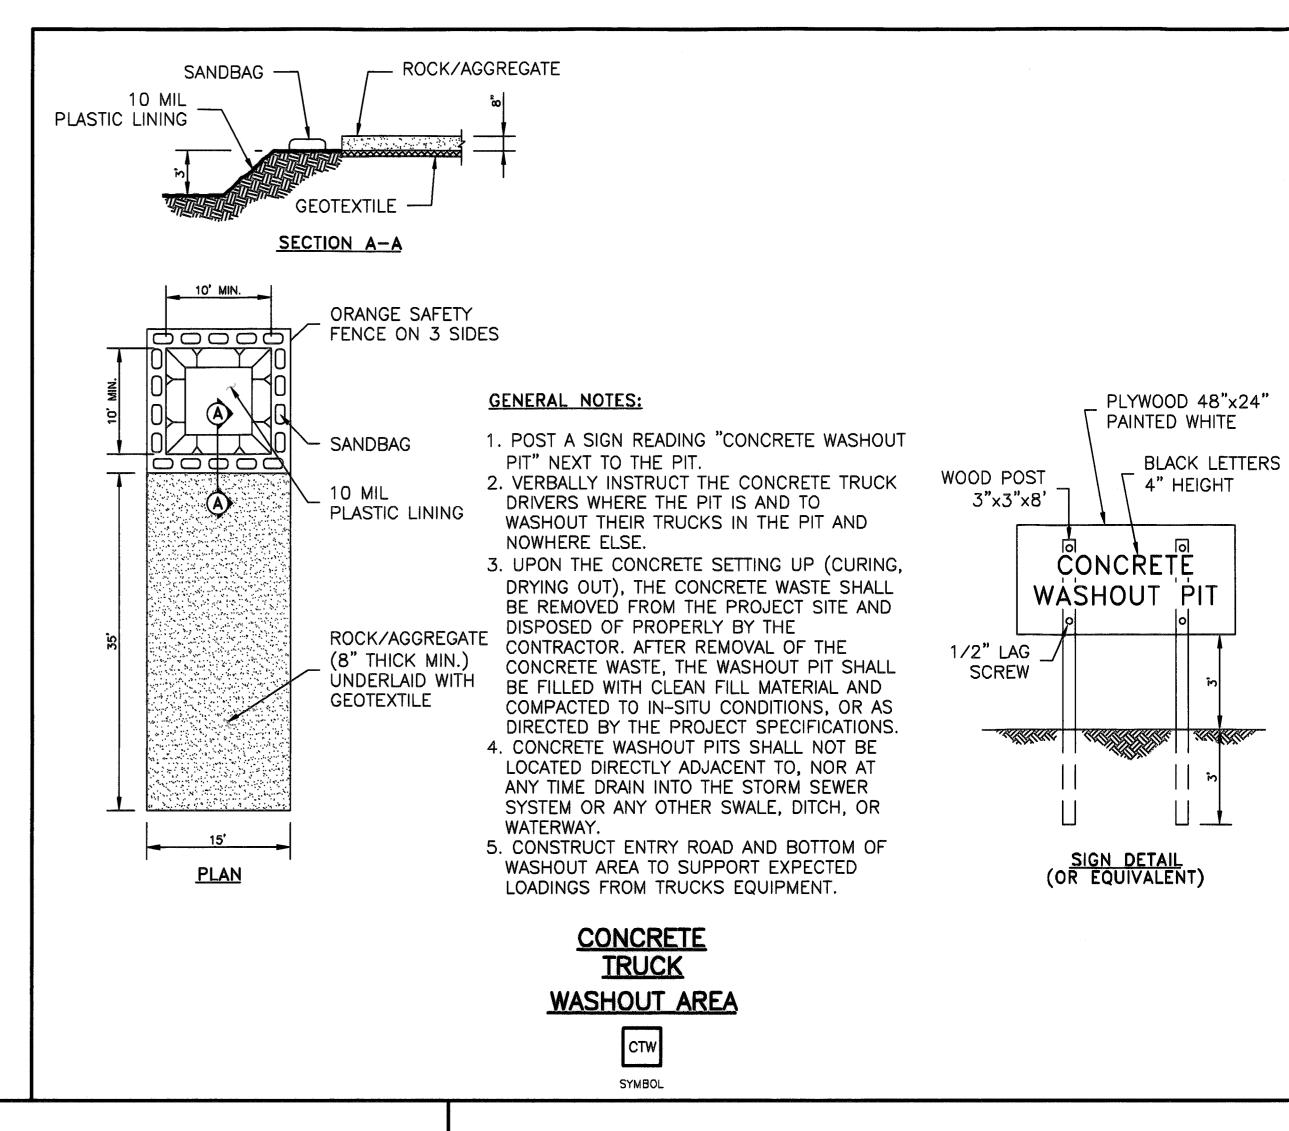


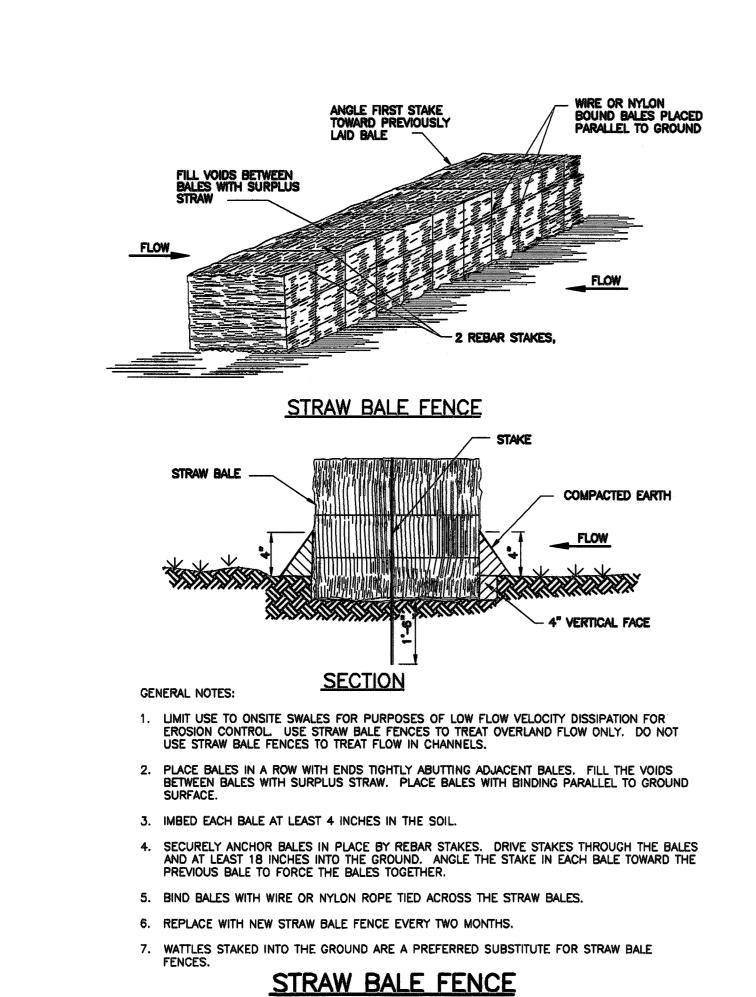



BY CK APP


REVISIONS

NO. DATE

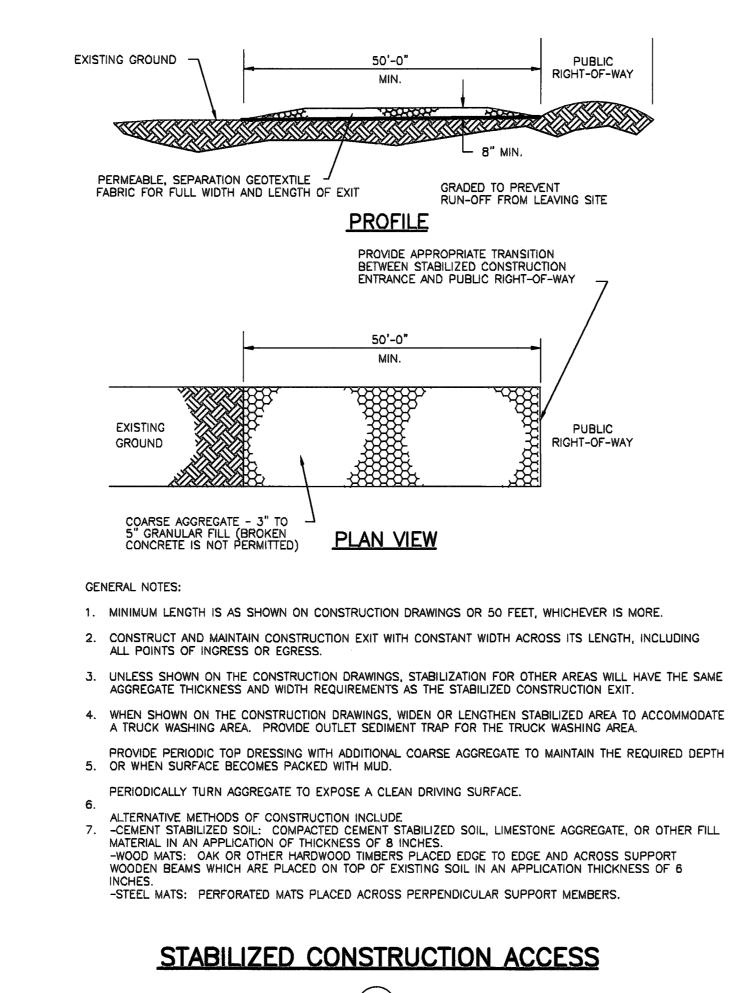

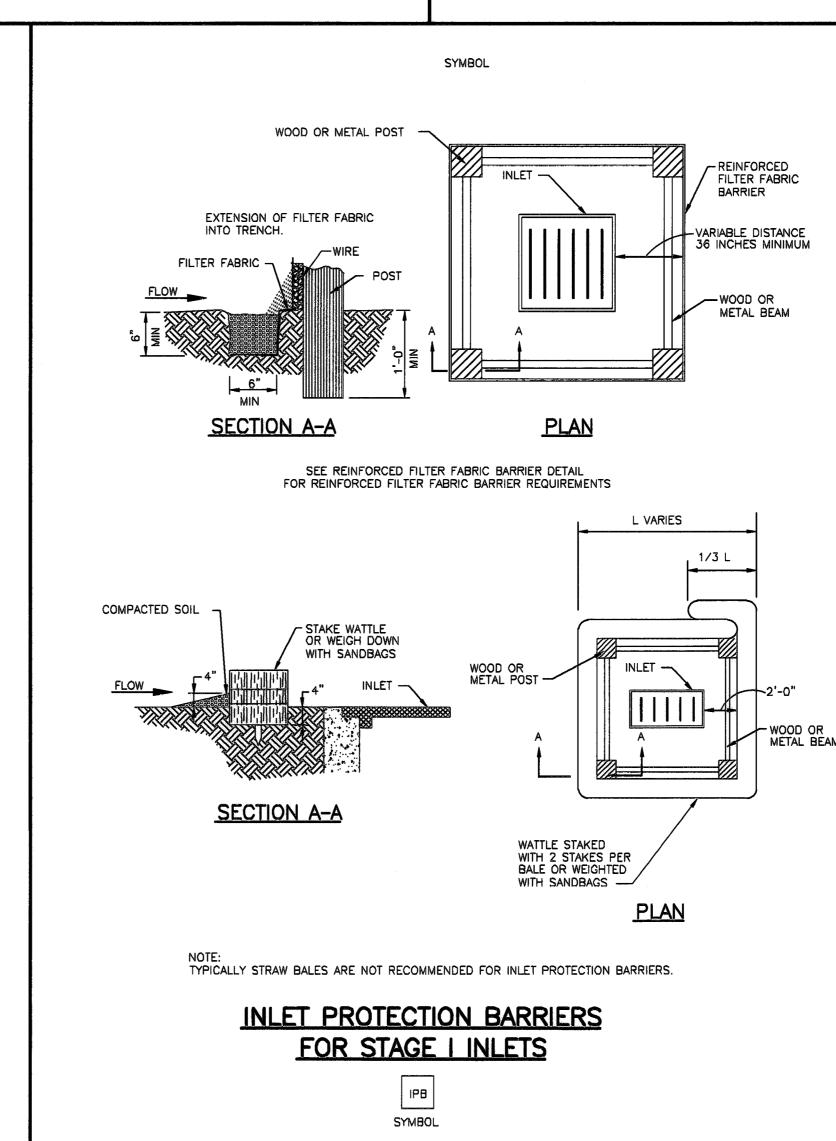

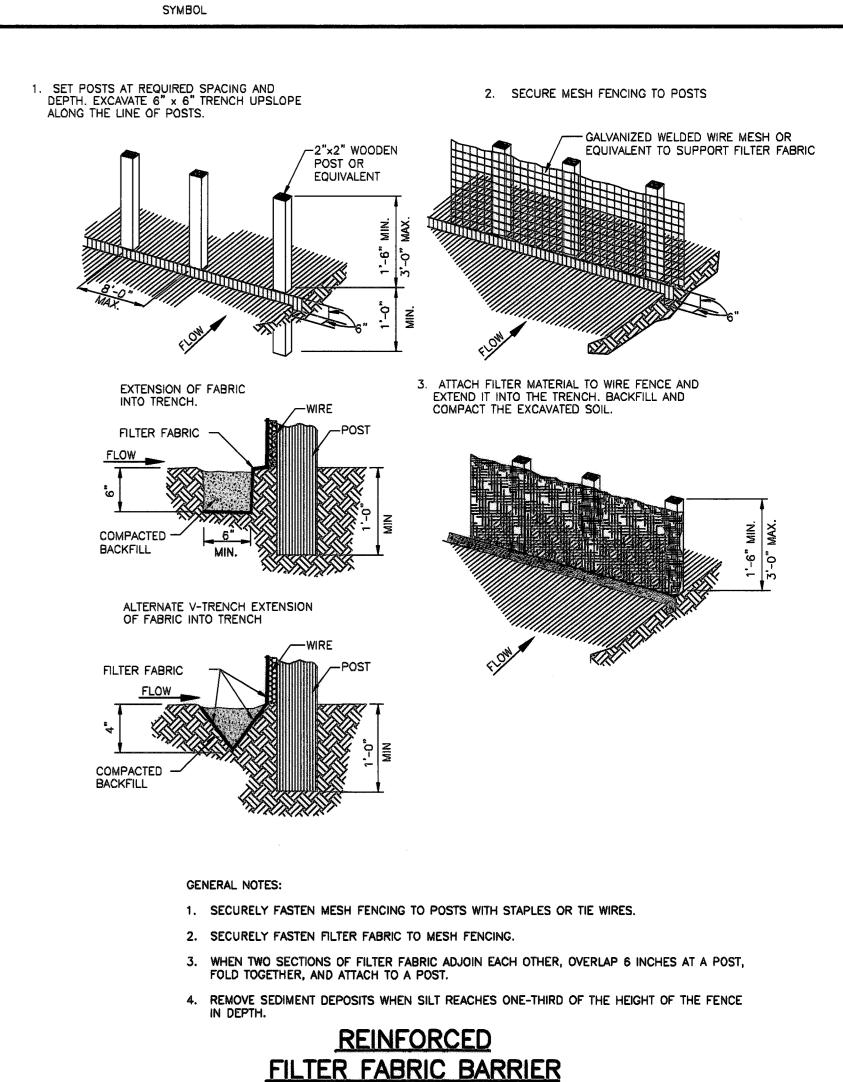

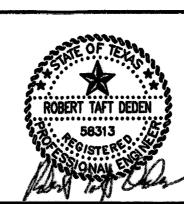

DEDEN SERVICES, LLC CIVIL ENGINEERING
Texas Registered Engineering Firm F-10971 9328 WESTVIEW HOUSTON, TX. 77055 (713) 461-8822 FAX (713) 461-2671

Job No.: Drawn: Checked: Approved: Scale: HORIZ. : 1" = 20'


DEVELOPMENT COORDINATOR **READ KING** WATERVIEW TOWN CENTER VILLAGE EAST Highway 99 and Harlem Road Richmond, Texas 77406 SWPPP DETAILS


FORT BEND COUNTY MUNICIPAL UTILITY DISTRICT NUMBER 143 ENGINEER, SIGNATURE VALID FOR ONE (1) YEAR

03-20-2018

DATE: JANUARY 2018

SHEET 10 OF 12

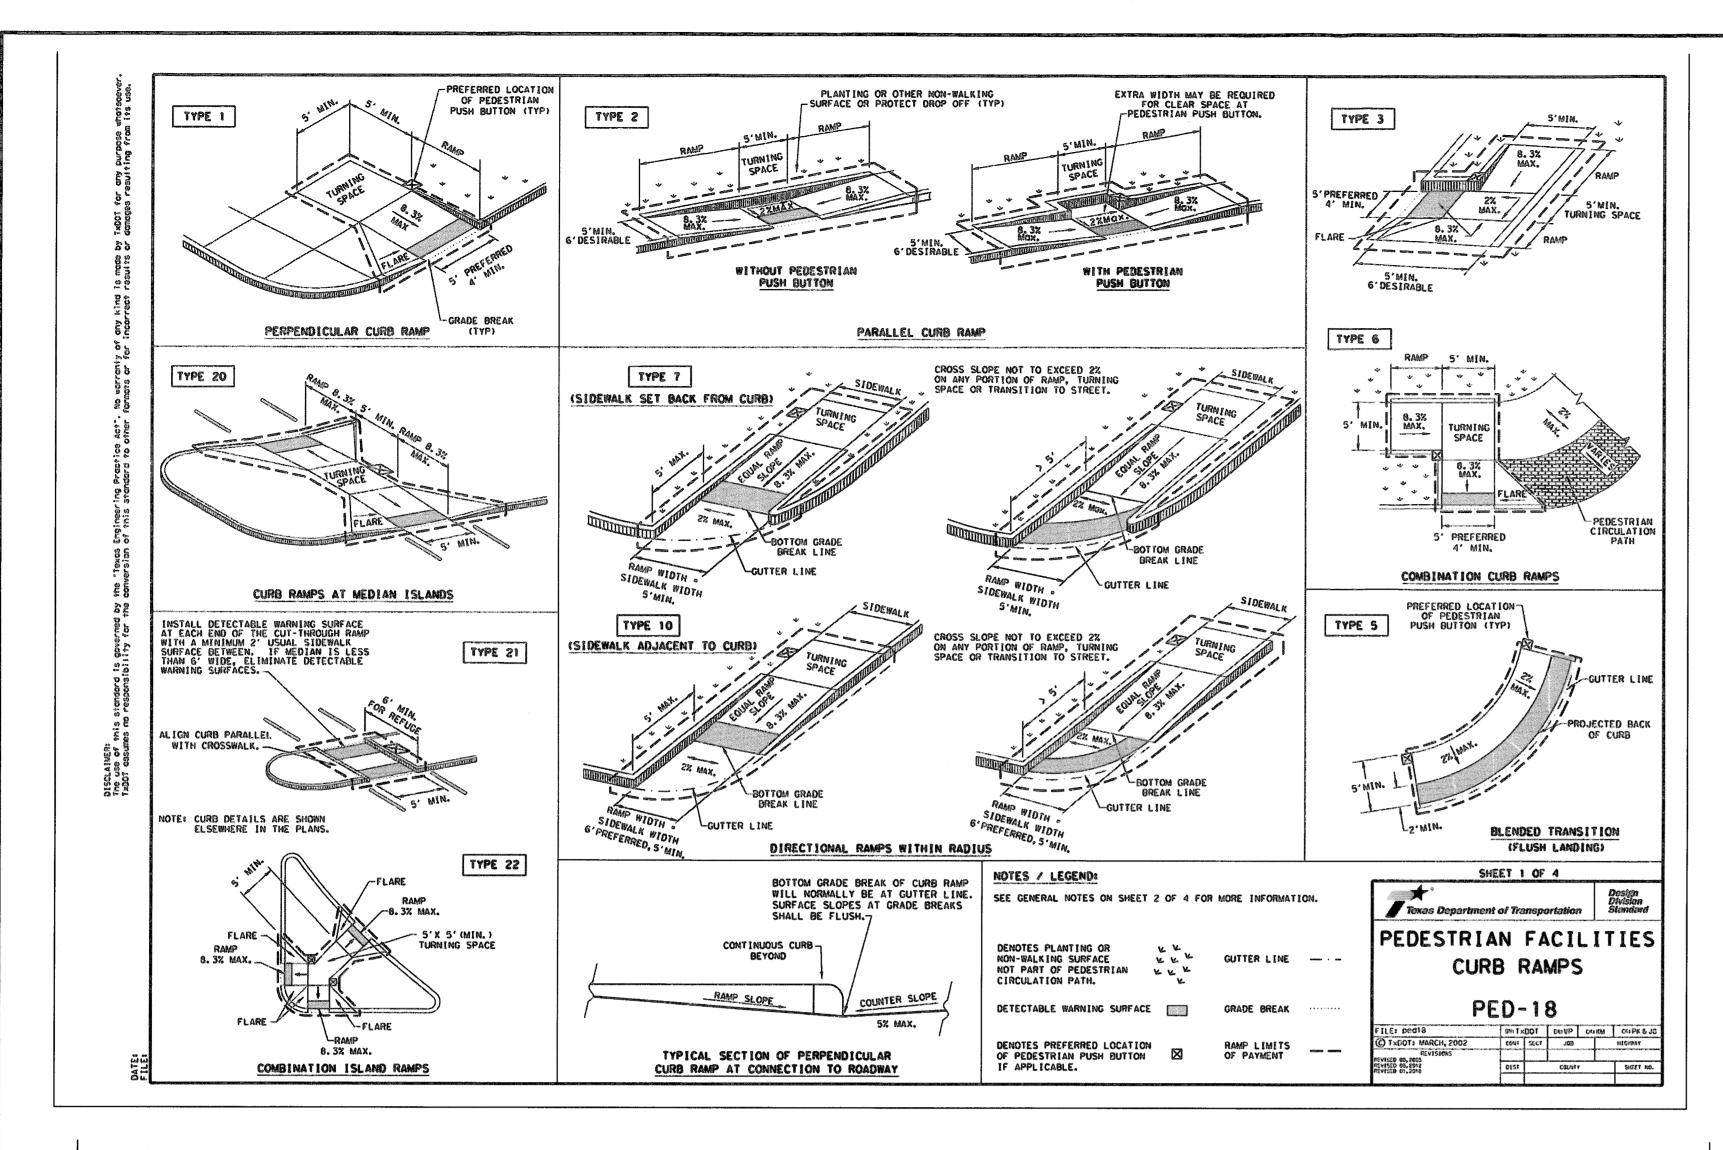

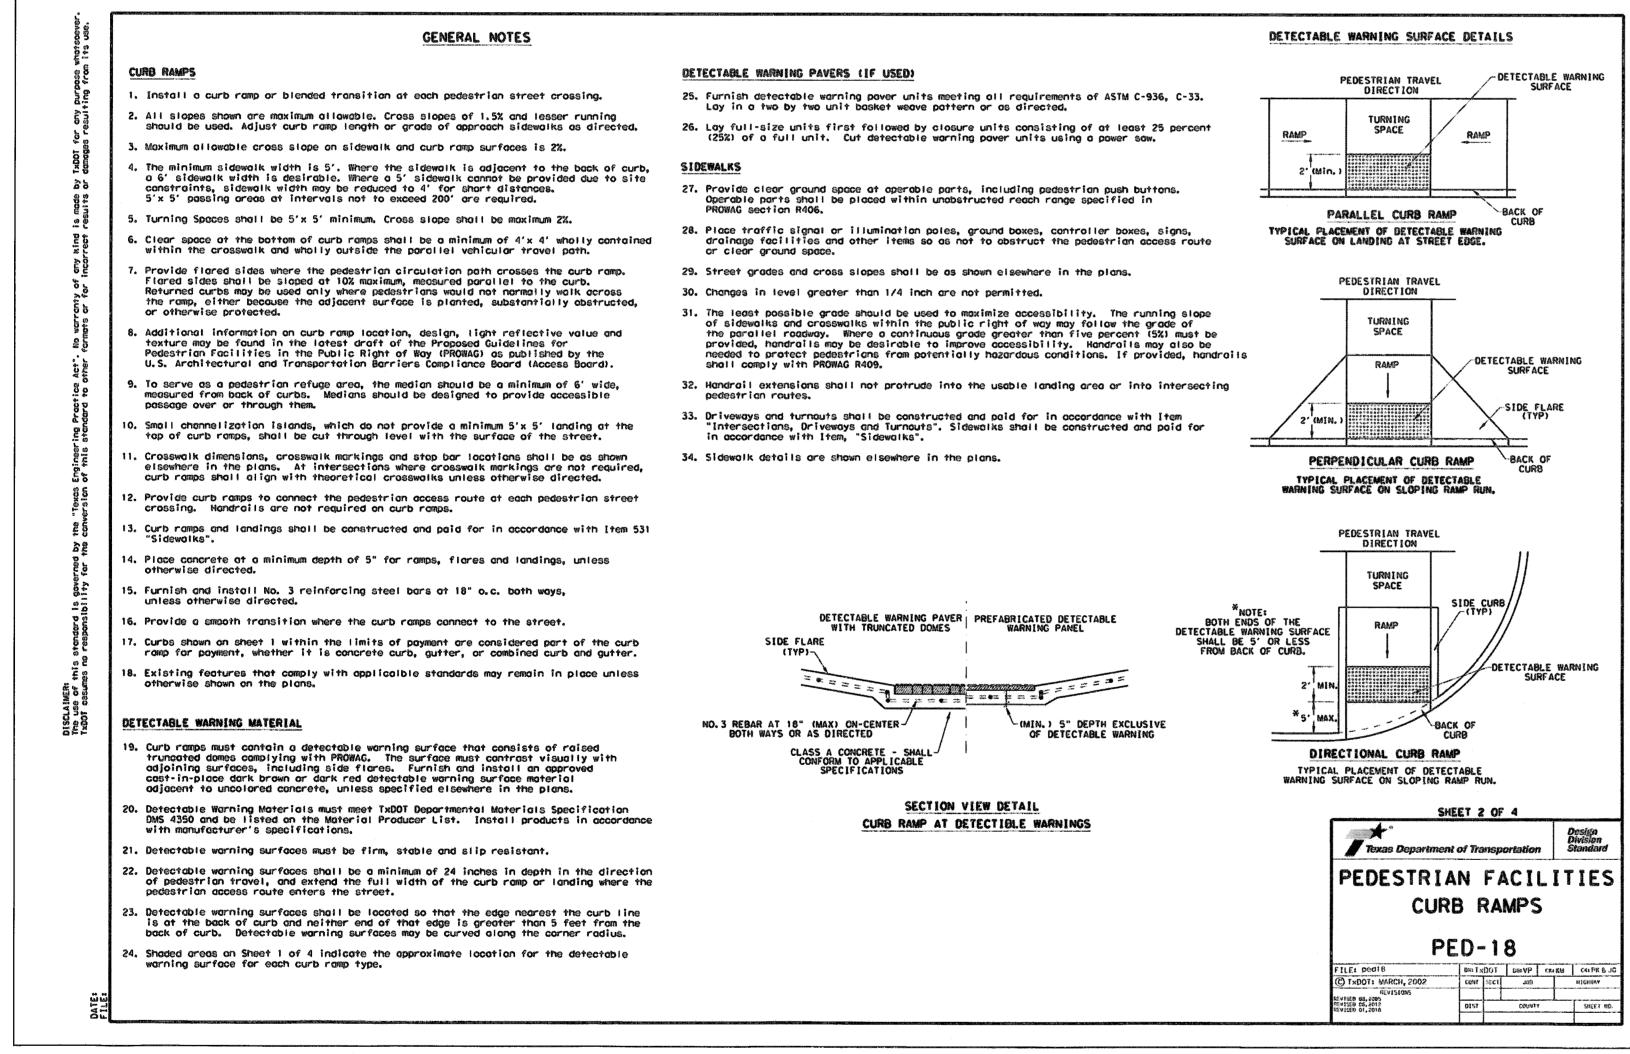



BY CK APP

REVISIONS

NO. DATE

DEVELOPMENT COORDINATOR

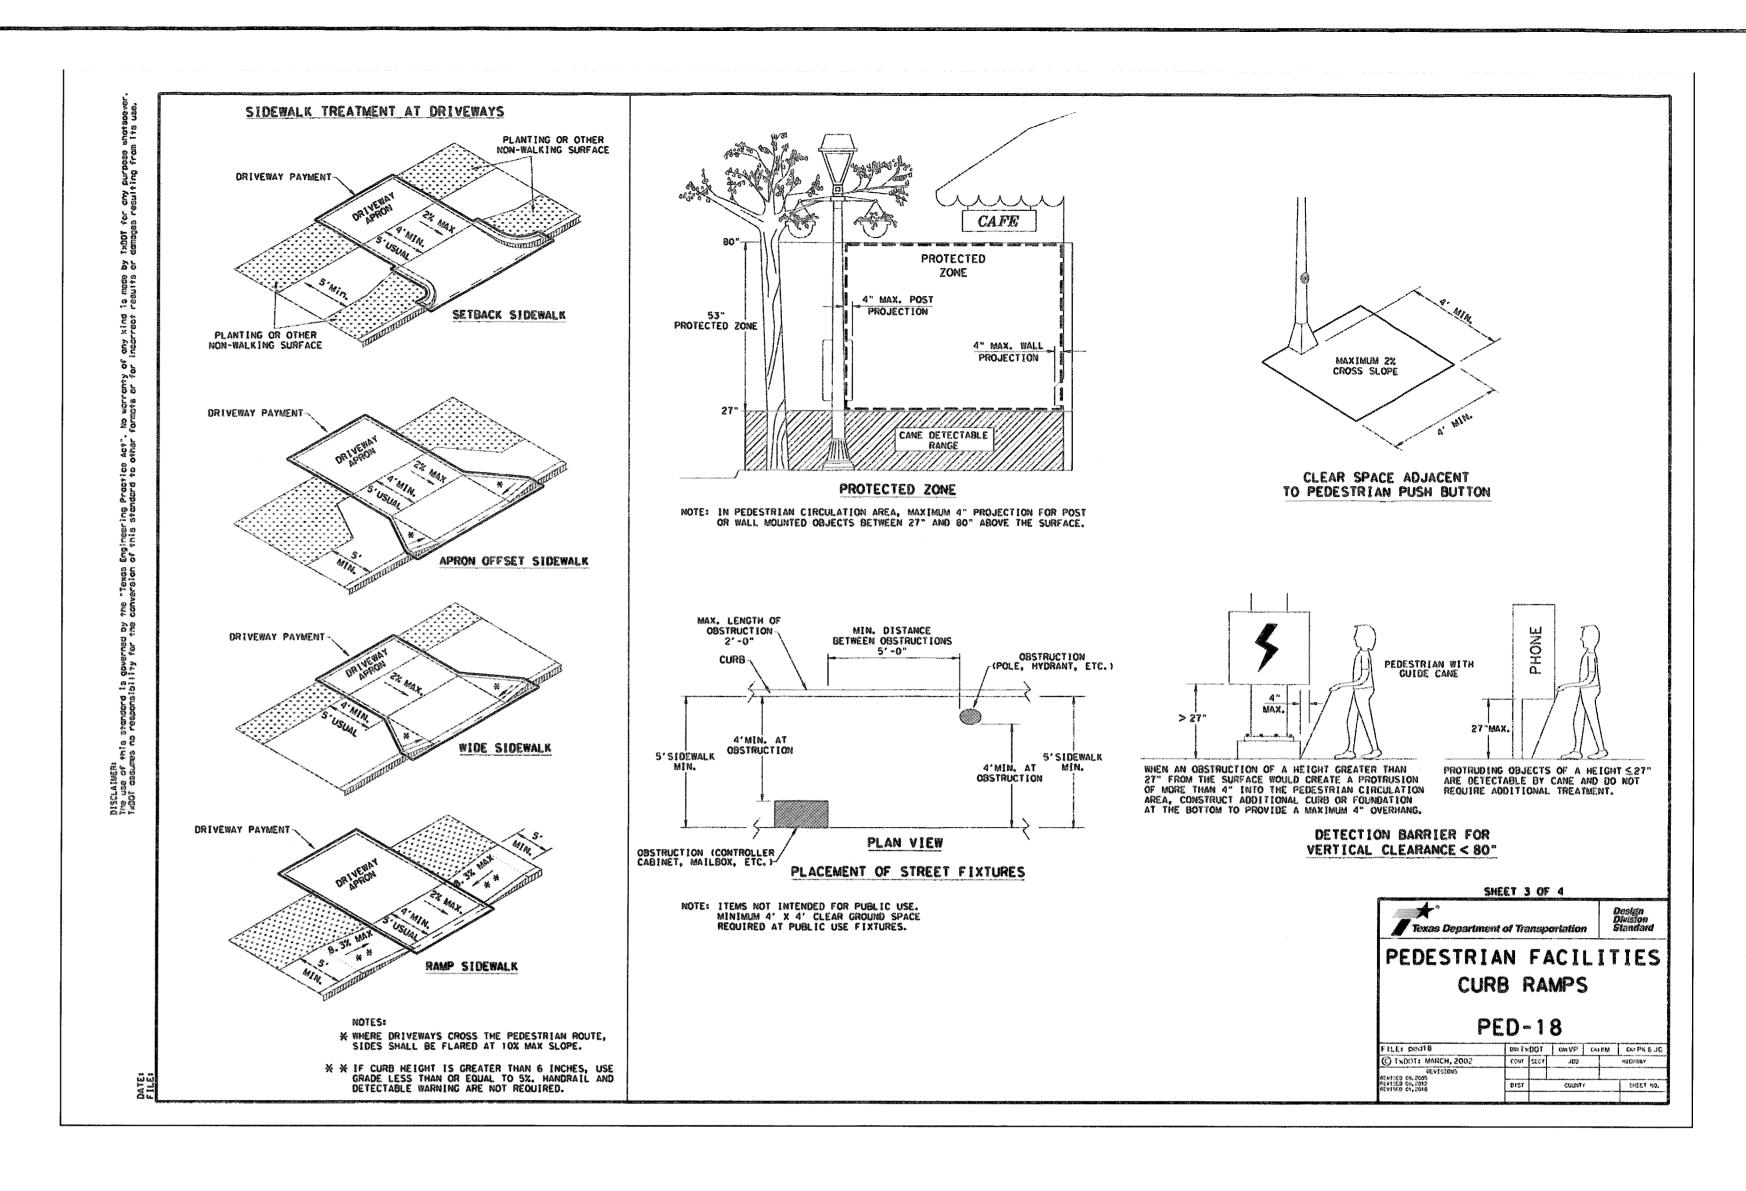

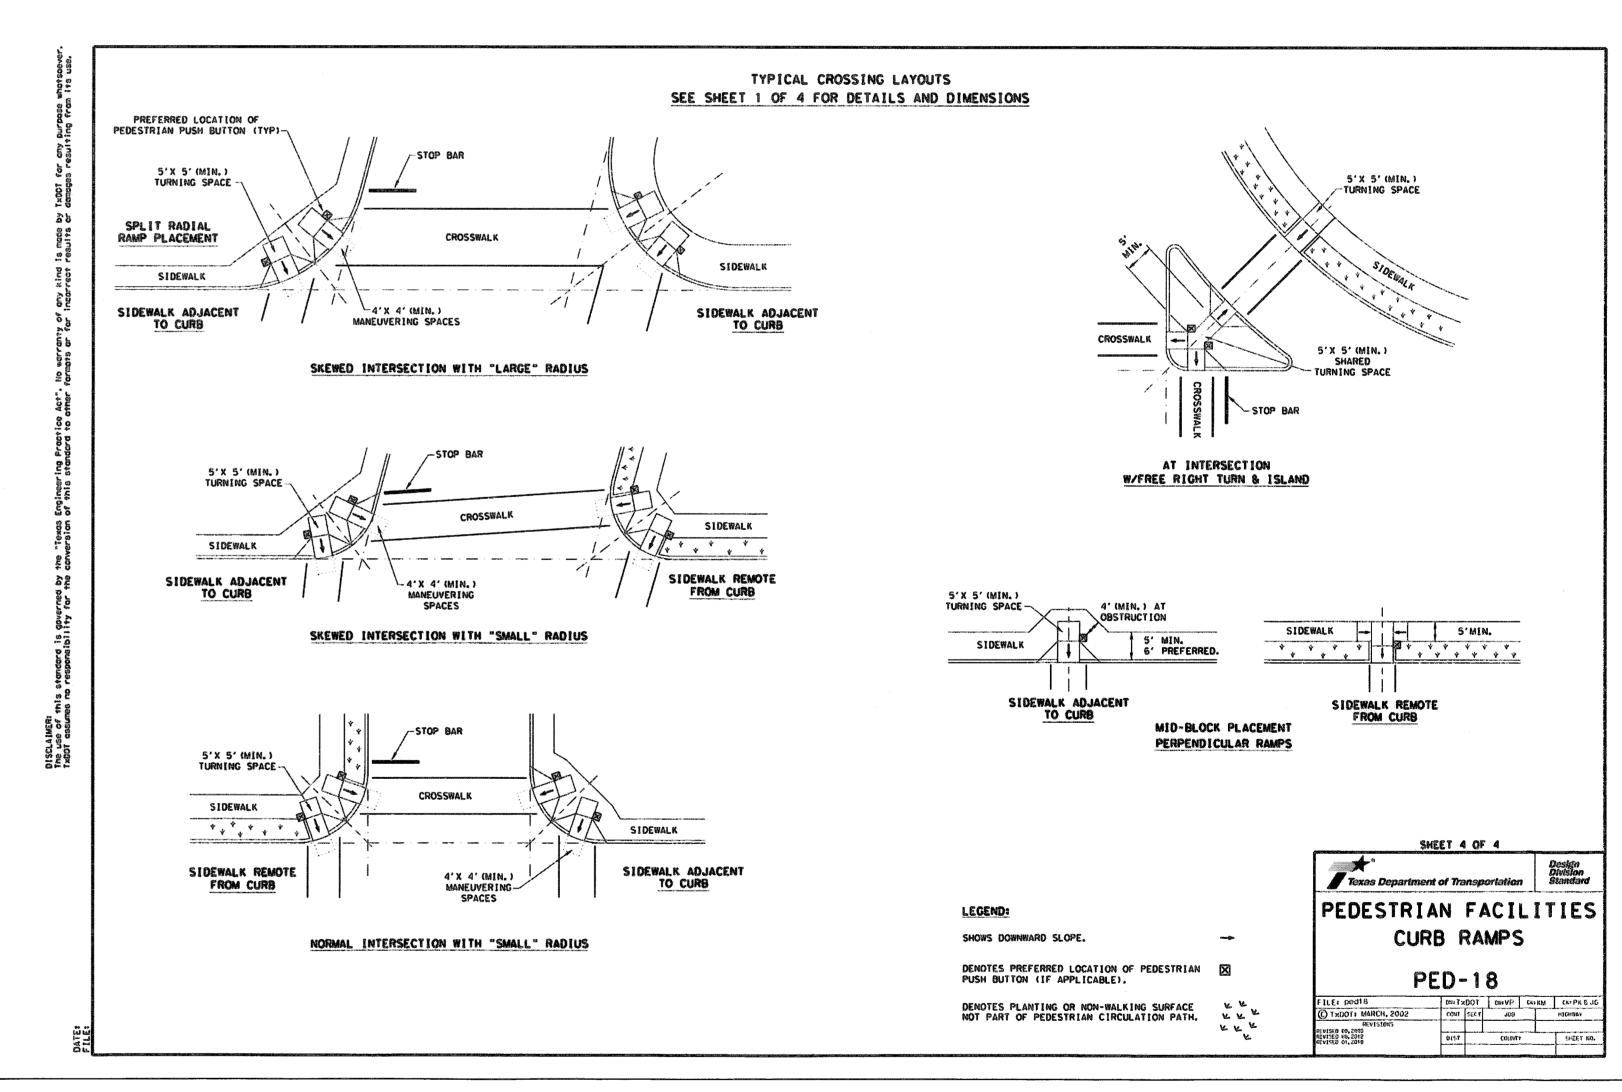


DEDEN SERVICES, LLC CML ENGINEERING Texas Registered Engineering Firm F-10971

9328 WESTVIEW - HOUSTON, TX. 77055 (713) 461-8822 FAX (713) 461-2671

READ KING Job No.: WATERVIEW TOWN CENTER Drawn: VILLAGE EAST Checked: Highway 99 and Harlem Road Approved: Richmond, Texas 77406 Scale: N.T.S. TXDOT PEDESTRIAN RAMP DETAILS DATE: JANUARY 2018 SHEET 11 OF 12

VED: CLOPMENT COORDINATOR

FORT BEND COUNTY MUNICIPAL UTILITY DISTRICT NUMBER 143 ENGINEER, SIGNATURE VALID FOR ONE (1) YEAR

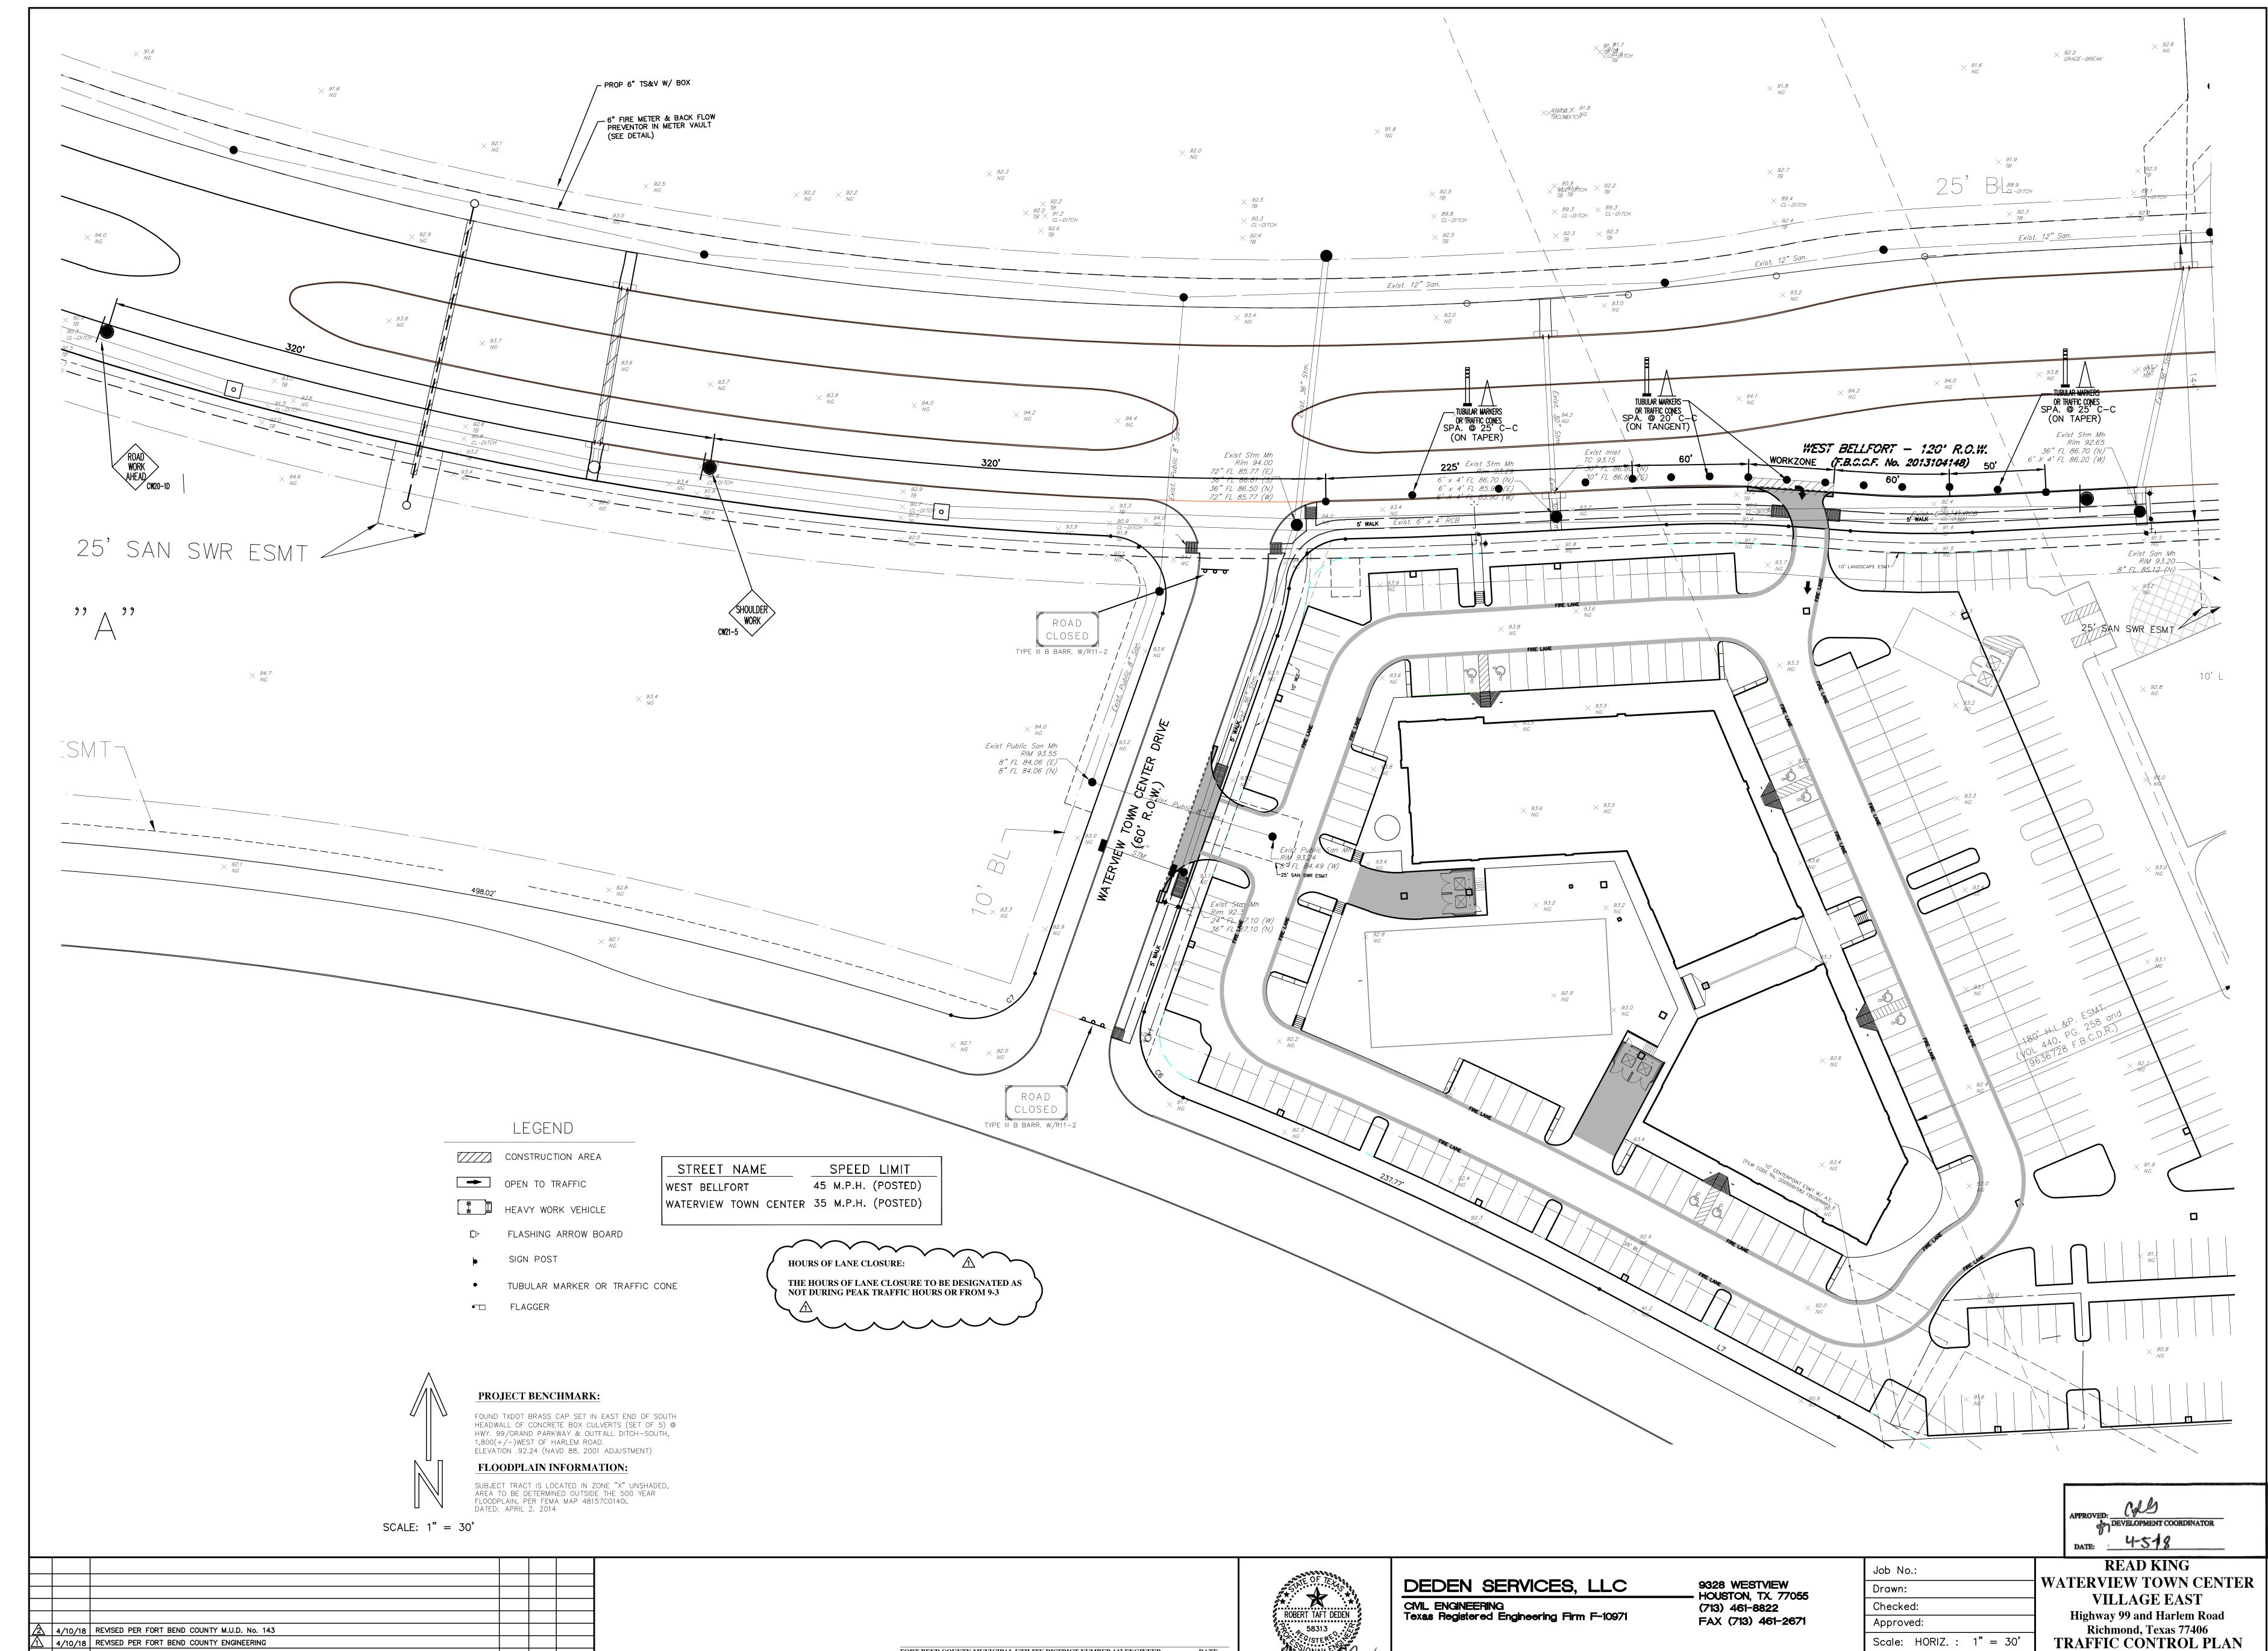

NO. DATE

BY CK APP


REVISIONS

FORT BEND COUNTY MUNICIPAL UTILITY DISTRICT NUMBER 143 ENGINEER, SIGNATURE VALID FOR ONE (1) YEAR

58313 (C) COSTERED (C)

03-20-2018

DATE: JANUARY 2018 SHEET 12 OF 12

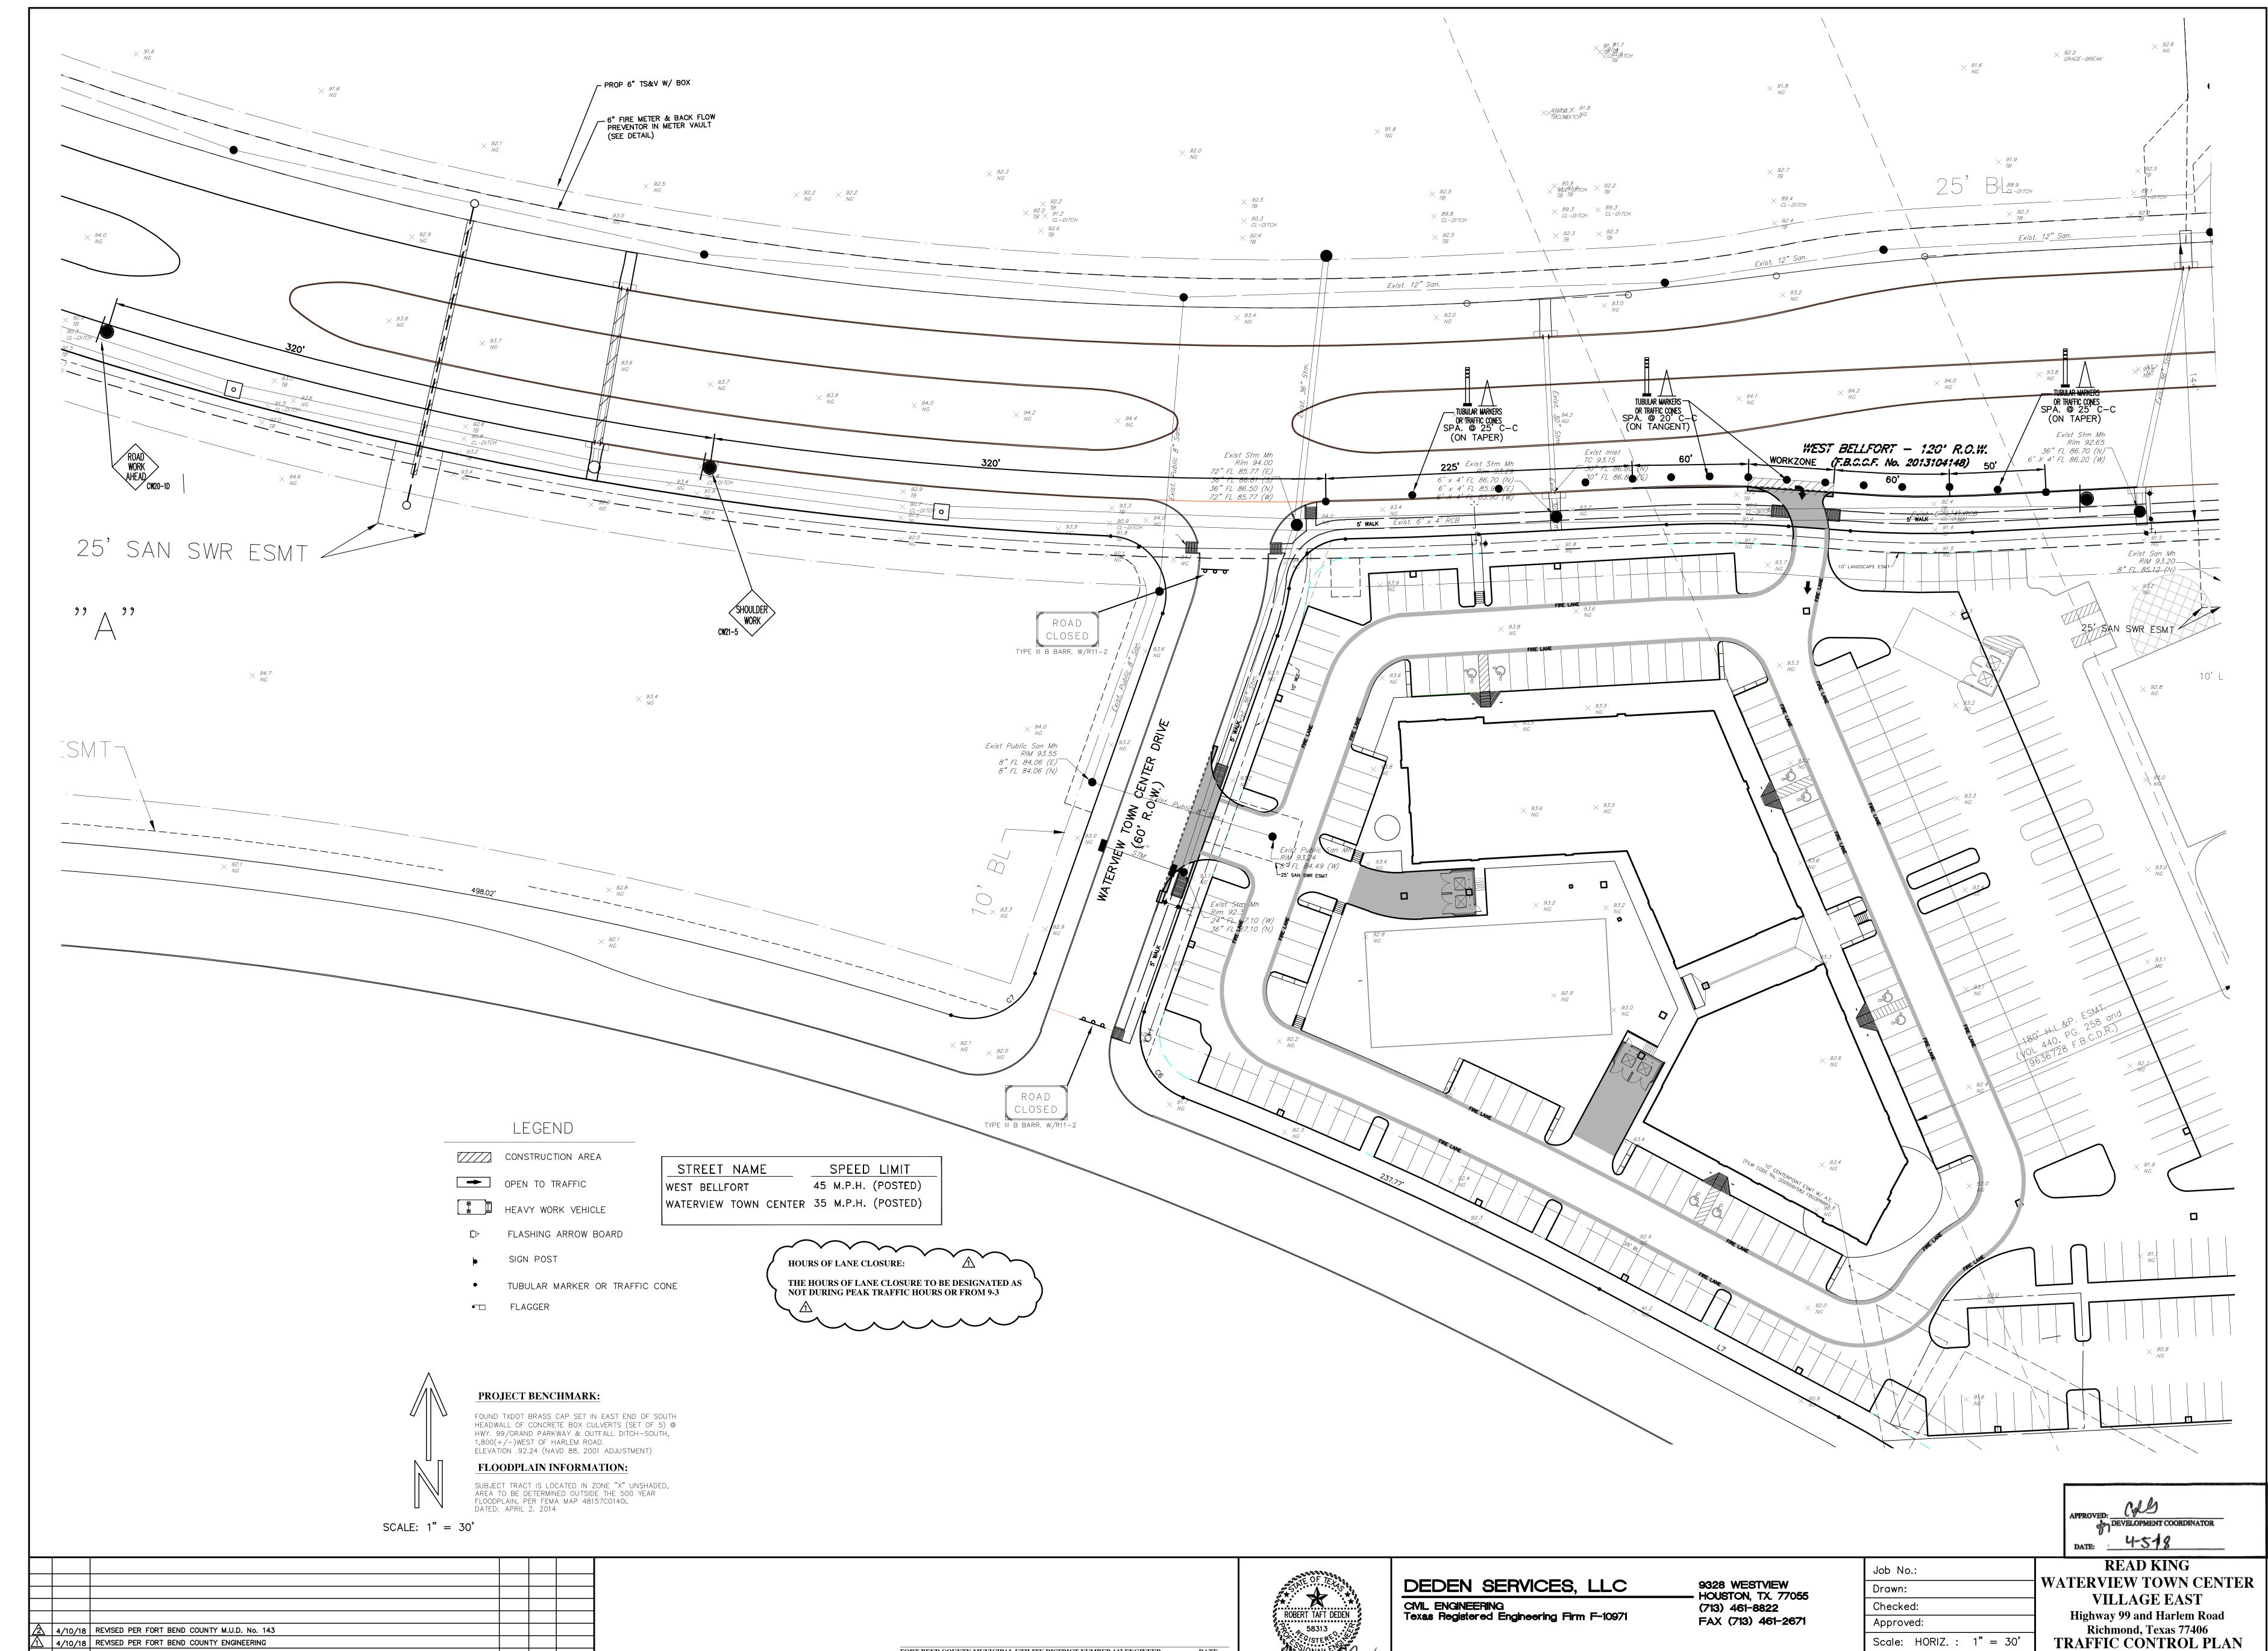

NO. DATE

BY CK APP

REVISIONS

FORT BEND COUNTY MUNICIPAL UTILITY DISTRICT NUMBER 143 ENGINEER, SIGNATURE VALID FOR ONE (1) YEAR

58313 (C) COSTERED (C)

03-20-2018

DATE: JANUARY 2018 SHEET 12 OF 12