PO#153615

# CHANGE ORDER

#### Distribution:

- ☑ FBC Engineering
- ☑ FBC Purchasing
- ☑ Contractor
- Consultant

# FORT BEND COUNTY ENGINEERING

Address:

301 Jackson Street

Richmond, Texas 77469

Phone:

281-633-7500

Fax:

281-342-7366

Web site:

www.FortBendCountyTx.gov

PROJECT:	CHANGE ORDER NUMBER	03
Cane Island Parkway from FM 1463 to I10	DATE	6/25/2018
	PROJECT NUMBER	13306
CONTRACTOR:	CONTRACT FOR	\$4,478,858.50
Earth Builders	CONTRACT DATE	06/14/2017
	FBC PURCHASE ORDER NO	153615

## The contract is changed as follows:

The contract TCP calls for construction of the temporary detour pavement on the south side of FM 1463 to match the existing cross slope of 11% from Station 13+15 to Station 113+57 (Sheet 18, 19, 20). This places the temporary pavement inside the existing ditch line. Due to the flat topography of the area, during a rain event, water will accumulate in the existing ditch resulting in standing surface water on the temporary pavement.

On February 2, 2018, the contractor sent an RFI to resolve the issue.

On March 7, 2018, Fort Bend, AECOM, EHRA, TEDSI, and Earth Builders met on site to discuss the issue and develop options to prevent standing water on the temporary pavement. EHRA, TEDSI recommendation was to reduce the superelevation from 11% to 6% on FM 1463 which resulted in raising the elevation of the existing pavement and temporary pavement. FM 1463 is within TxDOT ROW; therefore, re-design requires approval by TxDOT.

On March 19, 2018, AECOM, EHRA, TEDSI and Earth Builders met with TxDOT to discuss the TCP revisions.

On March 29, 2018, EHRA provided the approved TCP revisions (addendum No. 13). TxDOT also agreed to allow work on weekend nights between the hours of 8:00PM to 8:00AM.

On April 13, 2018, Earth Builders submitted a CO cost for temporary pavement build up on FM 1463 of \$50,130.03, AECOM reviewed this cost and it is fair and reasonable (See Attached).


On April 30, 2018, Fort Bend approved CO cost.

On May 18, 2018, Earth Builders proceeded with the construction of temporary pavement on FM 1463.

Due to the issue with the detour temporary pavement, the contractor will not finish the work on time. The contractor is requesting a time extension of 60 days. This will move the finish date from July 12, 2018 to September 10, 2018.

Not valid until signed by Fort Bend County and Contractor.				
The Original (Contract Sum)	\$	4,478,858.50		
Net change by previously authorized Change Orders	\$	238,129.04		
The (Contract Sum) Prior to this Change Order was	\$	4,716,987.54		

The ( <b>Contract Sum</b> ) will be increase by this Change Order in the amount of	sed or  decreased or  unchanged	1	\$	50,130.03
The new (Contract Sum) including this	Change Order will be		\$	4,767,117.57
The Contract Time will be ⊠ increased The Date of Substantial Completion as of	<ul> <li>or ☐ decreased or ☐ unchanged by 6 of this Change Order therefore is ☐ Changed or ☐ unchanged to</li> </ul>			
	Authorized:			
Fort Bend County Engineering J Stacy Slavinski, P.E. 301 Jackson Richmond, Texas 77469  By:  (sprinture) DATE:	CONTRACTOR Earth Builders. 3711 Briar Park Dr. Ste 350 Houston, TX 77042 By: (stynature) DATE: 7/03/2018	301 Jacks Richmord By:	Robert on St., # I, Texas	E. Hebert 4719 77469

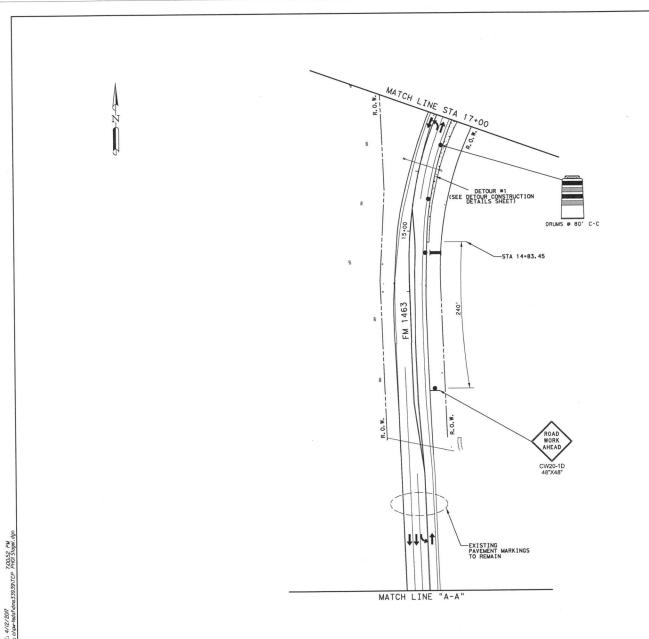


	LEGEND
	PERMANENT PAVEMENT CONSTRUCTED THIS PHASE
	PERMANENT PAVEMENT CONSTRUCTED ON WEEKENDS
	PERMANENT PAVEMENT CONSTRUCTED PREVIOUS PHASE
	TEMPORARY PAVEMENT CONSTRUCTED THIS PHASE
654	TEMPORARY PAVEMENT CONSTRUCTED PREVIOUS PHASE
A	WORK ZONE PYMT MARK (NON-REM) 4" WHITE SOLID
В	WORK ZONE PYMT MARK (NON-REM) B" WHITE SOLID
[0]	WORK ZONE PYMT MARK (NON-REM) 4" YELLOW SOLID
CC	WORK ZONE PYMT MARK (NON-REM) 4" DOUBLE YELLOW SOLID
D	WORK ZONE PYMT MARK (NON-REM)
E	WORK ZONE PYMT MARK (REM)
F	WORK ZONE PVMT MARK (REM) 4" WHITE SOLID
G	WORK ZONE PVMT MARK (REM) 4" YELLOW SOLID
HH	WORK ZONE PVMT MARK (REM)
	LOW PROFILE CONCRETE BARRIER (LPCB)
<b>→</b>	DIRECTION OF TRAFFIC FLOW
	TYPE III BARRICADE
•	CHANNELIZING DEVICE
•	CONSTRUCTION SIGN
$\Box$	TRAILER MOUNTED FLASHING ARROW BOARD (TMFAP)



			T
NO.	DATE	REVISION	APPROVED



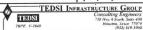





EHRA 10555 Westoffice Drive Houston, Texas 77042 713.784.4500 EHRAinc.com

CANE ISLAND PARKWAY (FM 1463 TO IH10) TRAFFIC CONTROL PLANS
PHASE 1
STAGE 1

		SHEET	2	OF	4
DN: TEDSI	PROJ	ECT NO.	HIGH	YAY	NO.
CK DN: TEDSI			CANE	ISI	AN
DW: TEDSI	STATE	COUNTY	SHEE	T	١0.
		TERRE DENIE		10	

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N	JMBER	LIST OF SHEETS	NUMBER	EIOT OF OHEETO	UMBER	LIST OF SHEETS	DETAIL C	1
		GENERAL		DRAINAGE DETAILS		TRAFFIC SIGNAL TRAFFIC SIGNAL SUMMARY	DETAILS	
	1	COVER SHEET INDEX OF SHEETS	99-100	DRAINAGE AREA MAP	183 184	TRAFFIC SIGNAL NOTES		1
	2	GENERAL NOTES		DRAINAGE STANDARDS	185-186 187	TRAFFIC SIGNAL LAYOUT AN	CHOR BOLT DIAGRAM	- 1
	4-5 6-12	PROJECT LAYOUT TYPICAL SECTIONS	101	CURB INLET TY C - HIL-C(HOU)	101			- 1
	0 12		102 103	INLET TYPE A - HIL-A (HOU) INLET TYPE AD & AAD - HIL-AD/AAD (HOU)		TRAFFIC SIGNAL	STANDARDS	- 1
		TRAFFIC CONTROL PLAN	104	MANHOLES TYPES A & B - MH-A/B (HOU) MISCELLANEOUS SEWER DETAILS - MSD (HOU)	188 189	TRAFFIC SIGNAL CONTROLLER FOUNDATION DE SIGNAL DETAILS/STANDARDS	SIGNAL HEAD SPAN WIRE	- 1
	13	TRAFFIC CONTROL PLAN SLAMARY	105 106	CUTTER DEPRESSION DETAILS FOR CURB THEFTS - CD (NOIL)	190	MOUNT DETAILS - SHS/WMD( OVERHEAD STREET NAME SIG	HOU) N MOUNTING DETAILS - OSNS/MD(HC	ou)
	14 15	TRAFFIC CONTROL PLAN GENERAL NOTES TRAFFIC CONTROL PLAN SEQUENCE OF CONSTRUCTION	107	GOT TER DEPTRESSION DELIES FOR CONTROL THE TERM PERCAST ASSETT END TREATMENT IT IT-PARALLEL DRAIN - PSET-SP PRECAST ASSETT END TREATMENT IT IT-PARALLEL DRAIN - PSET-SP PRECAST ASSETT END TREATMENT IN THE PROPERTY OF THE PROPERTY OF THE PSET OF TH	191	SIGNAL DETAILS/STANDARDS FOR POLE MOUNTED (APS) P	CONSTRUCTION DETAILS EDESTRIAN SIGNALS - CD/PM(APS)	PS (HOU)
	16	TRAFFIC CONTROL DI AN ADVANCE WADNING STONE	108-109	EXCAVATION AND BACKFILL DIAGRAMS - EABD (HOU)	192-193	TRAFFIC SIGNAL SUPPORT 5	HOU)  M MOUNTING DETAILS - OSNS/MD(HC CONSTRUCTION DETAILS DEDESTRIAN SIGNALS - CD/PM(APS)) TRUCTURES STRAIN POLE ASSEMBLIE -100(1)-12 TO SP-100(2)-12 DATIONS - TS-FD-12 GS FOR LUMINAIRE MAST ARM - CFA-	ES
	201-20 201-20	TRAFFIC CONTROL PLAN PHASE STAGE STEP TO TRAFFIC CONTROL PROPERTY OF THE PROPER	diamina.	HEFO COMMETE CHANGE LINES DETAILS HEFO ARTICULATING CONCRETE BLOCK DETAILS A TYPICAL STOMS SERVER OUTFALL DETAILS	194 195	TRAFFIC SIGNAL POLE FOUN	DATIONS - TS-FD-12	
,	25-28	TRAFFIC CONTROL PLAN PHASE 1 STAGE 2 STEP 1 TRAFFIC CONTROL PLAN PHASE 1 STAGE 2 STEP 2	111	TYPICAL RENT DETAIL FOR CGMP OUTFALL	195	STRUCTURES - LUM-A-12	V POR LIBITUATOR MAST ADM - CEA.	_10
	29-32 33-33A	TRAFFIC CONTROL PLAN PHASE 2	113	TYPICAL BEDDING AND BACKFILL DETAIL FOR CGMP OUTFALL	196	ROADWAY ILLUMINATION DET	Y FOR LUMINAIRE MAST ARM - CFA- AILS - FIXTURES - D-07	-12
	(33-33A)	TRAFFIC CONTROL PLAN DETOURS CONSTRUCTION DETAILS		UTILITY STANDARDS PROTECTIVE SLAB FOR EXISTING PIPELINES	199-204	ELECTRICAL DETAILS - ED( PEDESTRIAN FACILITIES CU	1)-14 TO ED(7)-14	
	Cuth	TRAFFIC CONTROL STANDARDS	114	IN HIGH COMPRESSIVE STRESS APPLICATIONS (KINDER MORGAN)	205-208	PEDESTRIAN FACILITIES CU	RB RAMP - PED-12A	
	34 35	TRAFFIC CONTROL PLAN - TCP (2-1)-12 TRAFFIC CONTROL PLAN - TCP (2-3)-12		BRIDGE DETAILS		ENVIRONMENTAL		
	35 36 37	TRAFFIC CONTROL PLAN - TCP (3-1)-13 TRAFFIC CONTROL PLAN - TCP (3-3)-14	115-116	BRIDGE LAYOUT	209-212	STORM WATER POLLUTION PR	EVENTION PLAN	
	38-49	DADDICADE AND CONSTRUCTION STANDARDS - BC (1)-14 - BC (12)-14	117 118	ESTIMATED QUANTITIES AND BEARING SEAT ELEVATIONS ABUTMENT NO. 1 AND 7				
	50 51	TRAFFIC SIGNAL WORK TYPICAL DETAILS - WZ(BTS-1)-13 TRAFFIC SIGNAL WORK BARRICADES AND SIGNS - WZ(BTS-2)-13	119 120	ABUTMENT DETAILS BENT NO. 2 THRU 6		ENVIRONMENTAL S TEMP EROSION, CONTROL ME		
	52 53	WORK ZONE SHORT TERM PAVEMENT MARKINGS - WZ(STPM)-13 LOW PROFILE CONCRETE BARRIER - LPCB-13(TY1)	121	BENT DETAILS	213	(FENCE & VERTICAL TRACK)	(NG) - EC(1)-16	
	54	LOW PROFILE CONCRETE BARRIER - LPCB-13(TY2)	122-123 124-125	GIRDER LAYOUT SLAB DETAILS	214 215	TEMP EROSION, CONTROL ME EROSION CONTROL LOG - EC	ASURES (CONSTRUCTION EXITS) - 1	EC (3) -16
	55 56-57	WORKSHEET FOR EDGE CONDITION TREATMENT TYPES PROJECT SIGN DETAILS	126	PRESTRESSED CONCRETE I-GIRDER DESIGNS (NON-STANDARD SPANS) - IGND	2.0			
				THOSE OF THE PARTY TO THE PARTY				
	58-59	ROADWAY DETAILS SURVEY CONTROL MAP		BRIDGE STANDARDS PRESTRESSED CONCRETE 1-GIRDER DETAILS - IGD				
	60	HORIZONTAL ALIGNMENT DATA	127-128 129-131	ELASTOMERIC BEARING AND GIRDER END DETAILS - IGEB				
	61 -63 64-75	PLAN & PROFILE & "A" PLAN & PROFILE & "B"	132-133	MISCELLANEOUS SLAB DETAILS - IGMS CONTINUOUS SLAB DETAILS - IGCS				
	76 77	PLAN & PROFILE & "C" PLAN & PROFILE & "D"	135	THICKENED SLAB END DETAILS - IGTS MINIMUM ERECTION AND BRACING REQUIREMENTS - MEBR(C)				
	78	SUPERELEVATION DETAILS	136-137 138-141	PRESTRESSED CONCRETE PANELS - PCP				
	79-80	INTERSECTION DETAILS	142 143-144	PRESTRESSED CONCRETE PANEL FABRICATION DETAILS - PCP-FAB PERMANENT METAL DECK FORMS - PMDF				
			145-146	SFALED EXPANSION JOINT (TYPE A) - SEJ-A		[	5 6/29/17 ADDED ACB DETAIL	F. SIGNORELLI
		ROADWAY STANDARDS  JOINTED REINFORCED CONCRETE PAVEMENT DETAILS - JRCP (HOU)	147-149A 150	TRAFFIC RAIL - TYPE C223 CEMENT STABILIZED ABUTMENT BACKFILL - CSAB			6 10/03/17 ADDED PRECAST BOX DETAIL	F. SIGNORELLI
	81-82 83	CONCRETE PAVING DETAILS JOINT SEALS - JS-14	151-152 153	COMMON FOUNDATION DETAILS - FD BRIDGE APPROACH SLAB - BAS-C			1 3 3/29/18 ADDED PHASE 1 STAGE 1 STEP 2 REVISED DETOUR GEOMETRY	F. SIGNORELLI
	84-85 86-87	CONCRETE PAVEMENT JUNCTURES - CPJ(HOU) DRIVEWAY DETAILS - DD(HOU)	154	CONCRETE RIPRAP AND SHOULDER DRAINS - CRR BRIDGE RAISED SIDEWALK AND MEDIAN DETAILS - BRSM			NO. DATE REVISION	APPROVED
	88	CONCRETE CURB AND DIRECTIONAL ISLAND DETAILS - CC & DID(HOU) CONCRETE CURB AND CURB AND GUTTER - CCCG-12	154A-154B	BRIDGE KAISED SIDEMALK AND MEDIAN DETAILS - BROWN		1		
	89 90	METAL BEAM GLIARD FENCE - GF(31)-14					SOLD WAR	
	91 92	METAL BEAM GUARD FENCE (DOWNSTREAM ANCHOR TERMINAL) - GF (31) DAT- METAL BEAM GUARD FENCE TRANSITION	14	SIGNING AND PAVEMENT MARKINGS			FREDERICK 4 SGNORELLI	
		(THRIE BEAM TRANSITION) - GF(31)TR-14 MOW STRIP - MS(HOU)	155	PAVEMENT MARKING SUMMARY			123290	
	93 94	STACLE CHAPDRATI TERMINAL (SET 31) (WOOD POST) - SGT (R) 31-14	156-160 161	SIGNING AND PAVEMENT MARKINGS SUMMARY OF SMALL SIGNS				
	95 96	SINGLE GUARDRAIL TERMINAL (SKT 31) (STEEL POST) - SGT(85)31-14 SINGLE GUARDRAIL TERMINAL (X-LITE) (STEEL POST) - SGT(95)31-14					0-	2-89-10
	97	BRIDGE END DETAILS - BED-14 FORT BEND COUNTY MISCELLANEOUS DETAILS		TRAFFIC SIGNING AND PAVEMENT MARKING ST	<u>TANDARDS</u>		Tan Dugman	J = 1 10
	98	FORT BEND COUNTY MISCELLANEOUS DETAILS	162-164	* TYPICAL STANDARD PAVEMENT MARKINGS - PM(1)-12 TO PM(3)-12 * PAVEMENT MARKINGS (WORDS, ARROWS & SYMBOLS) - PM(WAS)-07(HOU)			0	
			166-170	* TYPICAL SIGN REQUIREMENTS - TSR(1)-13 TO TSR(5)-13			FORT BEND COUNTY	, TEXAS
			474	* REGULATORY SIGNS (LANE USE CONTROL) - R(LUC-1)-04(HOU)  * DELINEATOR AND OBJECT MARKERS - DMOM(1)-15				
			173	# DELINEATOR AND OBJECT MARKERS - DWOM(2)-15 # DELINEATOR AND OBJECT MARKERS - DWOM(3)-15B			10555 Westoffice	e Drive
			175	# DELINEATOR AND OBJECT MARKERS - D&OM(4)-15			EHRA Houston, Texas 7:	7042
			177	# DELINEATOR AND OBJECT MARKERS - D&OM(5)-15 # DELINEATOR AND OBJECT MARKERS - D&OM(6)-15			FHRAinc.com	
			178	* DELINEATOR AND OBJECT MARKERS - DWGM(VIA)-15 * SIGN MOUNTING DETAILS - GENERAL NOTES/DETAILS - SMD(GEN)-08			IBPE No. 1-728	
			179 180-182	* SIGN MOUNTING DETAILS - TRIANGULAR SLIPBASE SYSTEM -			CANE ISLAND PARKWAY (FM 146	3 TO IH10)
				SMD(SLIP-1)-08 TO SMD(SLIP-3)-08			INDEX OF SHE	FTS
							I THOUND OF SHE	

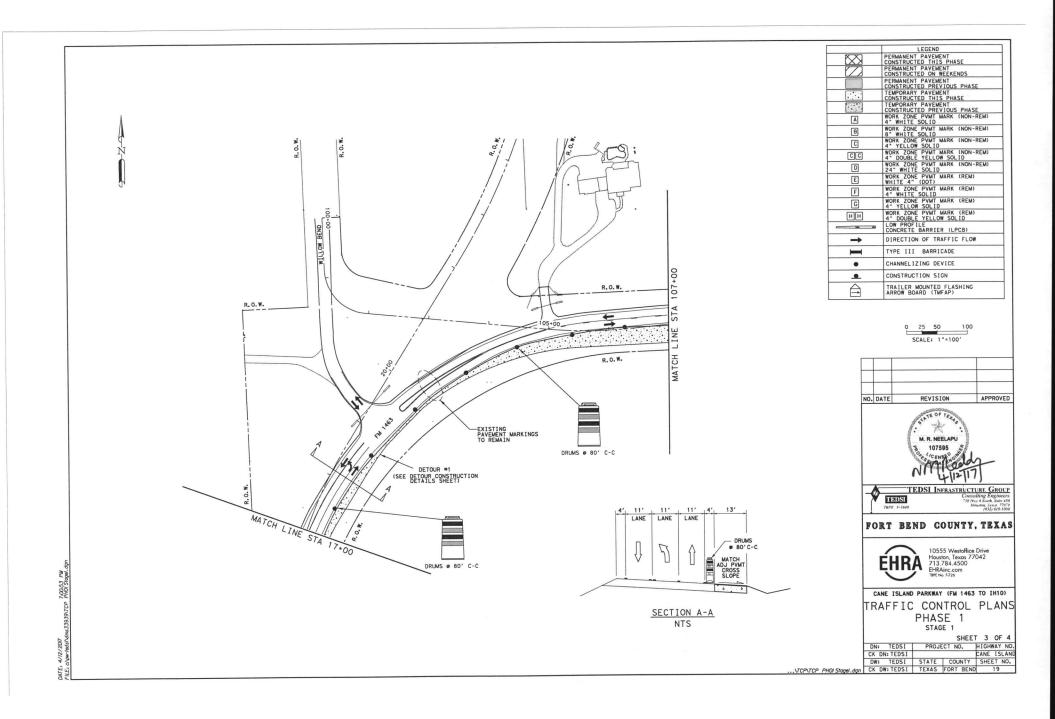NO.	DATE	REVISION	APPROVED
13	3/29/18	ADDED PHASE 1 STAGE 1 STEP 2 REVISED DETOUR GEOMETRY	F. SIGNORELLI
6	10/03/17	ADDED PRECAST BOX DETAIL	F. SIGNORELLI
5	6/29/17	ADDED ACB DETAIL	F. SIGNORELLI

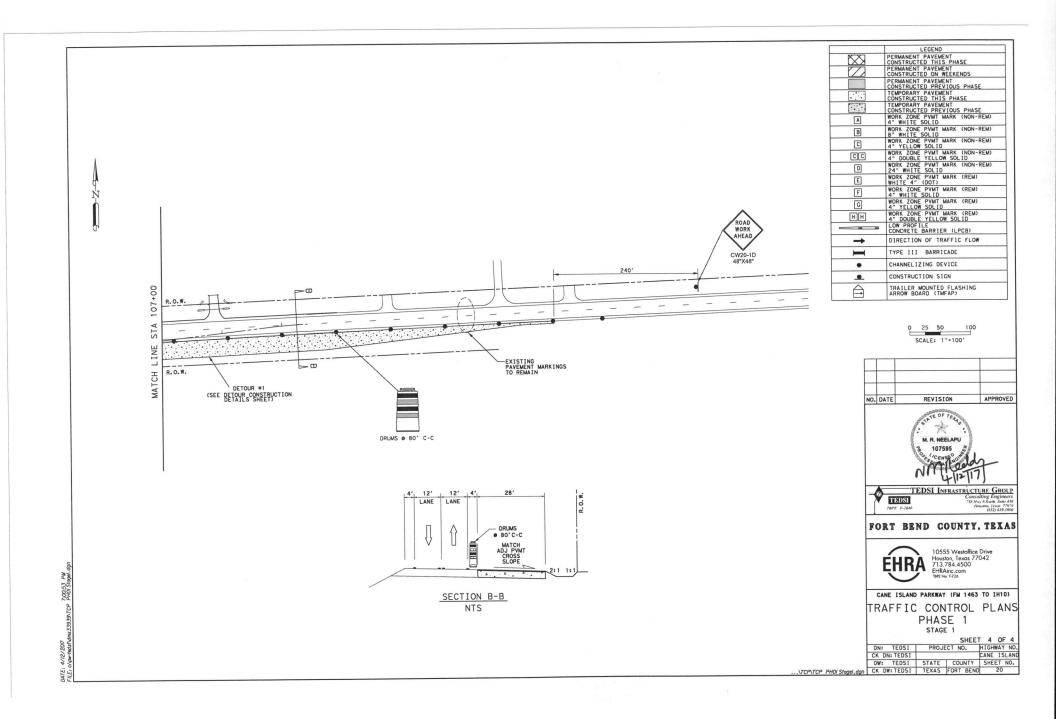



			SHEE		)F 1
DN:	FJS	PROJ	ECT NO.	HIGHWA	Y NO.
CK DN:	SS			CANE I	SLAND
DW:	FJS	STATE	COUNTY	SHEET	NO.
CK DW:	SS	TEXAS	FORT BEND	2	

.\Front Matter\SCI-INDEX.dgn

DATE: 3/29/2018 FILE: P.NIZ-OID-SN.OrowIngs/CAO/Cane Island Parkway/Front Matter/SCI-HIDEX.dgn

NO.	DATE	REVISION	APPROVED
13	3/29/18	ADDED PHASE 1 STAGE 1 STEP 2 REVISED DETOUR GEOMETRY	F. SIGNORELLI
10	1/10/18	ADDED ADDITIONAL LOW PROFILE PORTABLE CTB	MRN



10555 Westoffice Drive Houston, Texas 77042 713.784.4500 EHRAinc.com

CANE ISLAND PARKWAY (FM 1463 TO IH10)
TRAFFIC CONTROL PLAN
SUMMARY

		SHEET	1 0F	1
DN: EHRA	PROJ	ECT NO.	HIGHWAY I	10.
CK DN: EHRA			CANE ISLA	AND
DW: EHRA	STATE	COUNTY	SHEET NO	٥.
CK DW: EHRA	TEXAS	FORT BEND	13	

# PHASE 1 STAGE 1 STEP 1

- 1. RELOCATE UTILITIES IN CONFLICT WITH THE TRAFFIC CONTROL BEFORE BEGIN OF WORK. UTILITIES TO BE RELOCATED INCLUDE THE POWER LINE/POLES IN THE SOUTH SIDE OF FM 1463 ALONG THE EAST LEG
- 2. CONSTRUCT TEMPORARY ASPHALT DETOUR #1 MATCHING EXISTING SLOPE AS SHOWN IN THE PLANS
- 3. RE-ALIGN AND RESHAPE ROAD SIDE DITCHES ALONG RIGHT SIDE OF FM 1463 TO MAINTAIN POSITIVE DRAINAGE

#### PHASE 1 STAGE 1 STEP 2



- 1. RELOCATE UTILITIES IN CONFLICT WITH THE TRAFFIC CONTROL BEFORE BEGIN OF WORK. UTILITIES TO BE RELOCATED INCLUDE THE POWER LINE/POLES IN THE SOUTH SIDE OF FM 1463 ALONG THE EAST LEG
- 2. (FRIDAY 9PM) IMPLEMENT FLAGGER TCP AS SHOWN IN THE PLANS.
- 3. CONSTRUCT TEMPORARY ASPHALT DETOUR #1 (ASPHALT STABILIZED BASE AND HMA (LEVEL-UP) TO CHANGE THE SUPERELEVATION TO 6% MINIMUM AS SHOWN IN THE PLANS. PROVIDE SUPERELEVATION TRANSITIONS OF AT LEAST 170' ON BOTH SIDES.
- 4. RE-ALIGN AND RESHAPE ROAD SIDE DITCHES ALONG RIGHT SIDE OF FM 1463 TO MAINTAIN POSITIVE DRAINAGE
- 5. TAB CENTER YELLOW STRIPE ACCORDING TO PHASE 1 STAGE 2 STEP 1. PLACE OPPOSING TRAFFIC LANE DIVIDERS AT 80' SPACING (SHOWN ON BC(9)-14). PLACE DRUMS MARKERS ALONG EDGELINES.
- 6. OPEN DETOUR TO TRAFFIC BY 9AM ON SATURDAY
- 7. (SATURDAY 9PM) IMPLEMENT FLAGGER TCP AS SHOWN IN THE PLANS.
- 8. CONSTRUCT TEMPORARY ASPHALT DETOUR #1 HMA (SURFACE) TO CHANGE THE SUPERELEVATION TO 6% MINIMUM AS SHOWN IN THE PLANS. PROVIDE SUPERELEVATION TRANSITIONS OF AT LEAST 170' ON BOTH SIDES.
- 9. RE-ALIGN AND RESHAPE ROAD SIDE DITCHES ALONG RIGHT SIDE OF FM 1463 TO MAINTAIN POSITIVE DRAINAGE
- 10. OPEN DETOUR TO TRAFFIC BY 9AM ON SUNDAY

### PHASE 1 STAGE 2 STEP 1

- 1. SHIFT TRAFFIC ALONG FM 1463 TO USE RECENTLY CONSTRUCTED TEMPORARY ASPHALT DETOUR #1 AS SHOWN IN THE PLANS
- 2. INSTALL LOW PROFILE CONCRETE BARRIERS (LPCB) AS SHOWN IN THE PLANS
- 3. CONSTRUCT SOUTH LEG OF FM 1463 FROM STA 13+16 TO STA 18+70.
- 4. CONSTRUCT PAVEMENT SECTION UP TO 1.5" HMA (LEVEL-UP). FINAL 1.5" HMA TO BE COMPLETED DURING PHASE 3
- 5. CONSTRUCT TEMPORARY DETOUR #2 EXTENDING WILLOW BEND TO THE SOUTH TO MATCH ELEVATION OF NEWLY CONSTRUCTED SOUTH LEG OF FM 1463
- 6. INSTALL 24" DRAINAGE PIPE UNDERNEATH DETOUR #2 TO MAINTAIN POSITIVE DRAINAGE AS SHOWN IN THE PLANS

#### PHASE 1 STAGE 2 STEP 2

- 1. MAINTAIN TRAFFIC USING FM 1463 AND DETOUR #1
- 2. SHIFT TRAFFIC ON WILLOW BEND TO RECENTLY CONSTRUCTED EXTENSION AND OBLITERATE SEGMENT OF WILLOW BEND NOT USED ANYMORE
- 3. INSTALL/RELOCATE LPCB AS SHOWN IN THE PLANS
- 4. CONSTRUCT INTERSECTION BEGINNING FROM WILLOW BEND STA 101+62 TO FM 1463 EAST LEG STA 109+42 AND FROM FM 1463 SOUTH LEG STA 18+70 TO CANE ISLAND STA 22+10
- 5. INSTALL 24" DRAINAGE PIPES UNDERNEATH NEWLY CONSTRUCTED INTERSECTION AS SHOWN IN THE PLANS TO MAINTAIN POSITIVE DRAINAGE
- 6. DURING WEEKENDS CONSTRUCT WILLOW BEND FROM STA 100+67 TO STA 101+62 AND ACCESS ROAD AS SHOWN IN THE PLANS. TRAFFIC ALONG WILLOW BEND AND THE ACCESS ROAD TO BE MAINTAINED OPEN AT ALL TIMES USING FLAGGERS OPERATION
- 7. DURING A WEEKEND CONSTRUCT DRIVEWAYS #1 AND #2. ACCESS TO RESIDENCES TO BE MAINTAINED OPEN AT ALL TIMES
- 8. REMOVE AND REINSTALL RCP AND S.E.T UNDERNEATH DRIVEWAY #1
- 9. CONSTRUCT UP TO 1.5" HMA (LEVEL-UP). FINAL 1.5" HMA TO BE COMPLETED DURING PHASE 3
- 10. INSTALL TRAFFIC SIGNAL AT THE INTERSECTION OF FM 1463 WITH WILLOW BEND

#### PHASE 2

- 1. SHIFT TRAFFIC TO NEWLY CONSTRUCTED FM 1463'S EAST AND SOUTH LEGS
- 2. ADJUST TRAFFIC SIGNAL AT FM 1463 AT N. FIRETHORNE RD AS NEEDED FOR THIS PHASE OF CONSTRUCTION
- 3. OBLITERATE DETOURS #1 AND #2 AND SEGMENT OF FM 1463 NOT TO BE USED ANYMORE
- 4. CONSTRUCT EAST SIDE FM 1463 SOUTH LEG FROM STA 13+16 TO STA 18+70
- 5. CONSTRUCT SOUTH SIDE OF FM 1463 EAST LEG FROM STA 103+97 TO STA 109+42
- 6. CONSTRUCTION UP TO 1.5" HMA (LEVEL-UP). FINAL 1.5" HMA TO BE COMPLETED DURING PHASE 3

#### PHASE 3

- 1. ADJUST TRAFFIC SIGNAL HEADS FOR PERMANENT TRAFFIC CONDITIONS
- 2. CONSTRUCT FINAL 1.5" HMA AND INSTALL PERMANENT PAVEMENT MARKINGS USING MOBILE **OPERATION**



13 3/29/18 Added Phase 1 Stage 2 Step 2 Updated detour 1 geometry . Signorelli REVISION APPROVED NO. DATE



TEDSI

FORT BEND COUNTY, TEXAS




10555 Westoffice Drive Houston, Texas 77042 713.784.4500

CANE ISLAND PARKWAY (FM 1463 TO IH10) SEQUENCE OF CONSTRUCTION

DN: TEDST CK DN: TEDSI DW: TEDSI STATE COUNTY SHEET NO. ATCPATCP SEO.dgn CK DW: TEDSI TEXAS FORT BEND


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	LEGEND
	PERMANENT PAVEMENT CONSTRUCTED THIS PHASE
	PERMANENT PAVEMENT CONSTRUCTED ON WEEKENDS
	PERMANENT PAVEMENT CONSTRUCTED PREVIOUS PHASE
	TEMPORARY PAVEMENT CONSTRUCTED THIS PHASE
	TEMPORARY PAVEMENT CONSTRUCTED PREVIOUS PHASE
A	WORK ZONE PYMT MARK (NON-REM) 4" WHITE SOLID
В	WORK ZONE PVMT MARK (NON-REM) 8" WHITE SOLID
С	WORK ZONE PVMT MARK (NON-REM) 4" YELLOW SOLID
CC	WORK ZONE PVMT MARK (NON-REM) 4" DOUBLE YELLOW SOLID
D	WORK ZONE PVMT MARK (NON-REM) 24" WHITE SOLID
E	WORK ZONE PVMT MARK (REM) WHITE 4" (DOT)
F	WORK ZONE PVMT MARK (REM) 4" WHITE SOLID
G	WORK ZONE PVMT MARK (REM) 4" YELLOW SOLID
НН	WORK ZONE PVMT MARK (REM) 4" DOUBLE YELLOW SOLID
	LOW PROFILE CONCRETE BARRIER (LPCB)
$\rightarrow$	DIRECTION OF TRAFFIC FLOW
-	TYPE III BARRICADE
•	CHANNELIZING DEVICE
•	CONSTRUCTION SIGN
$\hat{\Box}$	TRAILER MOUNTED FLASHING ARROW BOARD (TMFAP)

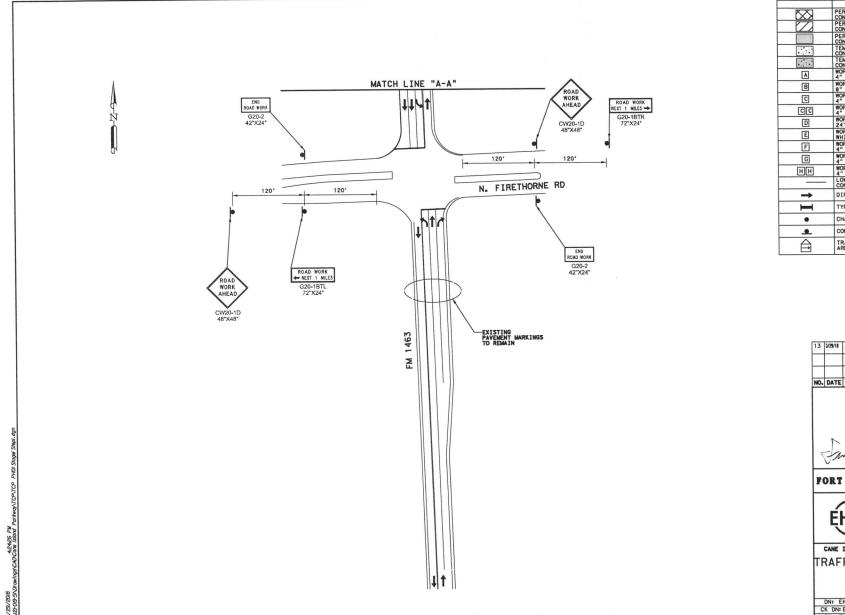0 25 50 100 SCALE: 1"=100'

NO.	DATE	REVISION	APPROVED
13	3/29/18	ADDED PHASE 1 STAGE 1 STEP 2 REVISED DETOUR GEOMETRY	F. SIGNORELLI



FORT BEND COUNTY, TEXAS

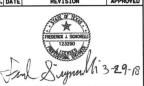

EHRA 10555 Westoffice Drive Houston, Texas 77042 713.784.4500 EHRAinc.com

CANE ISLAND PARKWAY (FM 1463 TO IH10) TRAFFIC CONTROL PLANS
PHASE 1


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DN: EHRA	PROJ	ECT NO.	HIGHW	'ΑΥ	NO
CK DN: EHRA			CANE	ISL	AN
DW: EHRA	STATE	COUNTY	SHEE	T	10.
CK DM+ EHBY	TEYAS	FORT BEND	-	17	

DRUMS . 80' C-C -STA 14+83.71 -EXISTING PAVEMENT MARKINGS TO REMAIN MATCH LINE "A-A"

	LEGEND		
K X I	PERMANENT PAVEMENT		
(XX)	CONSTRUCTED THIS PHASE		
	PERMANENT PAVEMENT		
	CONSTRUCTED ON WEEKENDS PERMANENT PAVEMENT		
	CONSTRUCTED PREVIOUS PHASE		
TEMPORARY PAVEMENT			
- Contraction	CONSTRUCTED THIS PHASE		
	TEMPORARY PAVEMENT CONSTRUCTED PREVIOUS PHASE		
A	WORK ZONE PYMT MARK (NON-REM) 4" WHITE SOLID		
В	WORK ZONE PVMT MARK (NON-REM) 8" WHITE SOLID		
C	WORK ZONE PYMT MARK (NON-REM) 4" YELLOW SOLID		
CC	WORK ZONE PVMT MARK (NON-REM) 4" DOUBLE YELLOW SOLID		
D WORK ZONE PYMT MARK (NON-REM			
E WORK ZONE PVMT MARK (REM) WHITE 4" (DOT)			
F	WORK ZONE PVMT MARK (REM) 4" WHITE SOLID		
G	WORK ZONE PVMT MARK (REM) 4" YELLOW SOLID		
нн	WORK ZONE PVMT MARK (REM) 4" DOUBLE YELLOW SOLID		
	LOW PROFILE CONCRETE BARRIER (LPCB)		
$\rightarrow$	DIRECTION OF TRAFFIC FLOW		
-	TYPE III BARRICADE		
•	CHANNELIZING DEVICE		
•	CONSTRUCTION SIGN		
$\triangle$	TRAILER MOUNTED FLASHING ARROW BOARD (TMFAP)		



NO.	DATE	REVISION	APPROVED
13	3/29/18	ADDED PHASE 1 STAGE 1 STEP 2 REVISED DETOUR GEOMETRY	F. SIGNORELLI

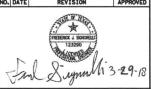

## FORT BEND COUNTY, TEXAS




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CANE ISLAND PARKWAY (FM 1463 TO IH10)

TRAFFIC CONTROL PLANS
PHASE 1
STAGE STEET 2 OF 4


DN: EHRA	PROJECT NO.		HIGHWAY NO.
CK DN: EHRA			CANE ISLAN
DW: EHRA	STATE	COUNTY	SHEET NO.
CK DW: EHRA	TEXAS	FORT BEND	18

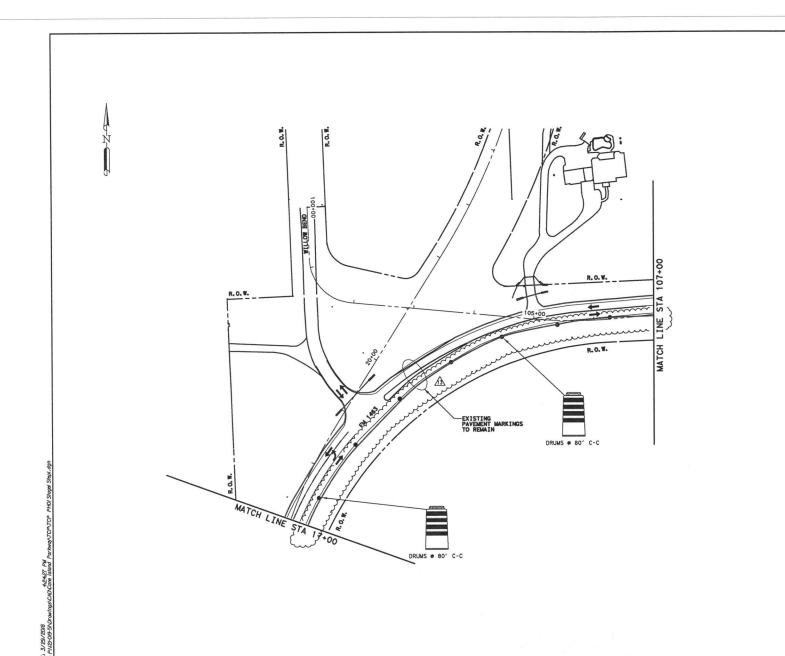

	LEGEND			
	PERMANENT PAVEMENT CONSTRUCTED THIS PHASE			
	PERMANENT PAVEMENT CONSTRUCTED ON WEEKENDS			
	PERMANENT PAVEMENT CONSTRUCTED PREVIOUS PHASE			
	TEMPORARY PAVEMENT CONSTRUCTED THIS PHASE			
	TEMPORARY PAVEMENT CONSTRUCTED PREVIOUS PHASE WORK ZONE PVMT MARK (NON-REM) 4" WHITE SOLID WORK ZONE PVMT MARK (NON-REM) 8" WHITE SOLID WORK ZONE PVMT MARK (NON-REM) 4" VELLOW SOLID WORK ZONE PVMT MARK (NON-REM) 4" VELLOW SOLID OUBLE YELLOW SOLID			
A				
В				
C				
CC				
D				
E				
F	WORK ZONE PVMT MARK (REM) 4" WHITE SOLID			
G	WORK ZONE PVMT MARK (REM) 4" YELLOW SOLID			
НН	WORK ZONE PVMT MARK (REM) 4" DOUBLE YELLOW SOLID			
	LOW PROFILE CONCRETE BARRIER (LPCB)			
<b>→</b>	DIRECTION OF TRAFFIC FLOW			
I	TYPE III BARRICADE			
•	CHANNELIZING DEVICE			
•	CONSTRUCTION SIGN			
$\triangle$	TRAILER MOUNTED FLASHING ARROW BOARD (TMFAP)			

0 25 50 100 SCALE: 1"=100'

NO.	DATE	REVISION	APPROVED
13	3/29/18	ADDED PHASE 1 STAGE 1 STEP 2 REVISED DETOUR GEOMETRY	F. SIGNORELLI

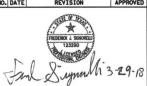


# FORT BEND COUNTY, TEXAS




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CANE ISLAND PARKWAY (FM 1463 TO IH10)

TRAFFIC CONTROL PLANS
PHASE 1
SHEET 3 OF 4
DNI EHRA PROJECT NO. HIGHWAY NO.
CK DNI EHRA STATE COUNTY SHEET NO.
CK DW: EHRA STATE COUNTY SHEET NO.
CK DW: EHRA TEXAS FORT BEND 19



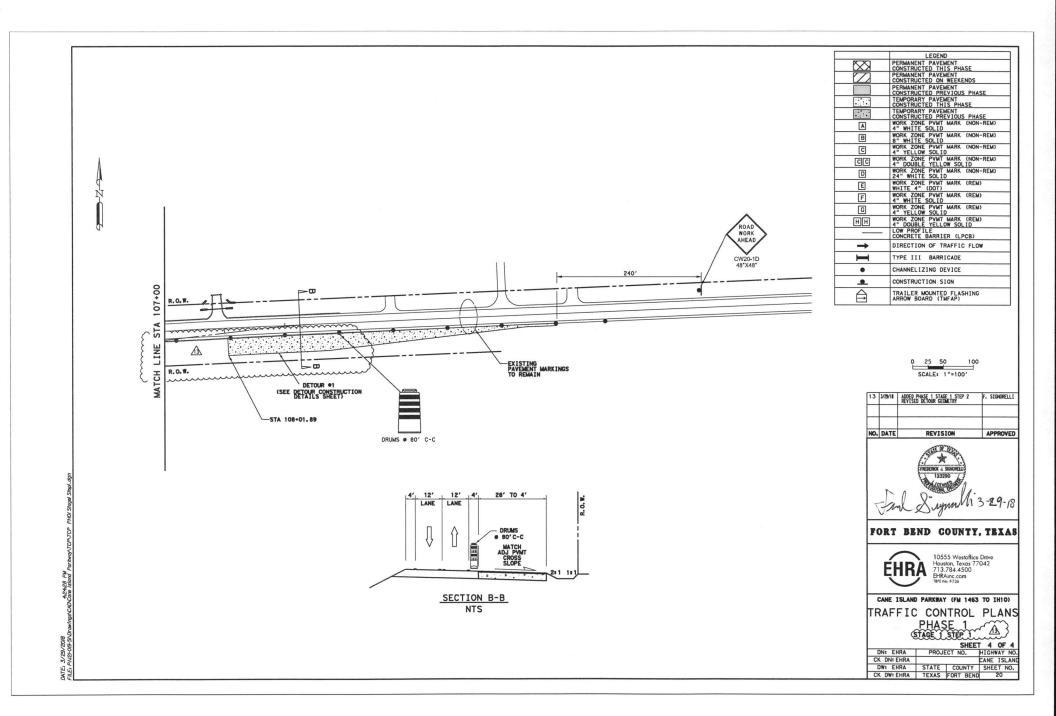

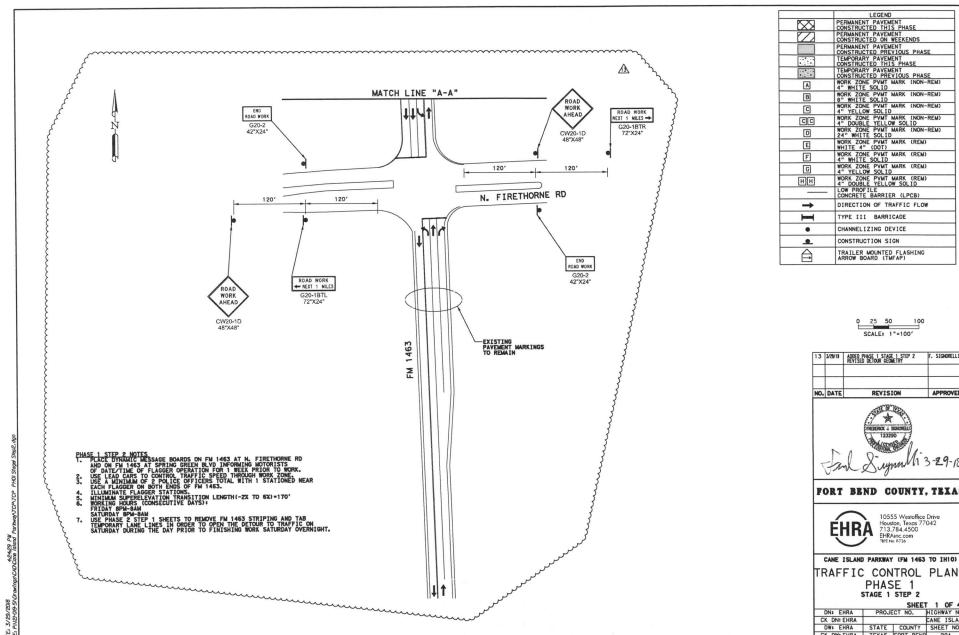LEGEND					
	PERMANENT PAVEMENT CONSTRUCTED THIS PHASE				
	PERMANENT PAVEMENT CONSTRUCTED ON WEEKENDS				
	PERMANENT PAVEMENT CONSTRUCTED PREVIOUS PHASE				
	TEMPORARY PAVEMENT CONSTRUCTED THIS PHASE				
	TEMPORARY PAVEMENT CONSTRUCTED PREVIOUS PHASE WORK ZONE PVMT MARK (NON-REM) 4" WHITE SOLID				
A					
В	WORK ZONE PVMT MARK (NON-REM) 8" WHITE SOLID				
С	- WORK TONE DUNT MARK (NON-DEM)				
CC					
D					
E					
F	WORK ZONE PYMT MARK (REM) 4" WHITE SOLID				
G	WORK ZONE PYMT MARK (REM) 4" YELLOW SOLID				
нн	WORK ZONE PYMT MARK (REM) 4" DOUBLE YELLOW SOLID				
	LOW PROFILE CONCRETE BARRIER (LPCB)				
<b>→</b>	DIRECTION OF TRAFFIC FLOW				
H	TYPE III BARRICADE				
•	CHANNELIZING DEVICE				
•	CONSTRUCTION SIGN				
$\triangle$	TRAILER MOUNTED FLASHING ARROW BOARD (TMFAP)				

0 25 50 1 SCALE: 1"=100'

NO.	DATE	REVISION	APPROVE
13	3/29/18	ADDED PHASE 1 STAGE 1 STEP 2 REVISED DETOUR GEOMETRY	F. SIGNORELL





### FORT BEND COUNTY, TEXAS


TRAFFIC CONTROL PLANS PHASE 1 STAGE 1 STEP 2


DN: EHRA | PROJECT NO. | HIGHWAY NO. CK DN: EHRA STATE COUNTY SHEET NO.

CK DW: EHRA TEXAS FORT BEND 20A

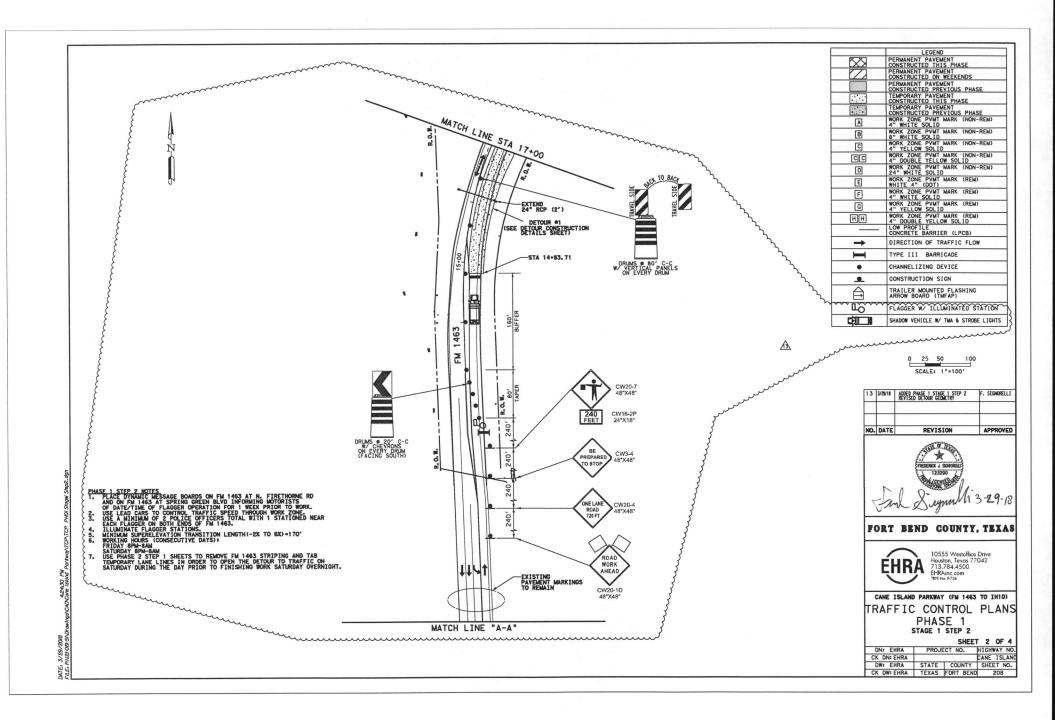

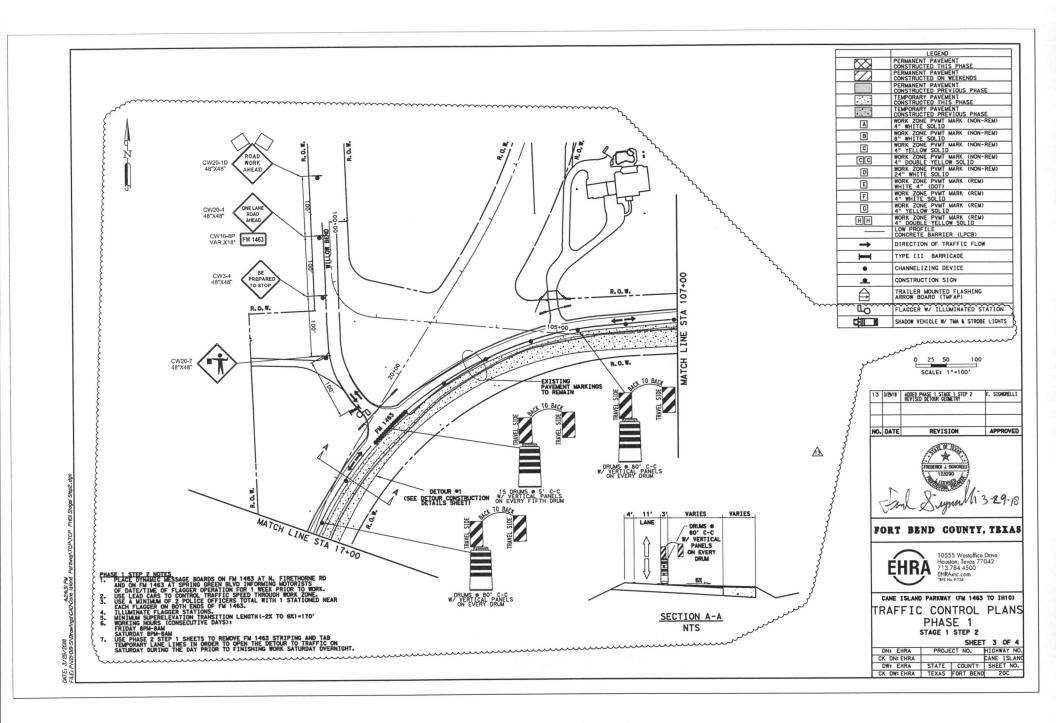

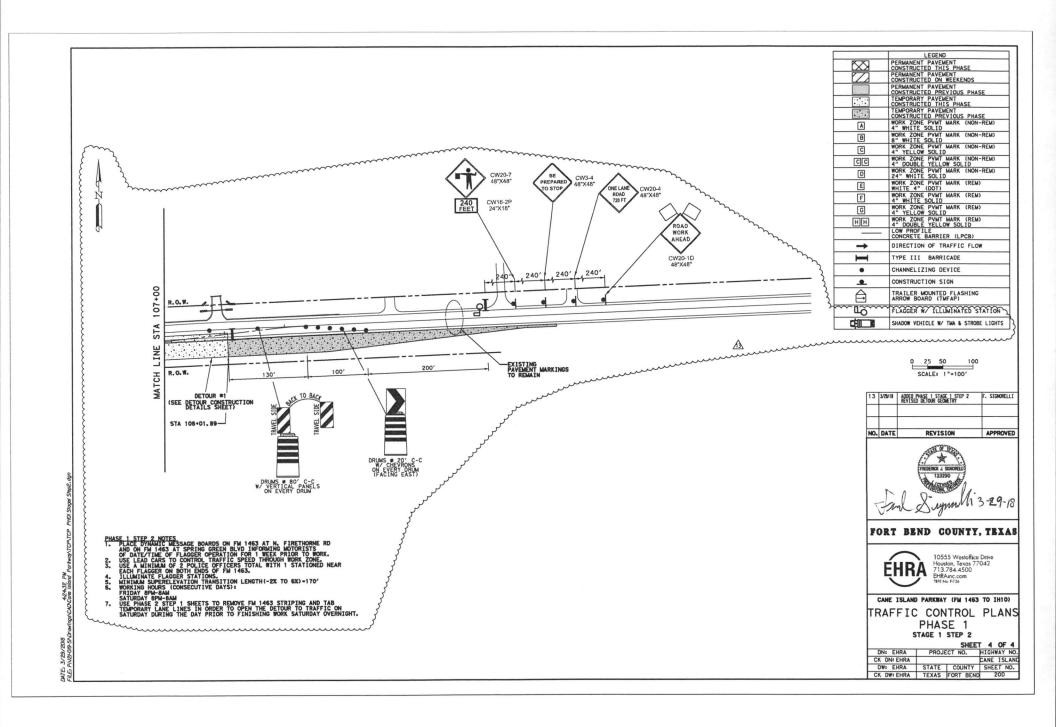

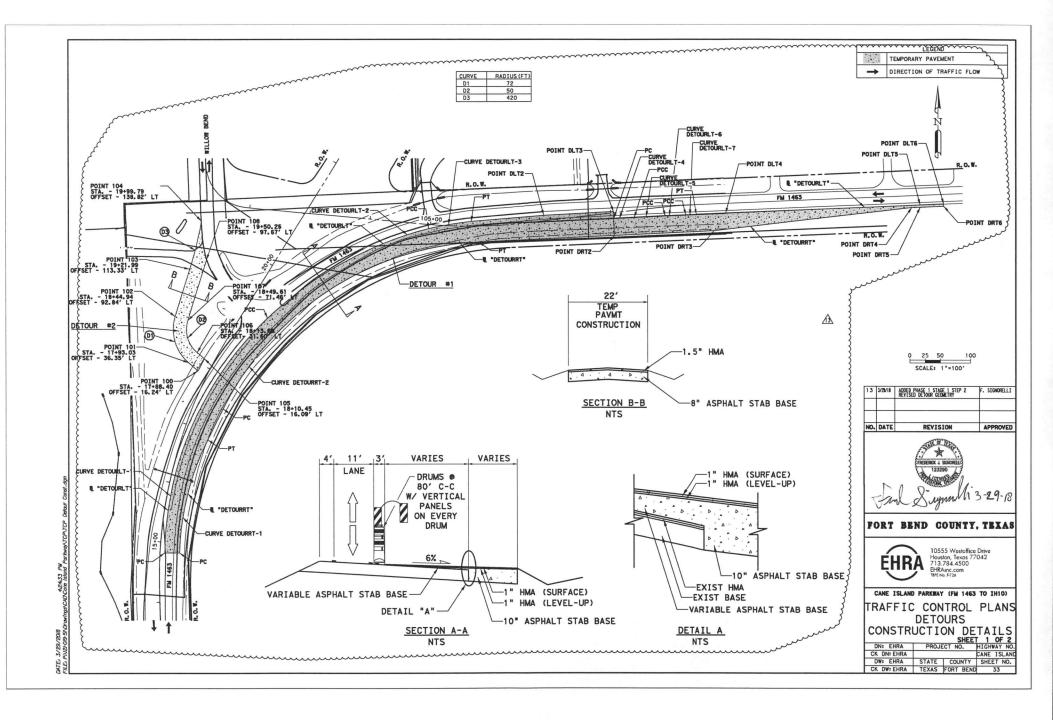

### DETOURLT    Beginning chain DETOURLT description									
Segiming chain DETURIT   description		{	~~~~			LT	~~~	~~~~~	****
Curve Dotod    Curve Dotod	١	\$ 1	Beginning chain	DETOURLT descripti	on				
Curve DETOURILT-2  P.1. Stort on 49 37 02.45 (RT)  Degree 107 267 56.05 (RT		}			Curve Da	ta #			C P D
Long Chard			Tangent = Length = Rodius =	230.21 435.91	X (RT)	2,967,625.59	Y	13,840,431.14	D T L R E L N
Curve Data    Curve Data   Curve Data   Curve Data			Long Chord = Mid. Ord. = P.C. Station P.T. Station C.C. Back = N Ahead = N Chord Bear = N				Y Y Y	13, 840, 200. 96 13, 840, 589. 45 13, 840, 191. 35	i e
Curve DETOURLT-3 P.1. Stortion  Belta  28' 57' 44.87" Delroe  9' 23' 052.00  Length  306.28 Radius  610.57 Externol  18.90  Mic Ord.  9' 13.95  Robert  800K  N 46' 33' 18.14" Chord Bear N 86' 10' 10.51" Externol  18.90  Curve Data  Curve Data  Externol  18.90  Curve Data  Curve Data  Externol  18.90  Curve Data  Externol  18.90  Curve Data  Curve Data  Externol  18.90  Curve Data  Robert  18.90  Curve Data  Curve Data  Externol  18.90  Curve Data  Externol  18.90  Curve Data  Curve Data  Externol  18.90  Robert  19.15  Robert	١	{			Curve Do	rta .			F
Long Chard   305.02   19.35   19.35   Degree = Tangent = Length =	2 6+93.42 28* 55' 44.87" 9* 23' 02.20" 157.50 308.28 610.57	X (RT)	2,967,907.09	Y	13, 840, 697. 75	
Curve DETOURLT-3 P.1. Storlion Delto = 6' 20' 02.53' (81) Degree = 8' 51' 20.18' Tangent = 0.99 Red Us = 647.00 External = 0.99 Red Us = 0.99 Re			Long Chord = Mid. Ord. = P.C. Station P.T. Station C.C. Back = N Ahead = N Chord Bear = N	305.02 19.35 5+35.91 8+44.20 46* 33' 18.14" E 75* 29' 03.00" E 61* 01' 10.57" E	X X X	2,967,792.74 2,968,059.56 2,968,212.60	Y Y	13, 840, 589. 45 13, 840, 737. 23 13, 840, 146. 15	
Curve DETOURLT-3 P. 1	١	ζ			Curve Do	ata			
Tangent		1	Curve DETOURLT- P. I. Station Delta = Degree =	8+80.00 6* 20' 02.53" 8* 51' 20.19"	#		Y	13,840,745.14	
Course from PT DETOURLT-3 to DLT2 N 85' 08' 56.66" E Diet 120.79 Point DLT2			Long Chord = Mid. Ord. = P.C. Station P.T. Station C.C.	35.80 71.53 647.00 0.99 71.49 0.99 8*44.20 9*15.72 1 77* 14' 00.11* E 83* 34' 02.65* E 80* 24' 01.38* E		2, 968, 059, 56 2, 968, 130, 05 2, 968, 202, 54	Ť	13, 840, 737, 23 13, 840, 749, 15 13, 840, 106, 23	
Point DLT2	- 1	ξ	Course from PT	DETOURLT-3 to DLT2	N 85° 08'	56.66" E Dist	120.79		
Course fron DLT2 to DLT3 N 86' 58' 25.02' E Dist 115.76  Point DLT3	- 1	ζ	Point DLT2	x 2,968	,250.40 Y	13,840,759.	37 Sta	10+36.51	
Point DLT3	١	ζ	Course from DLT	2 to DLT3 N 86° 58	' 25.02" E	Dist 115.76			
Curve DetOuRLT-4  P.1. Stortion  P.1. Stortion  O 00 03.65° (LT)  Congent - 0 00 03.65° (LT)  Congent - 1 1778.48 X  P.1. Stortion  P.1. Stortion  O 00 03.65° (LT)  Congent - 0 00 03.65° (LT)  Congent - 1 1778.73°.41  Extermond - 31.45 (Mid. Ord 0.00  P.C. Stortion 11.63.76 X  Alid. Ord 0.00 X  P.C. Stortion 11.63.76 X  Alid. Ord 0.00 X  P.C. Stortion 11.63.76 X  Alid. Ord 0.00 X  P.1. Stortion 11.63.76 X  Curve DeTOuRLT-5  P.1. Stortion 11.63.76 X  Alid. Ord 0.00 X  P.1. Stortion 11.63.76 X  Curve DeTouRLT-5  P.1. Stortion 28.33 X  Curve Detour 18.840,757.00  Degree - 0 00 05.77 (RT)  Degree - 0 00 05.77 (RT)  Curve Detour 18.30 X  Degree - 0 00 00 05.77 (RT)  Degree - 0 00 05.77 (RT)  Degree -	- 1	5					48 Sta	11+52.27	
Curve Data  Curve DETOURLT-4  Partition 11+79.48 X 2,968,382.06 Y 13,840,754.79  Degree 0 0 00 01.60* (LT)  Degree 1 0 00 01.60* (LT)  Degree 1 15.72  Langtin 15.72  Langtin 21,778,773.70  Corve Data  Langtin 21,778,773.70  Langtin 31,45  Rod Lus 1,778,773.70  Long Chard 31,45  Rid Lus 1,778,773.70  P.C. Station 11+63.76 X 2,968,366.36 Y 13,840,755.58  P.T. Station 11+63.76 X 2,968,366.36 Y 13,840,755.58  Cock N 87* 07' 14.30* E  Ahead N 87* 07' 10.65* E  Chard Bear N 87* 07' 10.65* E  Chard Bear N 87* 07' 12.47* E  Curve Data  Curve Data  Curve Data  Curve Data  Curve Data  External 000 05.77* (RT)  Degree 000 05.77* (RT)  Degree 1 000 05.77* (RT)  Degree 2 000 05.77* (RT)  Degree 2 000 05.77* (RT)  Degree 2 000 05.77* (RT)  Degree 3 000 05.77* (RT)  Degree 1 000 05.77* (RT)  Degree 2 000 05.77* (RT)  Degree 3 000 05.77* (RT)  Degree 1 000 05.77* (RT)  Degree 2 000 05.77* (RT)  Degree 3 000 05.77* (RT)  Degree 3 000 05.77* (RT)  Degree 4 000 05.77* (RT)  Degree 5 000 05.77* (RT)  Degree 7 000 05.77* (RT)  Degree 8 07 000 05.77* (RT)  Degree 9 07 000 05.77* (RT)  D	- 1	{	Course from DLT						
Curve DETOURLT-4 P. 1. Startion 11-73.48 X 2,968,362.06 Y 13,840,754.79 Detroe 000 03.65° (LT) Detroe 000 03.65° (LT) Detroe 15.72 Length 13.45 Rod Lus 1,778,373.41 Externol 31.65 Extern		}							7
1.1   Startion   11-79.48   X   2,968,382.06   Y   13,840,754.79	8	ζ	Curson DETOLIDI T.	4	4	*			3
P. C. Stortion 11:93.20 X 2:988.3937.76 V 13:840.755.58 S 7:5 tortion 11:93.20 X 2:879.032.88 Y 15:616, 884.24 S 7:5 tortion 11:93.20 X 2:879.032.88 Y 15:616, 884.24 S 7:5 tortion 11:93.20 X 2:879.032.88 Y 15:616, 884.24 S 7:5 tortion 2:20.25 X 2:879.032.88 Y 15:616, 884.24 S 7:5 tortion 2:20.25 X 2:879.032.88 Y 15:616, 884.24 S 7:5 tortion 2:20.25 X 2:879.032.88 Y 15:616, 884.24 S 7:5 tortion 2:20.25 X 2:879.032.88 Y 15:616, 884.24 S 7:5 tortion 2:20.25 X 2:879.032.88 Y 15:616, 884.24 S 7:5 tortion 2:20.25 X 2:879.032.88 Y 15:616, 884.24 S 7:5 tortion 2:20.25 X 2:968, 426.06 Y 13:840, 757.00 S 7:5 X 2:968, 426.06 Y 13:840, 757.00 S 7	Detour Const		Tangent - Length -	15.72 15.72 31.45 1,778,375.41	<b>,</b>				
C.C. N 87 07' 14.30' E Alacd N 87 07' 10.63' E Chord Bear N 87' 07' 10.63' E Curve Data  C	707	ζ.	P.C. Station P.T. Station	11+95.20	X	2,968,397.76	Ý	13, 840, 755. 58	3
Curve DeTOURLT-5   2-23.53 X 2,968,426.06 Y 13,840,757.00	<b>*************</b>	*	C.C. Back - N Ahead - N Chord Bear - N	87° 07' 14 30° F			Ť	15, 616, 884. 24	3
Curve DETOURILT-5  P.1. Station 12+23.53 X 2,968,426.06 Y 13,840,757.00    Delta	Par	}			Curve D	lata *			3
Notice	ADCane Island	***************************************	Curve DETOURLT-P.I. Station Delta	0* 00' 05.77' 0* 00' 00' 10.19' 28.33	X (RT)	2, 968, 426.06	Y	13,840,757.00	
	P <sub>1</sub> V2H019-5NOrawIngsVC		Long Chord = Mid. Ord. = P.C. Station P.T. Station C.C. Back =	z, 024, 812, 3: 0.00 56.61 0.00 11+95.2: 12+51.8! N 87° 07′ 10.65° I N 87° 07′ 13.54° I		2, 968, 397. 76 2, 968, 454. 35 3, 070, 146. 32	Ť	13, 840, 755, 58 13, 840, 758, 43 11, 818, 501, 34	

B DETOURLT (CONTINUED)	B DETOURRT
Curve Data	Beginning chain DETOURRT description
Curve DETOURLT-6 P.I. Station 12+65.95 X 2,968,468.42 Y 13,840,759.13 Delta = 0* 28* 56.69* (RT)	Curve Data
Degree = 1* 42' 44.58' Tongent = 14.09 Length = 28.17 Rodlus = 3,345.97 External = 0.03 Leng Chord = 28.17	Curve DETOURRT-1 1-98.83 X 2,967,649.34 Y 13,840,299.80 Delta 2 24* 46* 23.53* (RT) Delta - 24* 46* 23.53* (RT) Degree - 12* 43* 58.63* 1 Longth - 194.57 Rod lus - 450.00
P. C. Statlan 12-51, 86 X 2, 968, 494. 35 Y 13, 840, 759. 43 P. T. Statlan 12-80.03 X 2, 968, 482. 49 Y 13, 847, 759. 72 C. C. C. Statlan 12-80, 75 Y 2, 968, 622. 40 Y 13, 837, 416. 68 Back = N 87 07 16. 42 E	External = 10.72 Lang Chord = 193.06 Mid. Ord. = 10.47 P.C. Station 1.00.00 X 2,967,646.26 Y 13,840,201.01
Ahead = N 87° 36° 13.12° E Chord Bear = N 87° 21′ 44.77° E Qurve Data	P.T. Station 2-94.57 X 2,967,693.53 Y 13,840,388.19 C.C. Book 1,147,08.35' E 2,968,096.04 Y 13,840,186.99 Good - N 26' 33' 31.88' E Chard Boor - N 14' 10' 20.11' E
Curve DETOURLT-7 P. I. Station 12+92.16 X 2,968,494.61 Y 13,840,760.23	Course from PT DETOURRT-1 to PC DETOURRT-2 N 26' 33' 31.88" E Dist 57.07
Delta = 0° 03′ 57.68″ (RT) Degree = 0° 16′ 19.92″ Tangent = 12.13	Curve Data
Length = 24.25 Rodius = 21.049.16 External 0.00 Long Chard = 24.25 Mid. Ord. = 0.00 P.C. Stotion 15.04.29 X 2.968,482.49 Y 13,840,759.72 P.C. Stotion 15.04.29 X 2.968,566.73 Y 13,840,760.72 C. Stotion 15.04.29 X 2.968,562.61 Y 13,840,760.72 C. Rock = N 87.56.31.2° E 2 X 2.969,362.61 Y 13,819,728.97	Curve DETOLRRIT-2 6-44.25 X 2,967,849.88 Y 13,840,700.97 Del to 60' 40' 28.51' (RT) Degree - 11' 27' 32.96' Targent - 282.51' 487 Longtha - 500.00 External - 79.33 Long Chord - 505.09
Ahaod N 87* 40' 10.79" E Chord Bedr = N 87* 36' 11.95" E Course from PT DETOURLT-7 to DLT4 N 87* 30' 03.01" E D1st 46.24	Mid. 0rd 68.47 P.C. Station 3-51.63 X 2,967,719.05 Y 13,840,439.24 P.T. Station 8-81.12 X 2,968,142.15 Y 13,840,715.10 C.C. X 2,988,165.28 Y 13,840,215.68
Point DLT4 X 2,968,552.93 Y 13,840,762.74 Sta 13+50.53	Back - N 26" 33' 31.88" E Ahead - N 87" 14' 00.39" E Chard Bear - N 56" 53' 46.13" E
Course from DLT4 to DLT5 N 87° 23′ 30.10° E Dist 320.75  Point DLT5 X 2,968,873.34 Y 13,840,777.33 Sta 16+71.28	Course from PT DETOURRT-2 to DRT2 N 87* 14' 00.39* E DIst 225.73
Course from DLT5 to DLT6 N 87* 39' 47.71" E Dist 38.69	Point DRT2 X 2,968,367.62 Y 13,840,725.99 Std 11+06.85
Point DLT6 X 2,968,912.01 Y 13,840,778.91 Sta 17+09.97	Course from DRT2 to DRT3 N 87* 14' 00.39* E Dist 166.52  Point DRT3 X 2.968.533.94 Y 13.840.734.03 Stg 12+73.37
Ending chain DETOURLT description	Point DRT3 X 2,968,533.94 Y 13,840,734.03 Sto 12+73.37 Course from DRT3 to DRT4 N 83* 13' 47.42" E Dist 328.13
	Point DRT4 X 2,968,859.79 Y 13,840,772.71 Sta 16+01.50
	Course from DRT4 to DRT5 N 87° 23' 34.46" E Dist 13.74
	Point DRT5 X 2,968,873.52 Y 13,840,773.34 Sta 16+15.25
	Course from DRT5 to DRT6 N 87° 39' 47.71° E Dist 38.69
	Point DRT6 X 2,968,912.17 Y 13,840,774.92 Sta 16+53.93
<u>A</u>	Ending chain DETOURRY description

13	3/29/18	ADDED PHASE 1 STAGE 1 STEP 2 REVISED DETOUR GEOMETRY	F. SIGNORELLI
NO.	DATE	REVISION	APPROVED





CANE ISLAND PARKWAY (FM 1463 TO IH10) TRAFFIC CONTROL PLANS DETOURS
CONSTRUCTION DETAILS
SHEET 2 OF 2

DN: EHRA	PROJ	ECT NO.	HIGHWAY NO.
CK DN: EHRA			CANE ISLAN
DW: EHRA	STATE	COUNTY	SHEET NO.
CK DW: EHRA	TEXAS	FORT BEND	33A

Date: 06/15/2018

**Project: Cane Island Parkway** 

Contractor: Earth Builders, LP

FM 1463 Temporary Traffic Detour & Buildup Addendum

No. 13

Item Spec. Description

No.	No.	·	Unit	Qty's	Unit Price	Total
1		Light Towers	EA	4	\$540.00	\$2,160.00
2		Flaggers 3 Each W/ Communication	HR	25	\$90.00	\$2,250.00
3		TMA Truck	Day	2	\$1,300.00	\$2,600.00
4		Electric Message Boards (2) Each	Day	2	\$800.00	\$1,600.00
5		Traffic Control Signs	LS	1	\$3,800.00	\$3,800.00
6		Law Enforcement Officers (2) Each	HR	25	\$104.96	\$2,624.00
33	TX340	2" HMA Ty-C Sac-A PG 70-72	TN	128.39	\$75.00	\$9,629.25
35	TX292	Asphalt Stabilized Base Gr 2 Pg 70	TN	129.95	\$65.00	\$8,446.75
	TX300	EAP & T Tack Coat	GALS	363.64	\$8.25	\$3,000.03
		Temporary Plastic Tabs (Double Yellow)	EA	250	\$2.00	\$500.00
		Temporary Plastic Tabs (White)	EA	260	\$2.00	\$520.00
		Week End and Night Time Operation	LS	1	\$13,000.00	\$13,000.00
Total Additional Work						\$50,130.03

**Project: Cane Island Parkway** 

Contractor: Earth Builders, LP

FM 1463 Temporary Traffic Detour Addendum No. 13

Description	Unit	Qty's	Unit Price	Total	
Night Time and Weekend Additional Hours Required					
Equipment Cost					
RP 195 Road-Tec Paver	HR	12	\$116.00	\$1,392.00	
12M Cat Motor Grader	HR	12	\$107.00	\$1,284.00	
WA 250 Komatsu Loader	HR	12	\$46.00	\$552.00	
CB 534D Cat Roller	HR	12	\$43.00	\$516.00	
Water Truck	Hr	12	\$35.00	\$420.00	
Sweeper	Hr	12	\$25.00	\$300.00	
<u>Labor Rate</u>					
9-Labors at \$30.00 Per Hour Each	HR	12	\$270.00	\$3,240.00	
2-Supervisors with Pickup and Small Tools at \$65.00/Hr. Each	HR	HR 12 \$130.00		\$1,560.00	
	То	tal Equip	\$9,264.00		
Subcontractor Night Time Hour Rate					
Asphalt Plant	Day	2	\$1,500.00	\$3,000.00	
E	Equipment, Labor, & Subcontractor				
	\$613.20				
	\$12,877.20				
	\$128.77				
Total Weekend and Night Time Cost				\$13,005.97	

# **CERTIFICATE OF INTERESTED PARTIES**

FORM **1295** 

of 1

			<u></u>	1011		
	Complete Nos. 1 - 4 and 6 if there are interested parties.  Complete Nos. 1, 2, 3, 5, and 6 if there are no interested parties.	OFFICE USE ONLY CERTIFICATION OF FILING				
1	Name of business entity filing form, and the city, state and count of business.	f business entity filing form, and the city, state and country of the business entity's place ness.				
	Earth Builders,LP		2018-375757			
	Decatur, TX United States		Date Filed:			
2	Name of governmental entity or state agency that is a party to the	e contract for which the form is	07/03/2018			
	being filed.		Base Astronouted and			
	Fort Bend County	Date Acknowledged:				
3	Provide the identification number used by the governmental entit description of the services, goods, or other property to be provided.	ty or state agency to track or identify led under the contract.	the contract, and prov	vide a		
	B17-073					
	Cane Island Parkway from FM 1463 to IH 10					
4			Nature of			
•	Name of Interested Party	City, State, Country (place of busin	·			
			Controlling	Intermediary		
_						
		<del></del>				
_						
5	Check only if there is NO Interested Party.					
6	UNSWORN DECLARATION					
	My name is	and my date of birth				
	My address is			,		
	(street)		tate) (zip code)	(country)		
	I declare under penalty of perjury that the foregoing is true and correct	c.				
	Executed inCounty	, State of . on the	dav of	, 20 .		
		, 5 4.0	(month)	(year)		
Signature of authorized agent of contracting business entity (Declarant)						

# **CERTIFICATE OF INTERESTED PARTIES**

FORM **1295** 

L of 1

	Complete Nos. 1 - 4 and 6 if there are interested parties. Complete Nos. 1, 2, 3, 5, and 6 if there are no interested parties.			OFFICE USE ONLY CERTIFICATION OF FILING		
1	Name of business entity filing form, and the city, state and count of business.	ce Ce	Certificate Number: 2018-375757			
	Earth Builders,LP		ا ا	10 010107		
	Decatur, TX United States		Da	ite Filed:		
2	Name of governmental entity or state agency that is a party to the	e contract for which the form i	o7	07/03/2018		
_	being filed.					
	Fort Bend County			Date Acknowledged:		
			07	07/24/2018		
3	Provide the identification number used by the governmental entit description of the services, goods, or other property to be provide		identify the	contract, and pro	vide a	
	B17-073					
	Cane Island Parkway from FM 1463 to IH 10					
4				Nature of interest		
ĺ	Name of Interested Party City, State, Country (place of busin					
				Controlling	Intermediary	
5	Check only if there is NO Interested Party.					
6	UNSWORN DECLARATION					
	/ly name is, and my date of t			oirth is		
	My address is			.,	,	
	(street)	(city)	(state)	(zip code)	(country)	
	I declare under penalty of perjury that the foregoing is true and correct	t.				
	Executed inCounty	, State of,	on the	day of	, 20	
			-	(month)	(year)	
	Signature of authorized agent of contracting business entity (Declarant)					