

14K

REVIEW BY FORT BEND COUNTY COMMISSIONERS COURT

On this 3rd day of November, 2015, Commissioners Court came on to be heard and reviewed the accompanying notice of United Engineers, Inc / AT & T Job Location 3709 U.S. 59 NORTHBOUND FRONTAGE RD. / COON CREEK, ROSENBERG, TX 77471

Date 10/23/2015 Bond No. CH1-001686693-01, Permit No. 2015-3745 to make use of certain Fort Bend County property subject to, "A Revised Order Regulating the Laying, Construction, Maintenance, and Repair of Buried Cables, Conduits, and Pole Lines, In, Under, Across or Along Roads, Streets, Highways, and Drainage Ditches in Fort Bend County, Texas, Under the Jurisdiction of the Commissioners Court of Fort Bend County, Texas," as passed by the Commissioners Court of Fort Bend County, Texas the 3rd day of August, 1987, recorded in Volume _____ of the Minutes of the Commissioners Court of Fort Bend County, Texas, to the extent that such order is not inconsistent with Article 1436a, Vernon's Texas Civil Statutes. Upon Motion of Commissioner Meyers, seconded by Commissioner Patterson, duly put and carried, it is ORDERED, ADJUDGED AND DECREED that said notice of said above purpose is hereby acknowledged by the Commissioners Court of Fort Bend County, Texas, and that said notice be placed on record according to the regulation order thereof.

Notes:

1. Evidence of review by the Commissioners Court must be kept on the job site and failure to do so constitutes grounds for job shutdown.
2. Written notices are required:
 - a. 48 hours in advance of construction start up, and
 - b. when construction is completed and ready for final inspection
 Mail notices to: Permit Administrator
 Fort Bend County Engineering
 301 Jackson Street
 Richmond, Texas 77469
 281-633-7500
3. This permit expires one (1) year from date of permit if construction has not commenced.

By: [Signature]
County Engineer

Presented to Commissioners Court and approved.
Recorded in Volume 11-03-15
Minutes of Commissioners Court

By: [Signature]
Drainage District Engineer/Manager

Clerk of Commissioners Court
By: [Signature]
Deputy

AT&T Texas/SWBT

ROSENBERG SOUTHWEST UNIT RICH-ROSE '232' W-89232
PROPOSED CONDUIT ALIGNMENT ALONG I.H. 69 (SOUTHBOUND FEEDER)
FOR APPROXIMATELY 4150 FEET.

SHEET INDEX

100	COVER SHEET
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110	PLAN & PROFILE SHEET
111	PLAN & PROFILE SHEET
112	STEEL BEAM
113	GENERAL DETAILS & SPECIFICATIONS
201	GENERAL DETAILS & SPECIFICATIONS
202	GENERAL DETAILS & SPECIFICATIONS
203	TYPICAL TRAFFIC CONTROL PLAN

PROP. M.H. #15167
 Exist. H.H. (Not Found)

PROP. M.H. #15166

PROP. M.H. #15165

PROP. M.H. #15163

PROP. M.H. #15162


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PROP. M.H. #15160


PROP. M.H. #15164



Key Map #603-X
 Zip Code #77471

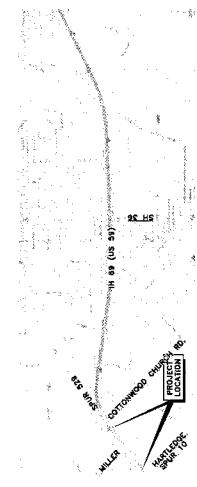

VICINITY MAP

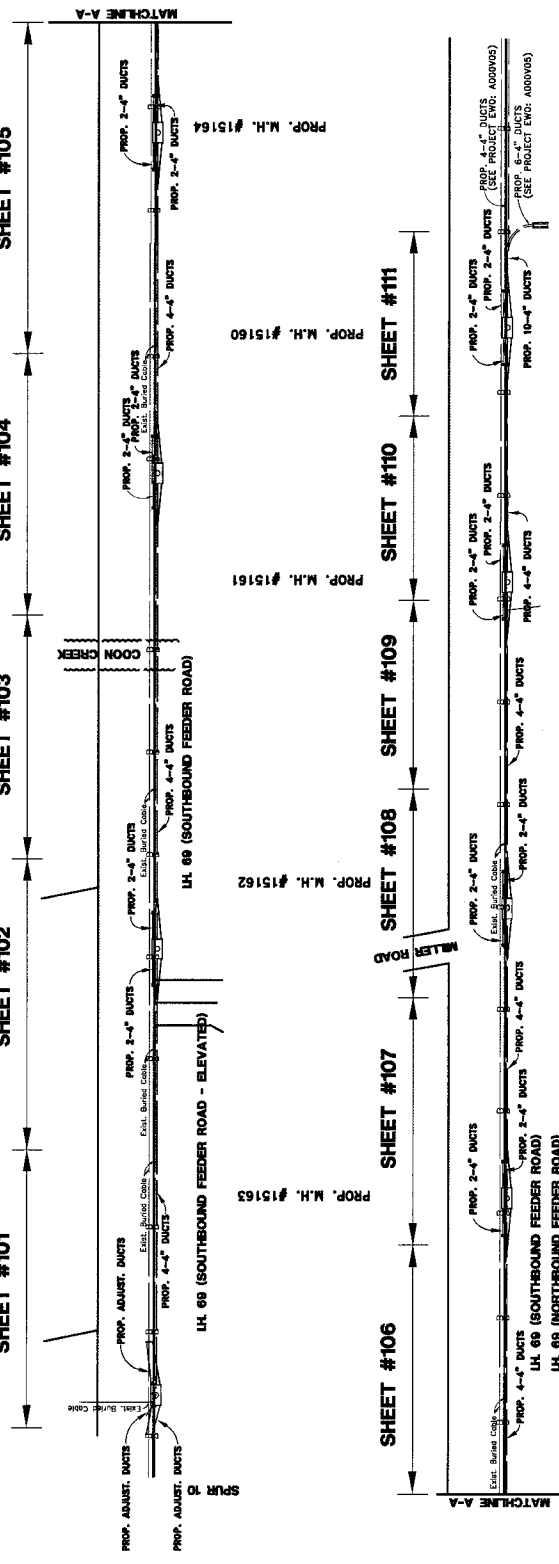

GOVT-BUY AMERICA FHWA PROJECT
 ALL MATERIALS INCLUDING THOSE MATERIALS PROVIDED BY AT&T CONTRACTOR OR SUBCONTRACTOR/S USED IN THIS WORK MUST COMPLY WITH THE FEDERAL HIGHWAY ADMINISTRATION'S BUY AMERICA REQUIREMENTS. SEE THE ATT-TELCO-002-203-860 CARE; BUY AMERICA POLICY AND TxDOT'S BUY AMERICA PROPOSED GUIDELINES-UTILITY ACCOMMODATIONS FOR ADDITIONAL COMPLIANCE REQUIREMENTS INCLUDING INSTRUCTION ON THE USE OF FORM 1818 ON SHEET 218 OF THIS PLAN SET. THE TxDOT FORM 1818 THAT CAN BE DOWNLOADED AT: [HTTP://WWW.TXDOT.GOV/INSIDE-TXDOT/FORMS-PUBLICATIONS/CONSULTANTS-CONTRACTORS/FORMS/MATERIALS.HTML](http://www.txdot.gov/inside-txdot/forms-publications/consultants-contractors/forms/materials.html)

NOTE:
 1. CONTRACTOR MUST OBTAIN A PERMIT FROM MR. JOHNNY ORTEGA, FORT BEND COUNTY PERMIT ADMINISTRATOR, (281) 633-7500, PRIOR TO ANY WORK WITHIN THE COON CREEK RIGHT-OF-WAY.

NOTE:
 CONTRACTOR SHALL CONTACT ISRAEL CABELLAS AT 281-255-7355 PRIOR TO BEGINNING WORK TO OBTAIN APPROVED TRAFFIC CONTROL PLAN. 2. BUY AMERICA ON ROADWAY SURPLUS MATERIAL SHALL BE REMOVED FROM THE RIGHT-OF-WAY AND THE EXCAVATION FINISHED FLUSH WITH SURROUNDING NATURAL GROUND. 4. NO HOSE PITS TO BE LEFT UNPROTECTED. 5. AREA DISBURBED BY WORK SHALL BE RE-SOBBED. 6. PLEASE CONTACT ISRAEL CABELLAS WHEN JOB STARTS AND IS COMPLETED.

I.H. 69 (SOUTHBOUND FEEDER) (PROJECT #9085473)

United Engineers, Inc.
 6665 WEST FLORES DA LINDA BLVD. SUITE 100
 FORT WORTH, TEXAS 76116
 TEL: 817-335-1111 FAX: 817-335-1112
 WWW.UENGINERS.COM

ONE-CALL NOTIFICATION SYSTEM
 CALL BEFORE YOU DIG
 (713) 232-6907 (IN TEXAS)
 (New Statute Number Outside Hourly)
 1-800-368-6000



United Engineers, Inc.
 6665 WEST FLORES DA LINDA BLVD. SUITE 100
 FORT WORTH, TEXAS 76116
 TEL: 817-335-1111 FAX: 817-335-1112
 WWW.UENGINERS.COM

CITY OF ROSENBERG
 DEPARTMENT OF PUBLIC WORKS AND ENGINEERING

PROJECT NO.	9085473
AREA	W-89232
DATE ISSUED	
NUMBER OF SHEETS	17
SHEET NO.	100

(1) WARNING: HIGH PROFILE CABLE
 X49237-072 Fiber in conduit
 3/4" x 1/2" x 1/2" Fiber in conduit
 3/4" x 1/2" x 1/2" Fiber in conduit

(2) WARNING: HIGH PROFILE CABLE
 X49237-072 Fiber in conduit
 3/4" x 1/2" x 1/2" Fiber in conduit

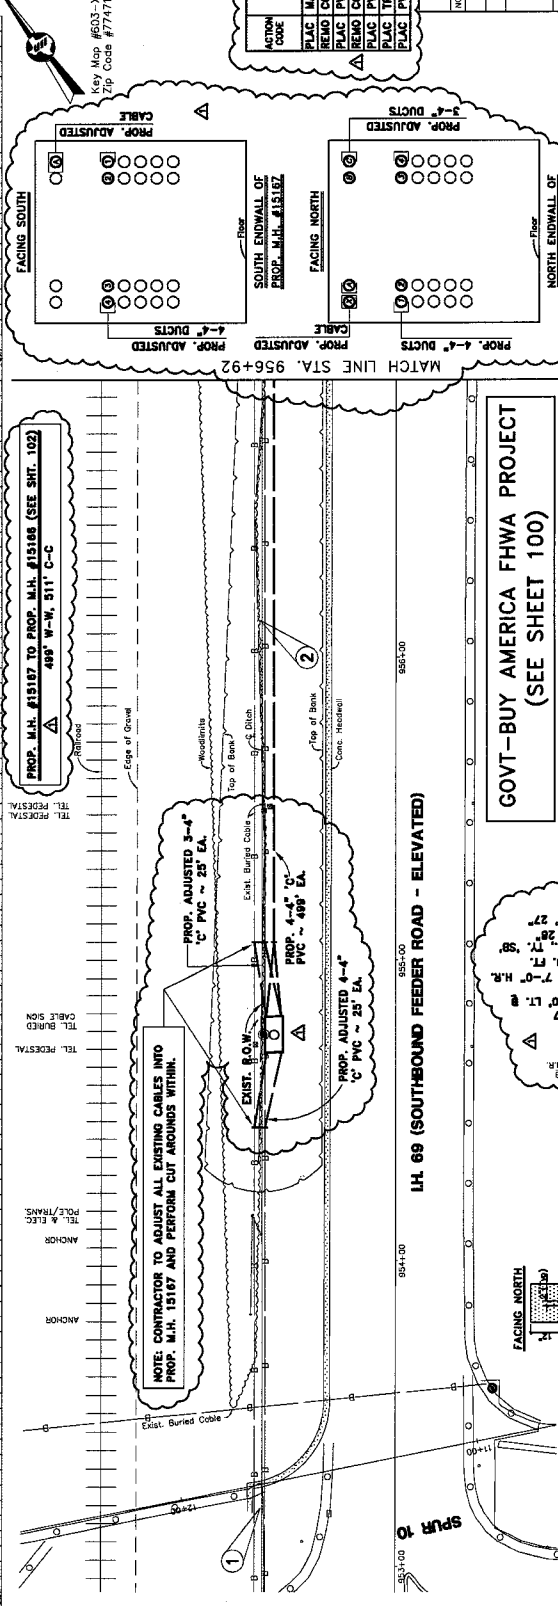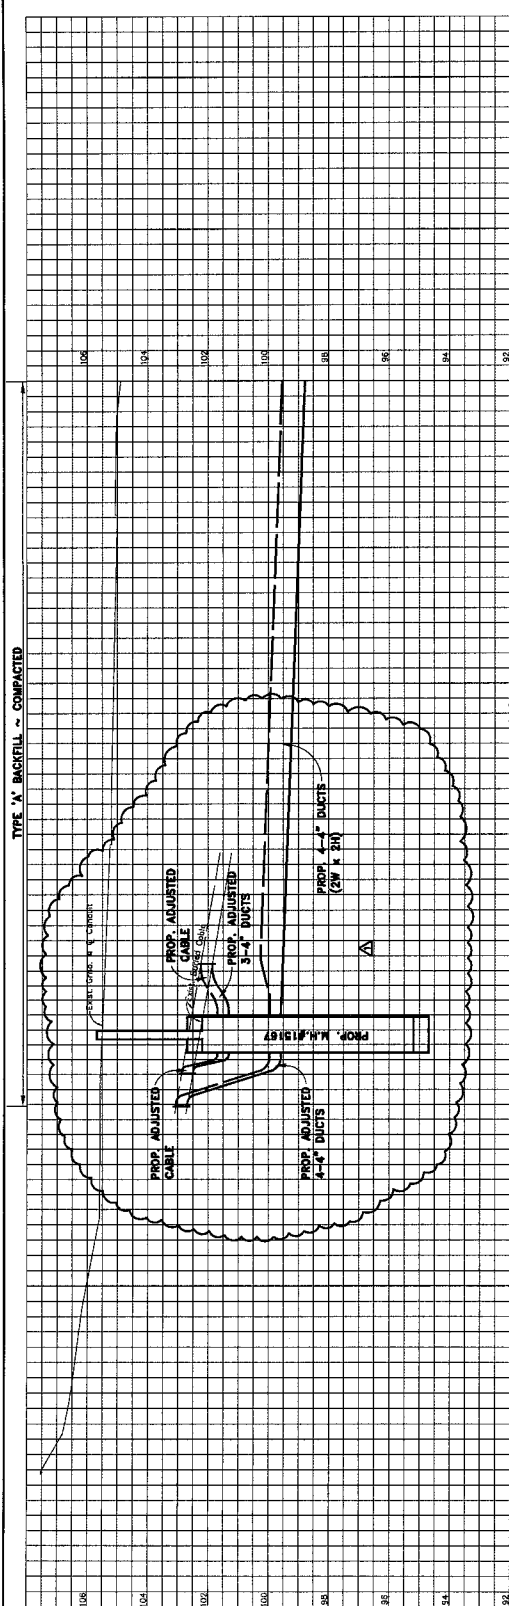

NOTE: SEE SHT. 201 FOR SELF INFLICTED CABLE DAMAGE AVOIDANCE NOTE.

ACTION CODE	TASK SUMMARY	IN. AMT.	PL	BORE	REARVALS AMOUNT	WORT DATE
PLAC	MANHOLE-SPECIAL		1			
REMO	CONDUIT-MFC-4	25'	100'		25'	'88
PLAC	PVC-C-4" 4	25'	100'		25'	'88
REMO	CONDUIT-MFC-3	25'	75'		25'	'88
PLAC	PVC-C-4" 3	25'	75'		25'	'88
PLAC	TRENCH-4-MFC	489'				
PLAC	PVC-C-4" 4	1895'				

AT&T Texas/SWB

NOTE: SIGNATURES VALID FOR ONE YEAR ONLY AFTER DATE OF SIGNATURES

I.H. 69 AND SPUR 10
FORT BEND COUNTY, TEXAS
CITY OF ROSENBERG
 DEPARTMENT OF PUBLIC WORKS AND ENGINEERING

SCALE: PLAN 1" = 20' PROFILE VERT. 1" = 2' PROFILE HORIZ. 1" = 20'

PREPARED BY: [Signature]
 CHECKED BY: [Signature]
 CONTRACT NO: 9085473
 SHEET NO: 101
 DATE: 10/1/88
 AREA: W-89232 Loc. RCH-4055-232' DIST. 50'-01"

United Engineers, Inc. 10101
 10101
 10101

PROP. M.H. #15187 TO PROP. M.H. #15186 (SEE SHT. 102)
 489' W-W, 511' C-C

GOVT-BUY AMERICA FHWA PROJECT
(SEE SHEET 100)



PROP. M.H. #15187
 12'-0" x 8'-0" x 7'-0" H.R.
 VOLUME = 504 CU. FT.
 1.50 F.F.C. 1.78
 L.A. = N 29 31' 40" E 17'
 LONG = W 95 52 27'

SECTION OF PROP. 4-4" DUCTS
 (SEE SHT. 10 FOR CROSSBORT DETAILS)

BENCHMARK:
 I.B.M. "A"
 (crossed down) 400.5/66
 approximately 150 feet north of the intersection with Interstate
 69-10278



WARNING HIGH PROFILE CABLE
 SH-201-072 Flag in conduit
 SH-100-014 Flag buried cable
 SH-201-024 Flag in conduit
 SH-201-024 Flag in conduit

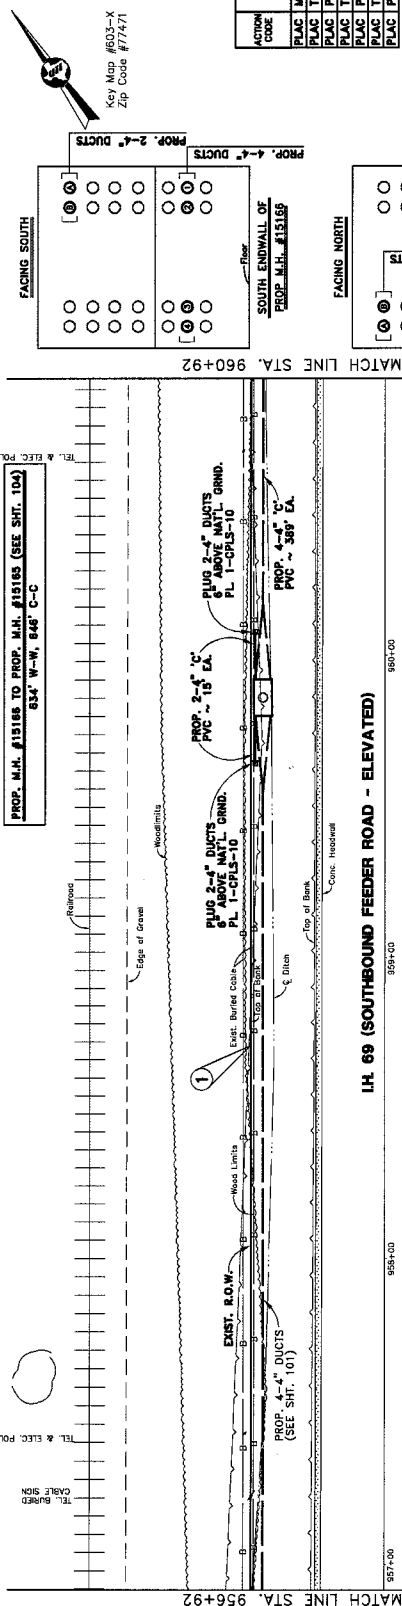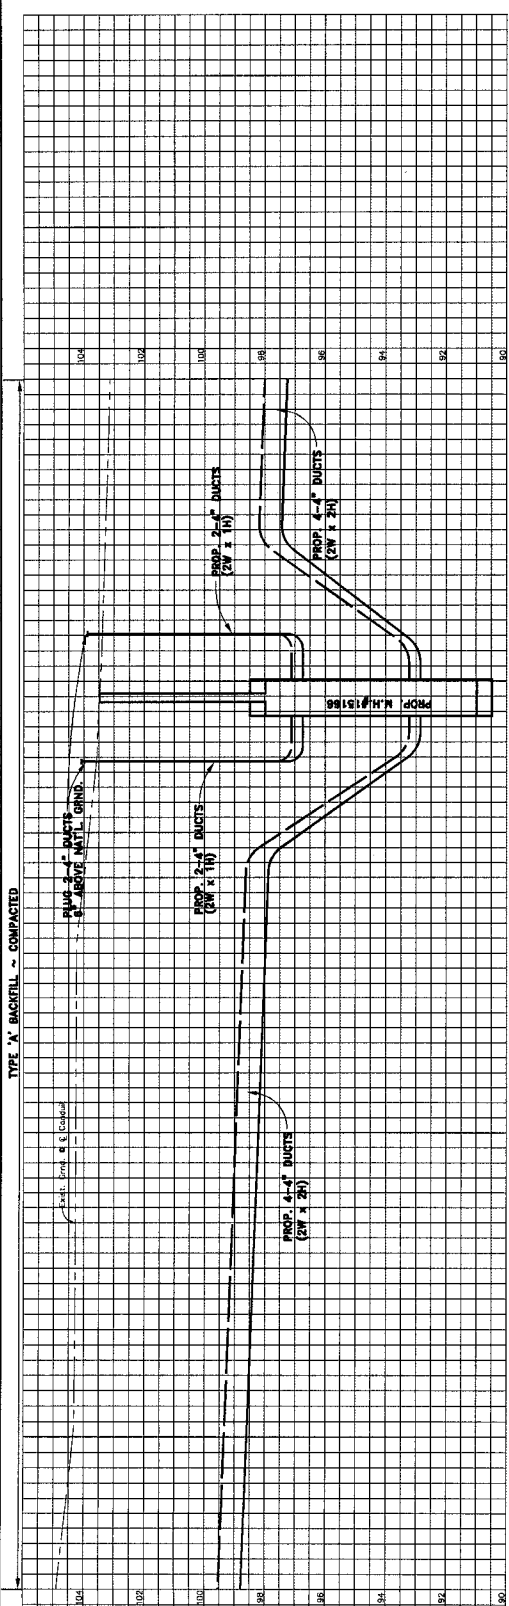

NOTE:
 SEE SHT. 201 FOR SELF INFLECTED CABLE
 DAMAGE AVOIDANCE NOTE.

ACTION CODE	MARK SUMMARY	ML AMT.	PL	BORE	REMOVALS AMOUNT	REMOVALS DATE
PLAC	MANHOLE	15'	1			
PLAC	TRENCH-2-MPC	15'	30'			
PLAC	TRENCH-2-MPC	15'	30'			
PLAC	TRENCH-4-MPC	369'	30'			
PLAC	TRENCH-4-MPC	369'	30'			
PLAC	TRENCH-4-MPC	369'	30'			
PLAC	TRENCH-4-MPC	369'	30'			

AT&T Texas/SWB
 LH 69 (U.S. 59)
 FORT BEND COUNTY, TEXAS
 CITY OF ROSENBERG
 DEPARTMENT OF PUBLIC WORKS AND ENGINEERING

SCALE: PLAN 1" = 30' PROFILE 1" = 2' SINGLE HOLES 1" = 30'

PREPARED BY: [Signature]
 CHECKED BY: [Signature]
 DESIGNED BY: [Signature]
 DRAWN BY: [Signature]
 ISSUE DATE: [Date]

PROJECT NO. 9085473
 SHEET NO. 102
 DATE: 10/15/99
 BY: [Signature]

United Engineers, Inc.
 10000 Katy Road, Suite 100, Houston, TX 77059
 (713) 961-1100

GOVT-BUY AMERICA FHWA PROJECT
 (SEE SHEET 100)





PROP. M.H. #15168
 & STA. 959+86, 41' LT. E
 TYPE 'A' CONC. M.H.
 12'-0" x 6'-0" x 7'-10"
 VOLUME = 504 CU. FT.
 PL - 1'-50" F. & C.; 17" SB.
 LT. = N 28° 21' 26"
 LMO = W 95° 52' 25"

REVISION REVISION DATE

SHEET 3 OF 17

WARNING! HIGH PROFILE CABLE
 344291-012 Fiber Optic Buried Cable
 382231-004 Fiber Optic Cable

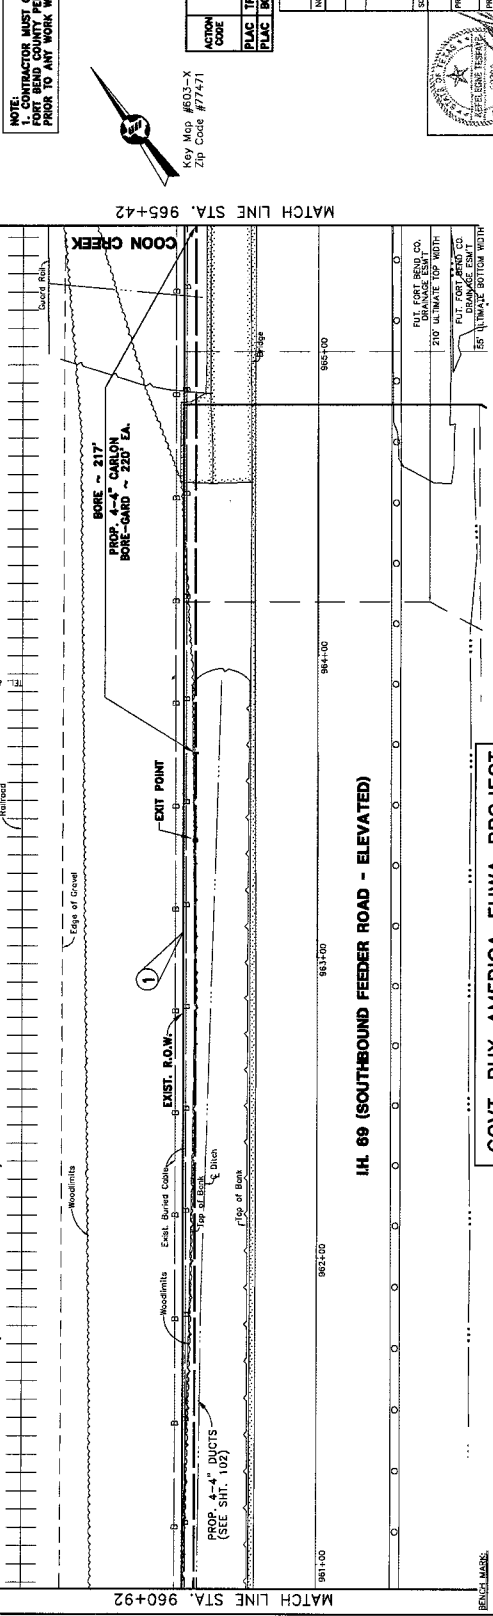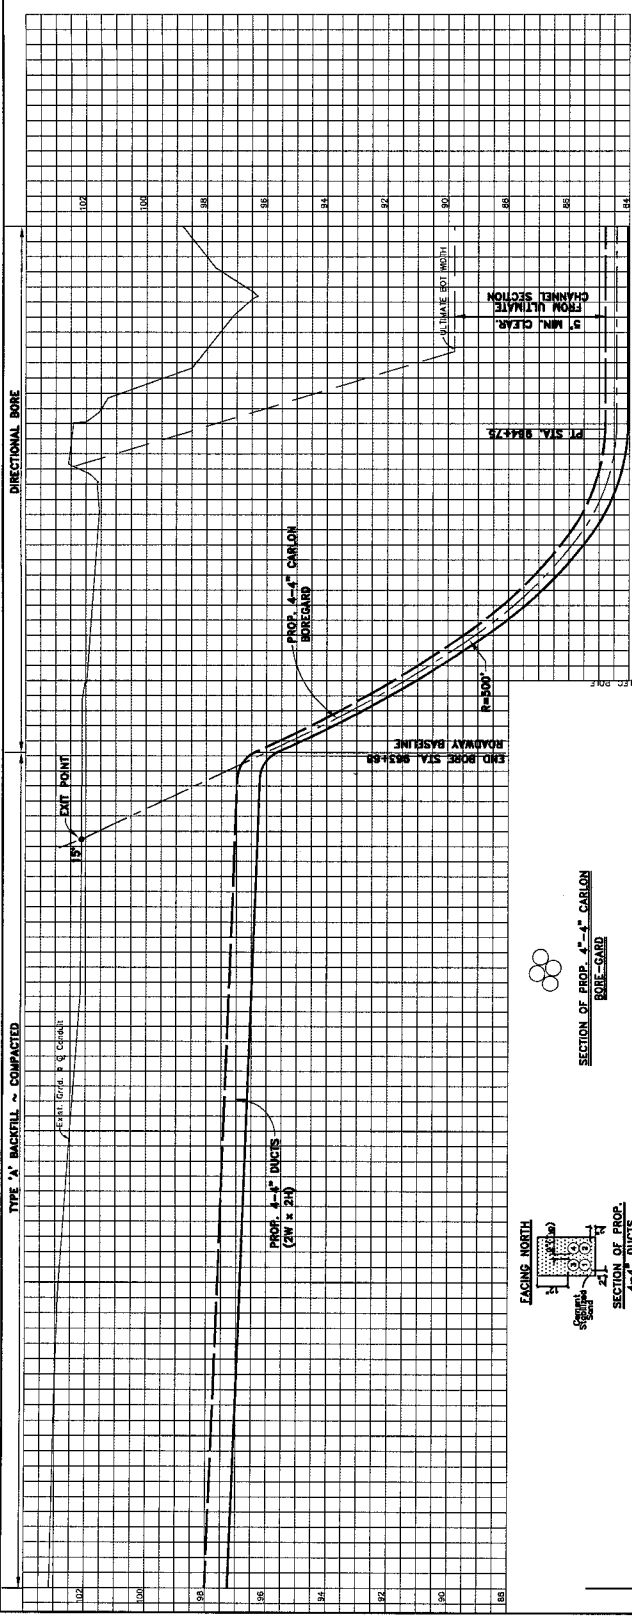

NOTE: CONTRACTOR MUST OBTAIN A PERMIT FROM MR. JOHNNY ORTEGA, FORT BEND COUNTY ENGINEER, PRIOR TO ANY WORK WITHIN THE COON CREEK FRONT-OF-WAY.

NOTE: SEE SHT. 201 FOR SELF INFLECTED CABLE DAMAGE AVOIDANCE NOTE.

Key Map #603-X
 Zip Code #77471

ACTION CODE	TASK SUMMARY	IN. AMT.	PL	BORE AMOUNT	WORT DATE	REMOVALS
PLAC	TRENCH-4-MFC	220'		217'		
PLAC	BORE-GARD-4'-4"		BBG			

AT&T Texas/SWB
 I.H. 69 (U.S. 59)
 FORT BEND COUNTY, TEXAS
 CITY OF ROSENBERG
 DEPARTMENT OF PUBLIC WORKS AND ENGINEERING

SCALE: PLAN 1"=20' PROFILE VERT. 1"=20'

PREPARED BY: [Signature]

DESIGNED BY: [Signature]

CHECKED BY: [Signature]



DATE: 09/05/23

PROJECT: I.H. 69 (U.S. 59)

ISSUE DATE: 10/3




SHEET 4 OF 17
 URS | United Engineers, Inc. | URS # 21075-00

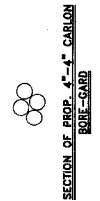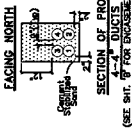

GOVT-BUY AMERICA FHWA PROJECT
 (SEE SHEET 100)

BENCH MARK:
 T.M. 15 Point #22, 5.0' Iron Rod w/Con. located on the north side of I.H. 69 (Southbound Feeder) 1161 feet north of the intersection with Tornidge Drive-104.50'

(1) WARNING: HIGH PROFILE CABLE
 34897-072 Fibre in conduit
 50-500-074 Fibre buried cable

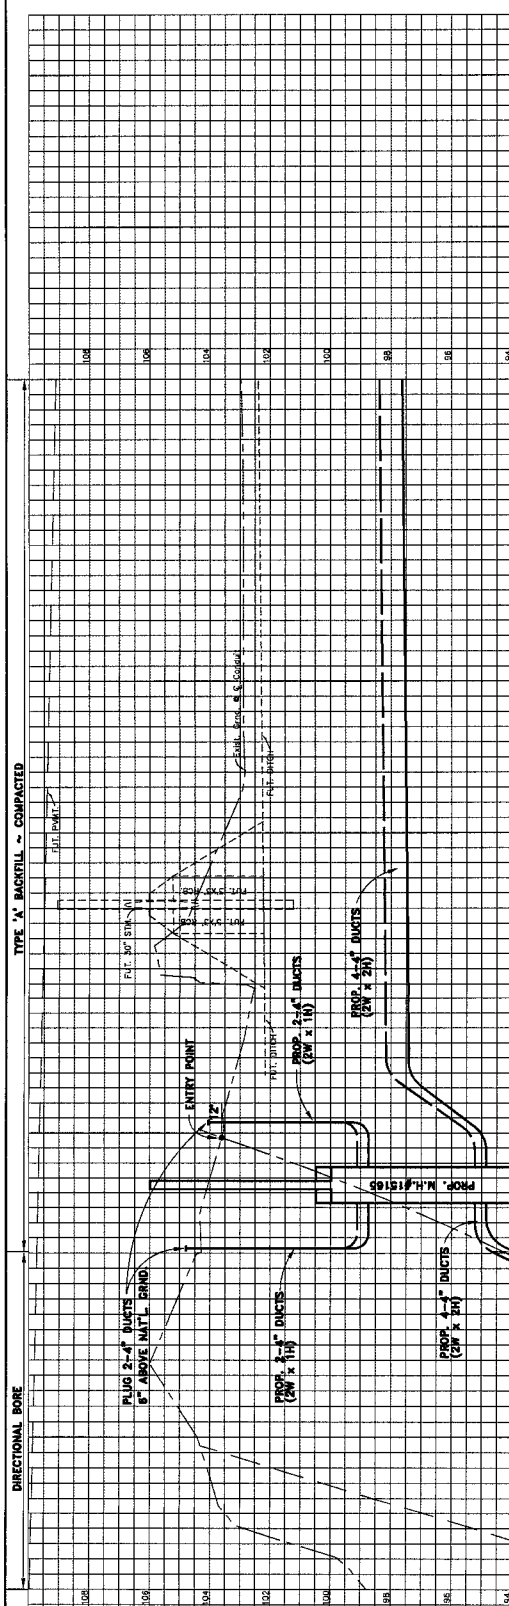

PROP. M.H. #15185 TO PROP. M.H. #15184 (SEE SHT. 103)
 533' W-W, 545' C-C

- ALUMINUM DISK
- TRAFIC SIGN
- GUARD POST
- TEL. CABINET
- TEL. & ELEC. POLE
- WOODS
- WOODS
- WOODS

**GOVT-BUY AMERICA FHWA PROJECT
 (SEE SHEET 100)**

I.H. 69 (SOUTHBOUND FEEDER ROAD - ELEVATED)

PROP. M.H. #15185
 STA. 988+74.44' LT.
 12'-0" x 8'-0" (24' x 24')
 VOLUME = 504 CU. FT.
 P.L. = W 95° 31' 52" S 22' 17" E
 L.S. = W 29° 31' 52" S 22' 17" E

REVISION DATE: _____
 DESCRIPTION: _____
 REVISION DATE: _____
 DESCRIPTION: _____

NOTE: CONTRACTOR MUST OBTAIN A PERMIT FROM MR. JENNIFER ORTEGA,
 TO THE CITY ENGINEER, FOR THE ASSIGNED PERMITS.
 PRIOR TO ANY WORK WITHIN THE RABBS BAND RIGHT-OF-WAY.

NOTE: SEE SHT. 901 FOR SELF INFLATED CABLE
 DAMAGE AVOIDANCE NOTE.
 Key Map #603-X
 Zip Code #77471

ACTON CODE	TASK SUMMARY	M. OR AMT.	FL.	BORE	REMOVALS AMOUNT	ISSUE DATE
PLAC	MANHOLE	1				
PLAC	TRENCH-4-MPC	16'				
PLAC	PVC-C-3'-4	15'				
PLAC	TRENCH-2-MPC	15'				
PLAC	PVC-C-3'-2	30'				
PLAC	TRENCH-2-MPC	15'				
PLAC	PVC-C-3'-2	333'				
PLAC	TRENCH-4-MPC				2132'	

AT&T Texas/SWB
 NOTE: SCHEDULES VALID FOR ONE YEAR ONLY. REFER DATE OF SIGNATURES
I.H. 69 (U.S. 59)
FORT BEND COUNTY, TEXAS
CITY OF ROSENBERG
 DEPARTMENT OF PUBLIC WORKS AND ENGINEERING


PREPARED BY: _____
 CHECKED BY: _____
 DATE: _____

PROJECT NO: 9085473
 SHEET NO: 104
 DATE: 11/15/11
 DRAWN BY: _____
 ISSUE DATE: _____


SCALE: PLAN 1" = 20' PROFILE 1" = 2' PROFILE DATE: 11-10-11

United Engineers, Inc.
 11111 Katy Freeway, Suite 100, Houston, TX 77058
 (713) 961-1111

WARNING! HIGH PROFILE CABLE
 24021-072 Fiber Optic Cable
 24-4201-014 Fiber Buried Cable

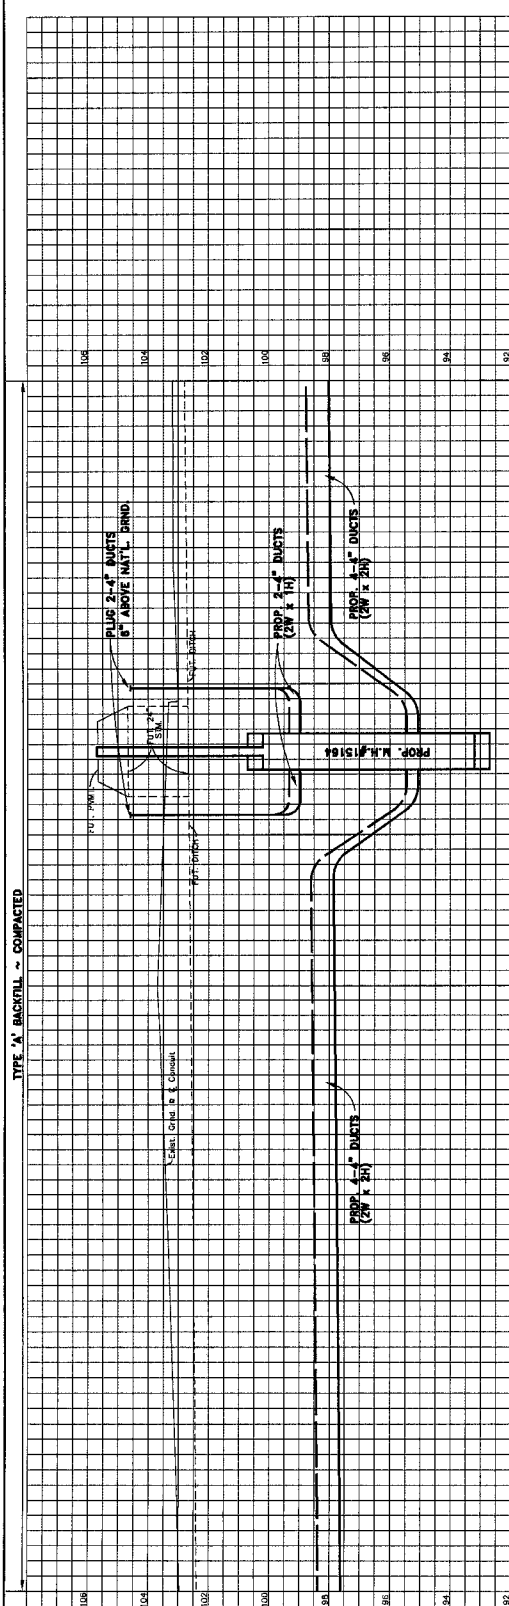

TYPE 'A' BACKFILL ~ COMPACTED

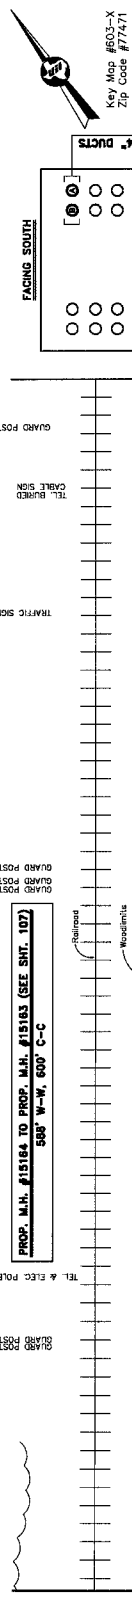

GOVT-BUY AMERICA FHWA PROJECT
 (SEE SHEET 100)

I.H. 69 (SOUTHBOUND FEEDER)

FUT. I.H. 69 (SOUTHBOUND FEEDER)

MATCH LINE STA. 969+42

MATCH LINE STA. 973+42

Key Map #603-X
 Zip Code #77471

NOTE: SEE SHT. 201 FOR SELF INFLECTED CABLE DAMAGE AVOIDANCE NOTE.

ACTION CODE	TASK SUMMARY	ME AMT.	PL	BORE	REMOVALS AMOUNT	WORT DATE
PLAC	MANHOLE	15'	1			
PLAC	TRENCH-2-MPC	15'	50'			
PLAC	PVC-2-8" 2	15'	50'			
PLAC	TRENCH-2-MPC	15'	50'			
PLAC	PVC-2-8" 2	15'	50'			
PLAC	TRENCH-4-MPC	360'				
PLAC	PVC-2-4" 2	3332'				

AT&T Texas/SWB
 I.H. 69 (U.S. 59)
 FORT BEND COUNTY, TEXAS
 CITY OF ROSENBERG
 DEPARTMENT OF PUBLIC WORKS AND ENGINEERING

NOTE: DIMENSIONS VALID FOR ONE YEAR ONLY AFTER DATE OF SIGNATURES

SCALE: PLAN 1" = 20' PROFILE VERT. 1" = 2' PROFILE HORZ. 1" = 20'

PREPARED BY: [Signature]
 DRAWN BY: [Signature]
 CHECKED BY: [Signature]
 PROJECT: 9085473
 SHEET: 217-245-57
 AREA: W-89232 (C.A. HIGH-WAY 232)
 TAX: 90-011

UNITED ENGINEERS, INC.
 1515 E. 15th St., Suite 100
 Houston, Texas 77002
 PHONE: 770-222-1111
 FAX: 770-222-1111



DESCRIPTION	QUANTITY	UNIT	TOTAL
PROP. 4" DUCTS			
PROP. 2" DUCTS			
PROP. 1" DUCTS			
PROP. 15" MANHOLE			
PROP. 15" TRENCH			
PROP. 15" TRENCH			
PROP. 360' TRENCH			
PROP. 3332' TRENCH			

SECTION OF PROP. 4" DUCTS
 SECTION OF PROP. 2" DUCTS
 SECTION OF PROP. 1" DUCTS

SECTION OF PROP. 15" MANHOLE
 SECTION OF PROP. 15" TRENCH



SECTION OF PROP. 360' TRENCH
 SECTION OF PROP. 3332' TRENCH

LONG = W 95° 52' 11"
 LAT. = N 29° 31' 28"
 P = 1.30" F & C
 VOLUME = 304 CU. YD.
 12'-0" x 6'-0" x 7'-0" H.R.
 TYPE 'A' CONC. M.H.
 STA. 972+19.41' LT. L
 PROP. M.H. #15164

ENCLOSURE:
 1. 25' x 35' x 4' Box (Southbound Feeder)
 Located on the inside of I.H. 69 (Southbound Feeder) approximately 151' feet south of the intersection with M.H. #15164.

DATE: 10/20/09

WARNING! HIGH PROFILE CABLE
 544287-072 Rev. 4
 31-4282-074 High Profile Cable

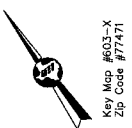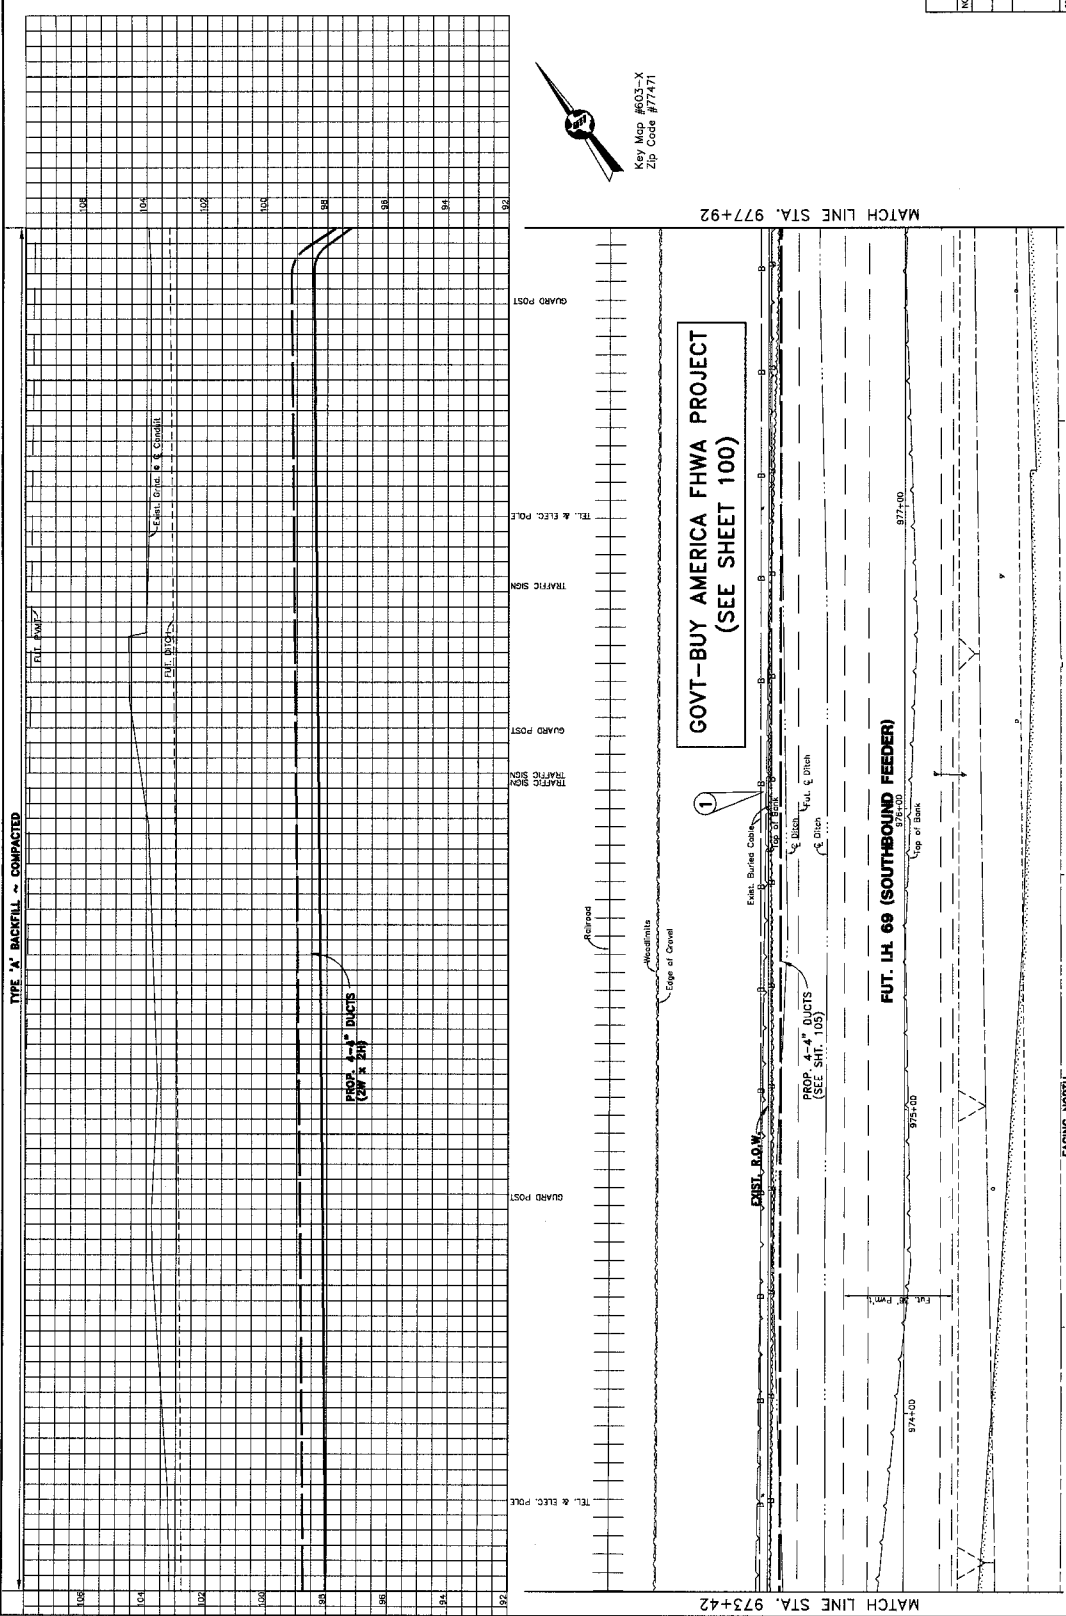

MATCH LINE STA. 973+42

MATCH LINE STA. 977+92

NOTE:
 SEE SHIT. 201 FOR SELF-IMPACTED CABLE
 DAMAGE AVOIDANCE NOTE.


AT&T Texas/SWB
 LH. 69 (U.S. 59)
 FORT BEND COUNTY, TEXAS

CITY OF ROSENBERG
 DEPARTMENT OF PUBLIC WORKS AND ENGINEERING



REVISION	REVISION DATE	DESCRIPTION	INITIAL


SHEET 7 OF 17

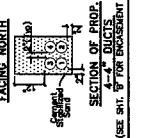

BENCH MARK
 I.B.M. Point #24, 5'0" Iron Rod w/ Cap.
 Located on the northside of LH. 69 (Southbound Feeder).
 Located 712 feet south of the intersection with Miller.
 Elevation=107.12

UNIST Engineering, Inc.
 106
 U.S. # 21-075-00

(1) WARNING! HIGH PROFILE CABLE
 340281-072 Bar is conduit.
 SR-400-014 Fibre build cable.

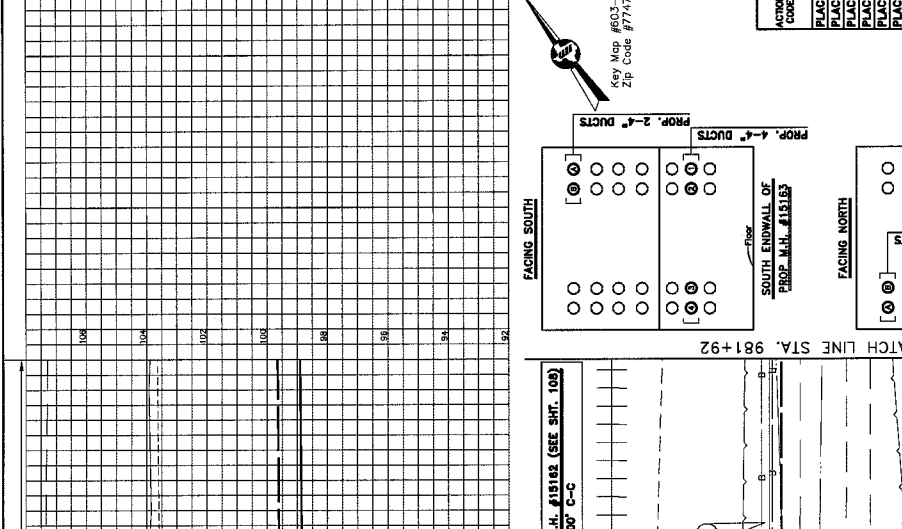


ACTION CODE	TASK SUMMARY	LN OR INT.	PL	BORE	REMOVALS AMOUNT	REMOVALS DATE
PLAC	MANHOLE	15'				
PLAC	TRENCH-2-MFC	15'				
PLAC	PVC-C-3'-2	30'				
PLAC	TRENCH-2-MFC	15'				
PLAC	PVC-C-3'-2	30'				
PLAC	TRENCH-4-MFC	36'			50'	
PLAC	PVC-C-3'-4	2352'				

AT&T Texas/SWB
 NOTE: SCHEDULES VALID FOR ONE YEAR ONLY AFTER DATE OF SIGNATURES
I.H. 69 (U.S. 59)
 FORT BEND COUNTY, TEXAS
 CITY OF ROSENBERG
 DEPARTMENT OF PUBLIC WORKS AND ENGINEERING
 SCALE: PLAN 1"=20' PROFILE VERT. 1"=2' PROFILE HORIZ. 1"=20'
 PREPARED BY:
 CHECKED BY:
 DRAWN BY:
 DATE: 8/15/97
 SHEET NO. 90985473
 PROJECT NO. 90985473
 SHEET 107 OF 107
 UNITED ENGINEERS, INC.
 12170 E. HWY. 281, SUITE 200, DALLAS, TEXAS 75228
 PHONE 972-354-7000 FAX 972-354-7001





REVISION NUMBER	DESCRIPTION

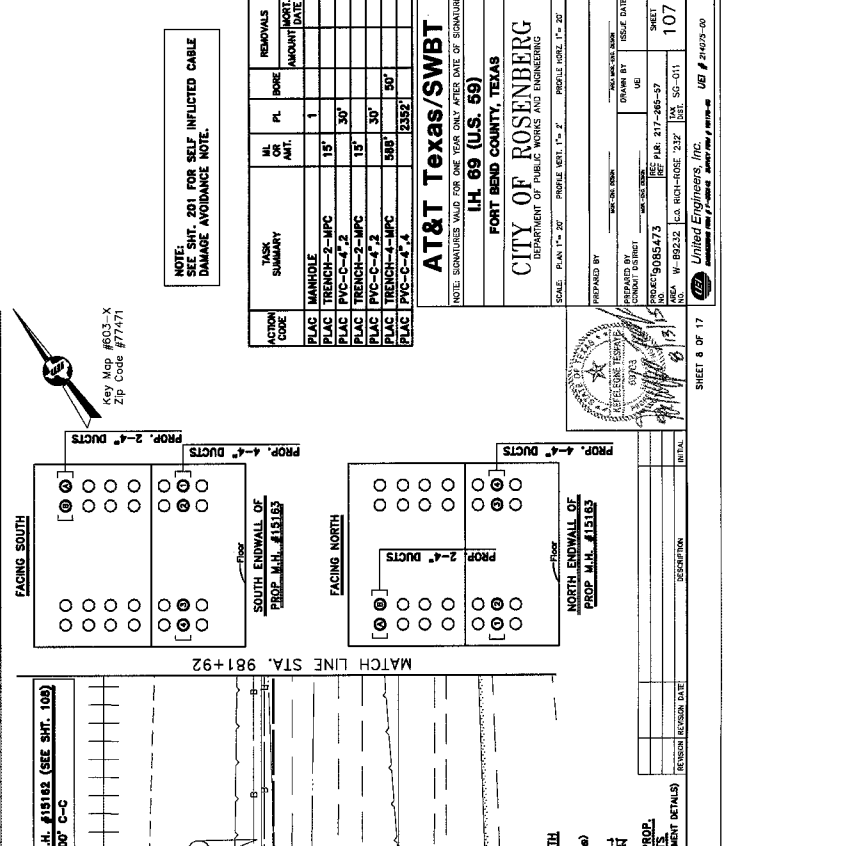



GOVT-BUY AMERICA FHWA PROJECT
(SEE SHEET 100)
 I.H. 69 (SOUTHBOUND MAINLANES)
 MATCH LINE STA. 977+92
 MATCH LINE STA. 981+92
 PROP. 4-4\"/>

SECTION MARK:
 Section on the alignment of I.H. 69, 246 feet south of the intersection with Miller, Interstate Point, 253.5 feet from Red 4/200. I.H. 69 is located on the right side of Miller, 246 feet south of the intersection with Miller, Interstate Point, 253.5 feet from Red 4/200. I.H. 69 is located on the right side of Miller, 246 feet south of the intersection with Miller, Interstate Point, 253.5 feet from Red 4/200.
 LONG I.H. 69 SOUTHBOUND FEEDER
 LONG I.H. 69 SOUTHBOUND MAINLANES
 LONG I.H. 69 SOUTHBOUND SERVICE LANE

WARNING! HIGH PROFILE CABLE
 SH-400-C7A Flow buried cable

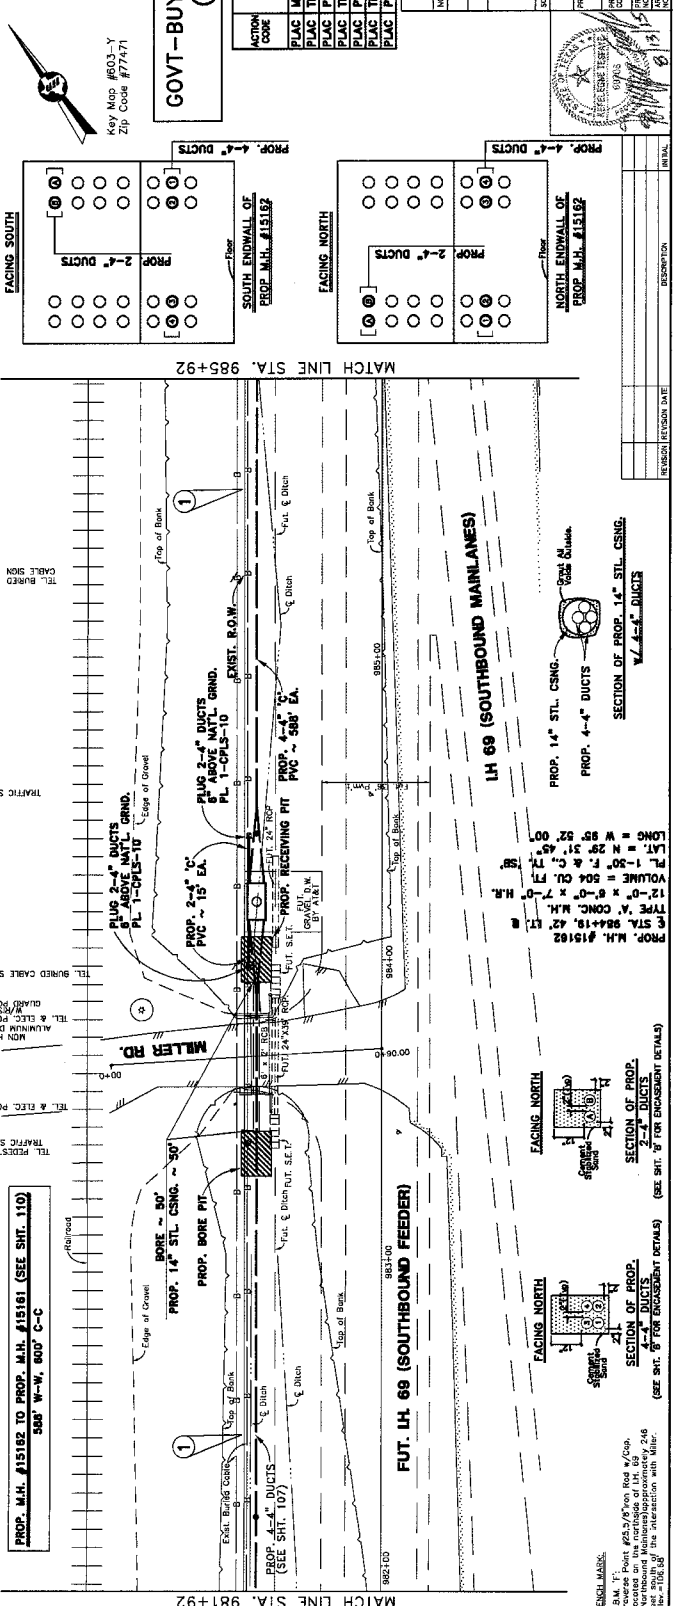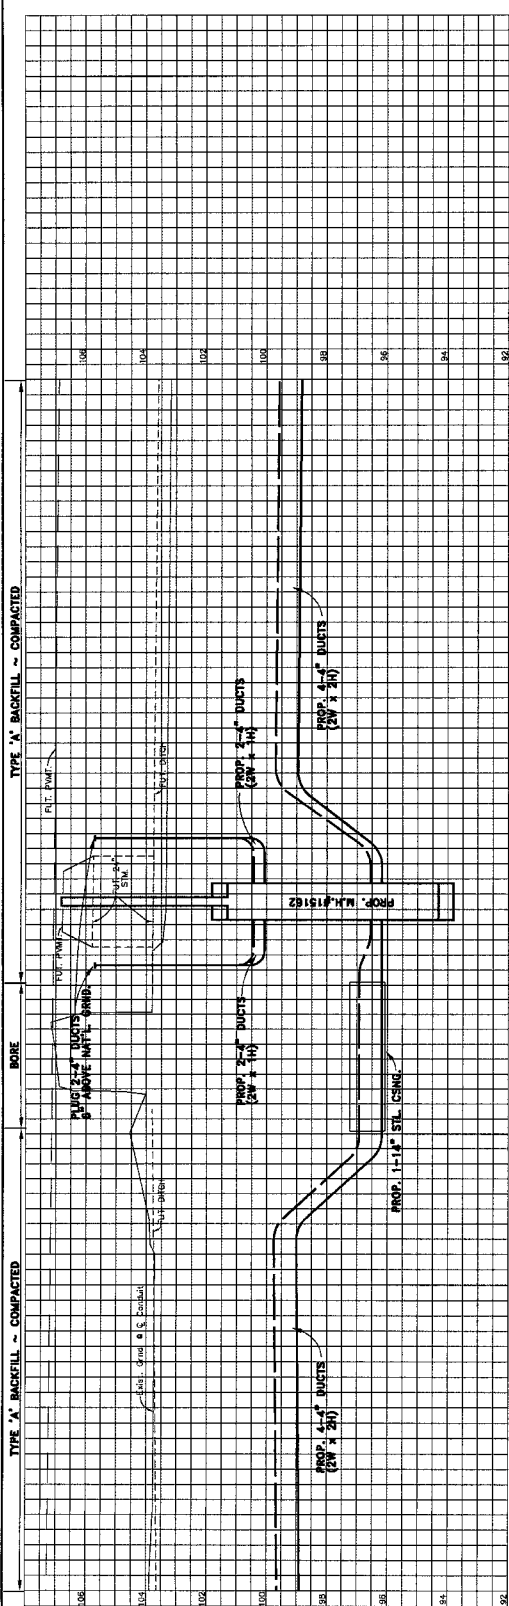

PROP. M.H. #15162 TO PROP. M.H. #15161 (SEE SHIT. 110)
 500' W-W, 600' C-C

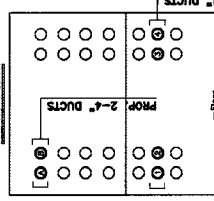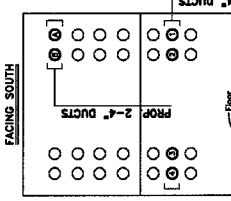

NOTE:
 SEE SHEET 261 FOR SELF INFLATED CABLE
 DAMAGE AVOIDANCE NOTE.

GOVT-BUY AMERICA FHWA PROJECT
 (SEE SHEET 100)

ACTION CODE	TASK SUMMARY	M. OR A.M.	PL	BORE	REMOVALS AMOUNT	WORK DATE
PLAC	MANHOLE	15'				
PLAC	TRENCH-2-MFC	15'				
PLAC	PVC-C-4'-2	15'	30'			
PLAC	TRENCH-2-MFC	15'				
PLAC	PVC-C-4'-2	15'	30'			
PLAC	TRENCH-4-MFC	55B'				
PLAC	PVC-C-4'-4	235Z'				

AT&T Texas/SWB

1H, 69 AND MILLER ROAD
 FORT BEND COUNTY, TEXAS
 CITY OF ROSENBERG
 DEPARTMENT OF PUBLIC WORKS AND ENGINEERING

NOTE: SIGNATURES VALID FOR ONE YEAR ONLY AFTER DATE OF SIGNATURES

SCALE: PLAN 1" = 20' PROFILE VERT. 1" = 20'

PREPARED BY: [Signature]

DESIGNED BY: [Signature]

CHECKED BY: [Signature]

DATE: 9/08/05

PROJECT NO: 0000000000

ISSUE NO: 108

ISSUE DATE: 08/11/05

DRWN BY: [Signature]

DATE: 08/11/05

PROJECT NO: 0000000000

ISSUE NO: 108

ISSUE DATE: 08/11/05



SHEET 9 OF 17

UB # 21025-00

SECTION OF PROP. 14" STL. CSNG.
 V.L. 4'-4" DUCTS

SECTION OF PROP. 4-4" DUCTS

SECTION OF PROP. 2-4" DUCTS

(SEE SHIT. 97 FOR ENCASUREMENT DETAILS)

SECTION OF PROP. 2-4" DUCTS

(SEE SHIT. 97 FOR ENCASUREMENT DETAILS)

SECTION OF PROP. 14" STL. CSNG.
 V.L. 4'-4" DUCTS

SECTION OF PROP. 14" STL. CSNG.
 V.L. 4'-4" DUCTS

SECTION OF PROP. 14" STL. CSNG.
 V.L. 4'-4" DUCTS


SECTION OF PROP. 14" STL. CSNG.
 V.L. 4'-4" DUCTS

SECTION OF PROP. 14" STL. CSNG.
 V.L. 4'-4" DUCTS

WARNING! HIGH PROFILE CABLE
 2402BT-072 Fibre in conduit.
 SR-420-014 Fibre buried cable



Key Map #603-Y
 Zip Code #77471

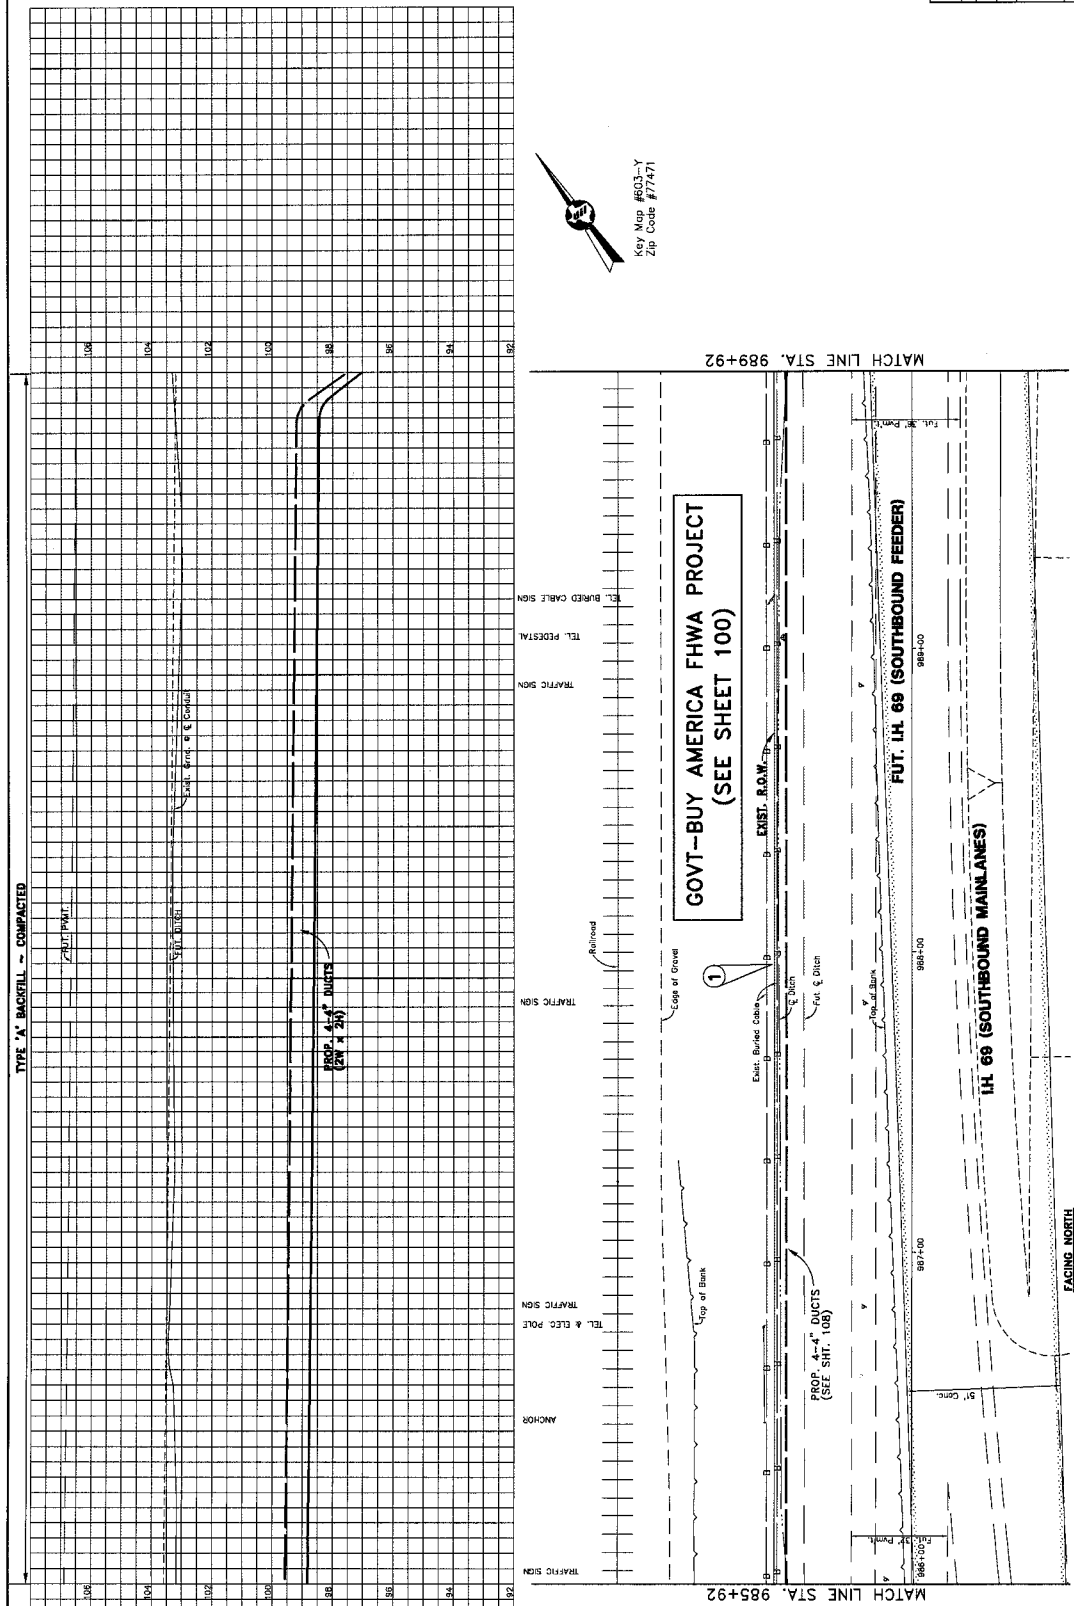

NOTE:
 SEE SHT. 001 FOR SELF IMPLICATED CABLE
 DAMAGE AVOIDANCE NOTE.

AT&T Texas/SWBT
 I.H. 69 (U.S. 59)
 FORT BEND COUNTY, TEXAS

CITY OF ROSENBERG
 DEPARTMENT OF PUBLIC WORKS AND ENGINEERING

SCALE: PLAN 1" = 20' PROFILE 1" = 2' PROFILE HORIZ. 1" = 20'


PREPARED BY: [Signature]
 CHECKED BY: [Signature]
 NO. 9085473
 DATE 11/11/99
 PROJECT NO. W-89232 (S. RICH-HOSE '93)
 SHEET NO. 109

ISSUE DATE: 11/11/99
 DRAWN UP: [Signature]
 CADD: [Signature]

UNITED ENGINEERS, INC.
 1000 WEST 17TH STREET, SUITE 100
 FORT WORTH, TEXAS 76102-3809
 PHONE: 817-342-2000
 FAX: 817-342-2001





REVISION	REVISION DATE	DESCRIPTION	INITIALS

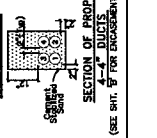

BENCHMARK:
 T.B.M. '01:
 Truss Point #26, 5/8" Iron Rod w/Con.
 (Southward Meridian) approximately 250
 ELEV. 4105.33
 (SEE SHT. 01 FOR ENCLOSURE DETAILS)

WARNING HIGH PROFILE CABLE
 342825-02 Fiber in conduit
 34-000-001 Fiber bonded cable

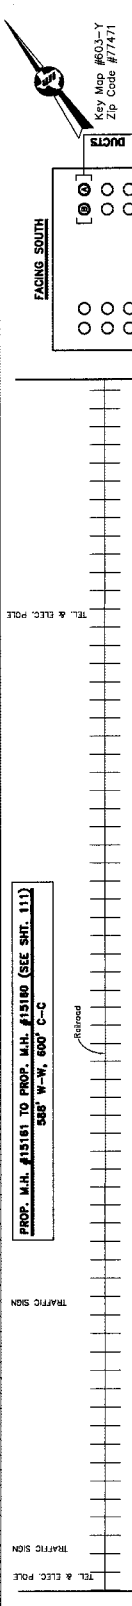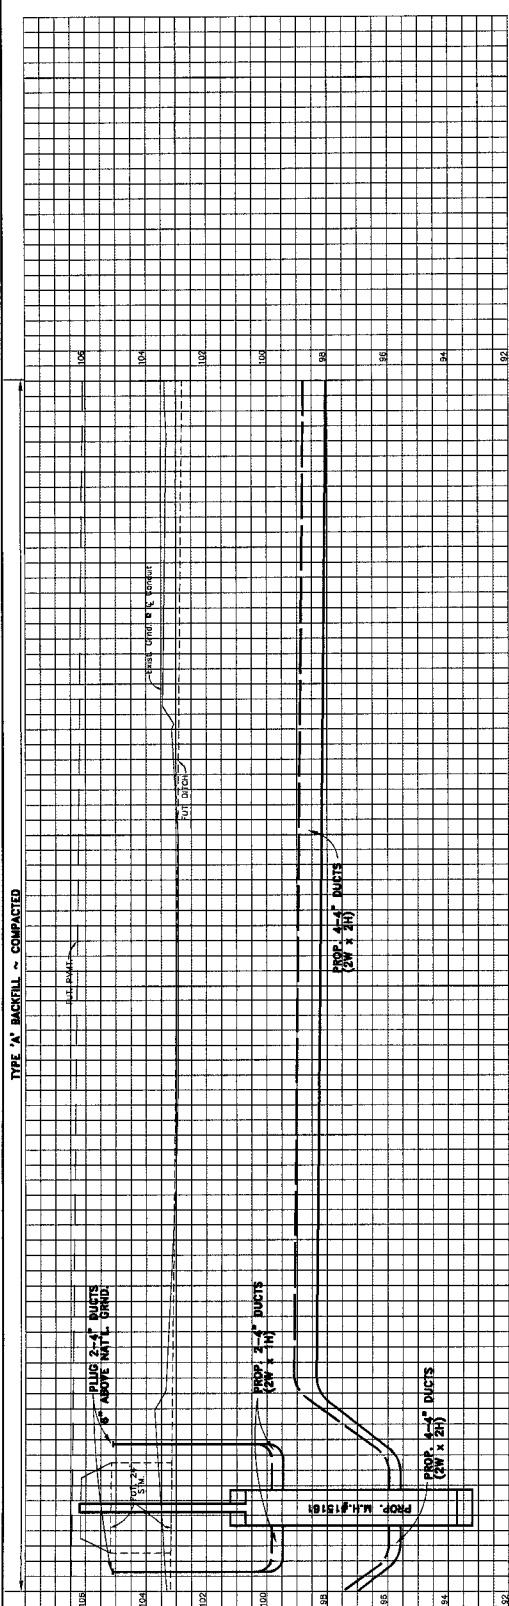

GOVT-BUY AMERICA FHWA PROJECT
 (SEE SHEET 100)

PROP. M.H. #15161 TO PROP. M.H. #15160 (SEE SHT. 111)
 508' W-W, 600' C-C

PROP. 4-4\"/>

PROP. 4-4\"/>

PROP. 4-4\"/>

NOTE:
 SEE SHT. 201 FOR SELF INFLICTED CABLE
 DAMAGE AVOIDANCE NOTE.

ACTION CODE	TASK SUMMARY	NO. AMT.	PL	BORE	REMOVALS	WARRANTY	DATE
PLAC	MANHOLE	15'	30'				
PLAC	TRENCH-2-MPC	15'	30'				
PLAC	PVC-C-2-2	15'	30'				
PLAC	TRENCH-2-MPC	15'	30'				
PLAC	PVC-C-2-2	15'	30'				
PLAC	TRENCH-4-MPC	568'					
PLAC	PVC-C-4-4	568'					

AT&T Texas/SWBT
 IH 69 (U.S. 59)
 FORT BEND COUNTY, TEXAS
 CITY OF ROSENBERG
 DEPARTMENT OF PUBLIC WORKS AND ENGINEERING

NOTE: SIGNATURES VALID FOR ONE YEAR ONLY AFTER DATE OF SIGNATURES

SCALE: PLAN 1"=50' PROFILE 1"=10'

PREPARED BY: [Signature]

DESIGNED BY: [Signature]

CHECKED BY: [Signature]

DATE: 11/10/01

PROJECT NO: W-89232 (C.C. R.O. ROSE '93')


DATE: 05-01

SHEET: 110

UNITED ENGINEERS, INC.



REVISION	REVISION DATE	DESCRIPTION

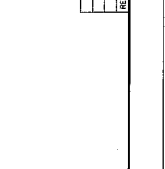


SECTION OF PROP. 2-2\"/>

SECTION OF PROP. 4-4\"/>

SECTION OF PROP. 4-4\"/>

PROP. M.H. #15161
 TYPE 'A' CONC. M.H.
 STA. 990+19.42'
 LONG = W 92' 51.54"
 LAT. = N 29' 31' 47.5"
 PL. 1-30' F & C, U. 7.5'
 VOLUME = 504 CU. FT.
 TYPE 'A' CONC. M.H. 12'-0" x 6'-0" x 7'-0"
 @ STA. 990+19.42'
 BENCH MARK:
 I.B.M. 'N'
 (Ironing Post #27, 5/8" Iron Ring #/Conc. (Southbound Mainlanes) approximately 840
 Elevation of the intersection with M.H. 824-104.8)

TYPE 'A' BACKFILL - COMPACTED

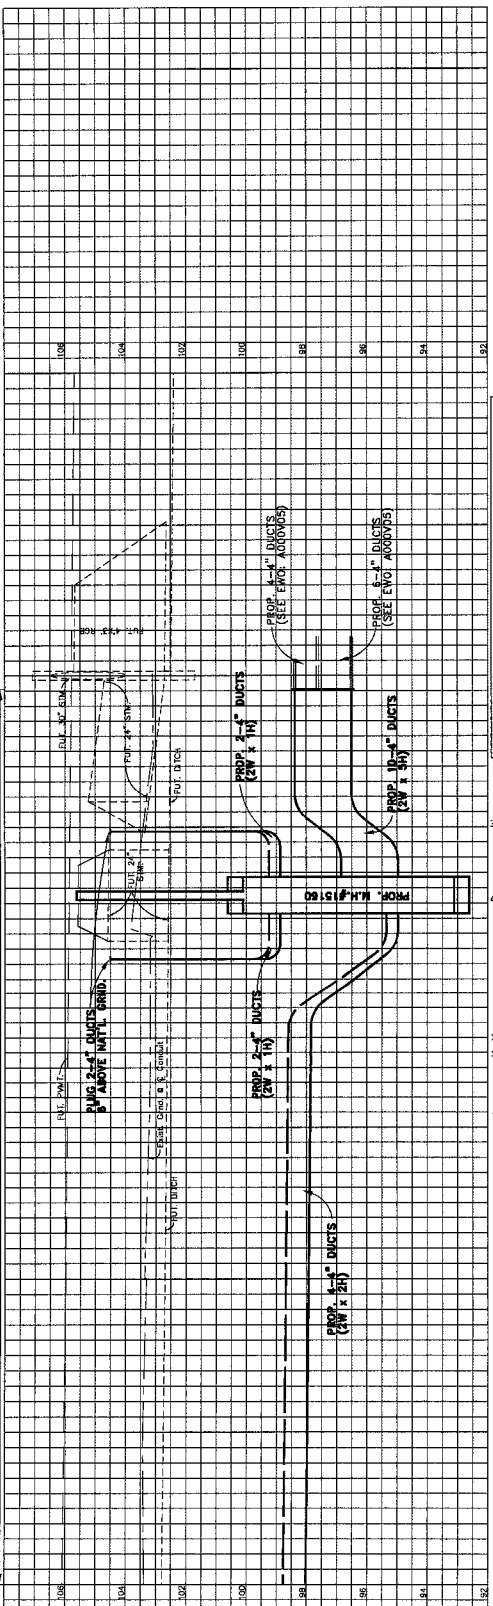

11 WARNING! HIGH PROFILE CABLE
340201-022, Phase II conduit
34-400-014, Fiber buried cable



12 WARNING! HIGH PROFILE CABLE
302021-049, Phase II conduit

PROP. M.H. #15180 TO PROP. M.H. #15171 (ENCL. ADD00V05)
552' W-W, 544' C-C

PROP. M.H. #15160 TO PROP. M.H. #15170 (ENCL. ADD00V05)
585' W-W, 600' C-C

GOVT-BUY AMERICA FHWA PROJECT
(SEE SHEET 100)

LH. 69 (SOUTHBOUND MAINLANES)

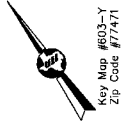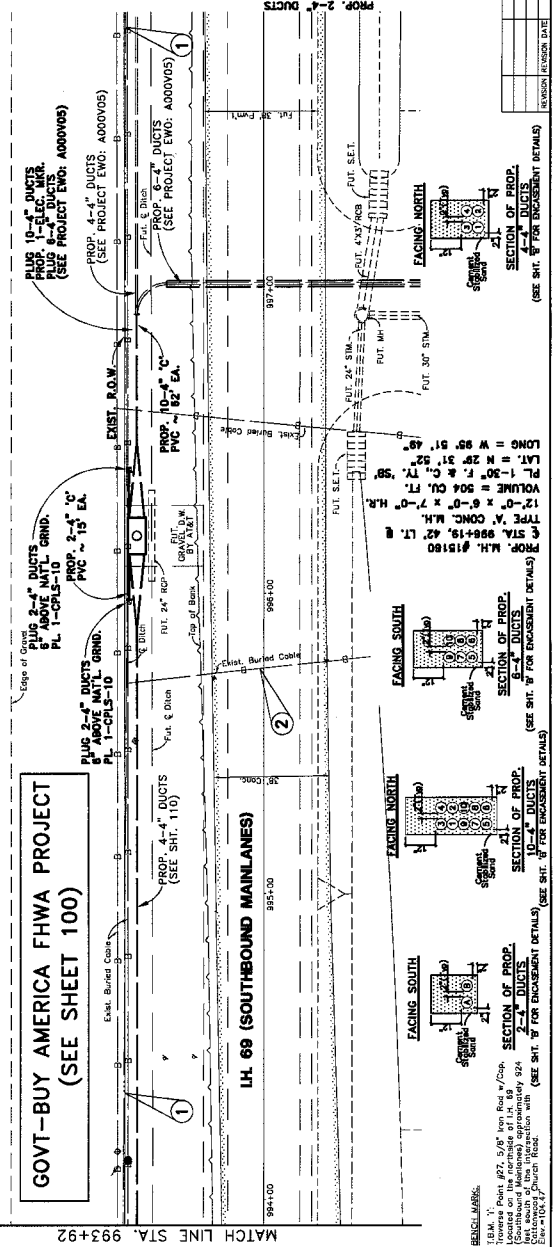

NOTE:
SEE SHT. 201 FOR SELF INFLATED CABLE
DAMAGE AVOIDANCE NOTE.

ACTION CODE	TASK SUMMARY	ML AUT.	PL	BORE	REMOVALS	AMOUNT	DATE
PLAC	MANHOLE	15'	1				
PLAC	TRENCH-2-MPC	15'	30'				
PLAC	PVC-C-4'-2	15'	30'				
PLAC	TRENCH-2-MPC	15'	30'				
PLAC	PVC-C-4'-2	15'	30'				
PLAC	TRENCH-10-MPC	62'					
PLAC	PVC-C-4'-10	62'					


AT&T Texas/SWB

NOTE: DIMENSIONS VALID FOR ONE YEAR ONLY AFTER DATE OF SUBMITTAL
LH. 69 AND LEON ROAD
FORT BEND COUNTY, TEXAS
CITY OF ROSENBERG
DEPARTMENT OF PUBLIC WORKS AND ENGINEERING


DESIGNED BY: [Signature] DATE: [Date]
CHECKED BY: [Signature] DATE: [Date]
DRAWN BY: [Signature] DATE: [Date]
PROJECT NO: 9085473
SHEET NO: 217-285-37
SHEET TOTAL: 111
DATE: 11/11/11
SCALE: PLAN 1" = 30' PROFILE VERT. 1" = 2'



- NOTES:
- 1.) REINFORCING ROD SPACING MAY BE CHANGED TO ACCOMMODATE THE PLACEMENT OF CONCRETE INSERTS, Sumps, PULLING IRONS, CABLES SLEEVES AND OTHER DEVICES. ALL CHANGES SHALL BE INDICATED ON THE DRAWING.
 - 2.) REINFORCING ROD SPACING SHALL BE ADJUSTED TO MAINTAIN A MINIMUM OF 1 INCH CLEARANCE FROM THE INSIDE SURFACE OF THE ROOFS.
 - 3.) YIELD STRENGTH FOR CONCRETE AND STEEL: 4,000 PSI FOR CONCRETE AND 60,000 PSI FOR STEEL.
 - 4.) ALL REINFORCING RODS SHALL BE #5 UNLESS OTHERWISE NOTED.
 - 5.) DIAGONAL STEEL SHALL BE NUMBER 5 ROD.
 - 6.) THE REINFORCING RODS SHALL BE PLACED ON THE SURFACE OF THE SLAB 1 INCH MINIMUM FROM THE INSIDE SURFACE OF THE ROOFS.
 - 7.) ALL REINFORCING RODS SHALL BE #5 UNLESS OTHERWISE NOTED.
 - 8.) FOR CONSTRUCTION REQUIREMENTS, USE BELL AND HOWELL CONCRETE MIXTURE DESIGN PROCEDURE REFER TO SECTION 622-020-020.

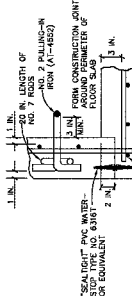


FLOOR-WALL SECTION
 REINFORCEMENT
 (NOTE: WATERSTOP REQUIRED AT ALL CONSTRUCTION JOINTS.)

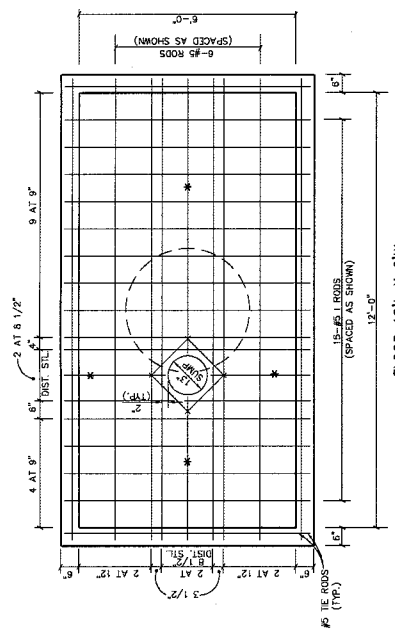


ROOF 12'L x 6'W
 (SLAB THICKNESS=7)

NOTE: ALL DIAGONAL BARS ARE #5 ROOFS SPACED 3" C-C (TYP.)

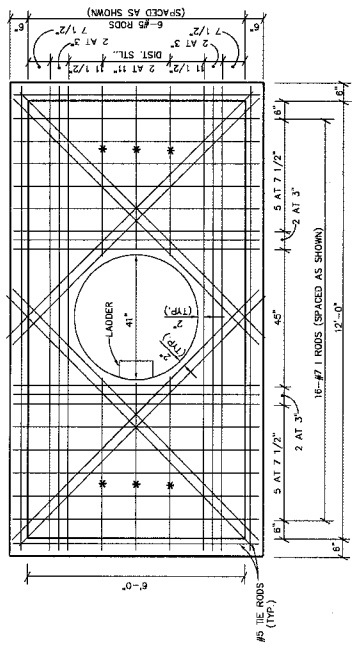


ROOF 12'L x 6'W
 (SLAB THICKNESS=7)

NOTE: ALL DIAGONAL BARS ARE #5 ROOFS SPACED 3" C-C (TYP.)

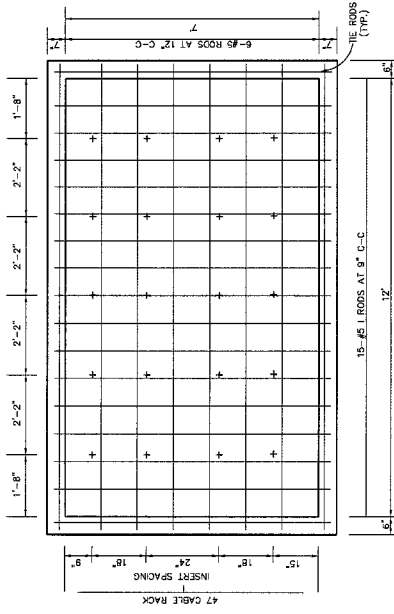

SIDEWALL 12'L x 7'HR
 (SLAB THICKNESS=6)

NOTE: ALL DIAGONAL BARS ARE #5 ROOFS SPACED 3" C-C (TYP.)

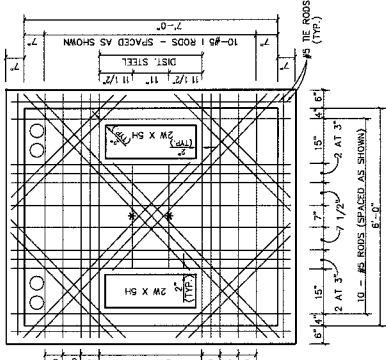


ENDWALL 6'W x 7'HR
 (SLAB THICKNESS=6)

NOTE: ALL DIAGONAL BARS ARE #5 ROOFS SPACED 3" C-C (TYP.)

UP TO 5' OF COVER
AT&T Texas/SWB
 NOTE: SIGNATURE VALID FOR ONE YEAR ONLY. FEELE DATE OF SIGNATURE
MANHOLE #15167
 12'-0" x 6'-0" x 7'-0"

CITY OF ROSENBERG
 DEPARTMENT OF PUBLIC WORKS AND ENGINEERING
 SCALE: PLAN 1/2" = 1'

PREPARED BY	DATE	ISSUE DATE
DRAWN BY	DATE	DATE
CHECKED BY	DATE	DATE
PROJECT NO.	9085473	SHEET NO.
NO.	112	DATE
AREA	W-89232	CONTRACT NO.
UNIT	CONCRETE	UNIT PRICE
UNIT	CONCRETE	UNIT PRICE
UNIT	CONCRETE	UNIT PRICE

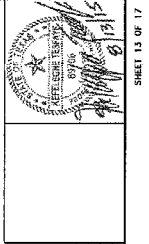

REVISION	REVISION DATE	DESCRIPTION	INITIALS

GENERAL CONSTRUCTION NOTES

- If existing buried cable is exposed during trenching operations, coordinate temporary support and coordinate trenching in the same trench or conduit.
- Coordinate temporary support and protection of underground conduit with construction and maintenance forces.
- Coordinate temporary support and/or final racking of cables in proposed rebar manholes with maintenance forces.
- Stop existing cables in existing manhole(s) at the beginning and end of each work day. If an air leak is detected, notify telephone Company personnel immediately.
- Coordinate with the City of Houston for all necessary permits, including but not limited to, and governmental entities.
- Plug all ducts in all manholes - see BSR 628-220-801 for material and installation specifications.
7. 1/2" PVC ducts are to be measured in accordance with BSR 622-340-201.
8. All excavation work shall be done in accordance with the contract documents and shall be independently verified by the owner or its representative. The contractor shall determine the exact location of all existing utilities before commencing work, and agrees to be fully responsible for any damage to existing utilities. The contractor shall call the One Call at 1-800-545-6005 and provide a copy of the One Call notification to the City of Houston at 713-223-4567 or 1-800-669-8344 48 hours prior to construction.
9. The information shown on this drawing concerning type and location of underground utilities is not to be construed as a warranty of accuracy. The contractor shall verify the location of all underground utilities and shall be responsible for any damage to existing utilities or other underground pipelines, conduits and manholes. The contractor shall verify the location of underground utilities or by excavation in advance of construction by contacting owners of underground utilities or by excavation in advance of construction.
10. Contractor shall notify Texas Excavation Safety System (TESS), 48 hours prior to working in or around existing underground utilities.
11. Contractor must comply with OSHA Specifications and Ball System Practices (622-020-801, Sec. 11 & 12) on trenching, back filling, excavation and shoring requirements.
12. Contractor shall provide certification statement to SSC Contract Engineer that existing utilities have been located and marked in accordance with the contract documents.
13. The Construction Contractor shall also be solely responsible for the means, methods, sequence, or about the job, in accordance with any health or safety precautions, regulations, standards or contract documents. The Construction Contractor shall also be solely responsible for safety in or around the job.
14. Contractor will be responsible for replacing and maintaining traffic signs and pavement markings when excavating, trenching, back filling, excavation and shoring operations are completed.
15. When excavating, trenching, back filling, excavation and shoring operations are completed, the Contractor shall be responsible for the replacement of CenterPoint Energy Electric, CenterPoint Energy Gas or other utilities facilities and for any cost incurred for this work.
16. Contractor to contact owner(s) of all poles/series facilities within project area prior to construction to coordinate any necessary permits and/or clearances.
17. When site existing utility and/or covers for unobstructed drainage at all lines and shall provide information to the City of Houston regarding the location of all existing utilities and shall provide information to the City of Houston regarding the location of all existing utilities and shall provide information to the City of Houston regarding the location of all existing utilities.
18. If it becomes necessary to operate machinery on a portion of the pavement, precautions must be taken to prevent any damage whatsoever to the pavement.
19. When excavating, trenching, back filling, excavation and shoring operations are completed, the Contractor shall be responsible for the replacement of CenterPoint Energy Electric, CenterPoint Energy Gas or other utilities facilities and for any cost incurred for this work.
20. No more trench opened at one time than can be backfilled and compacted in 6" lifts of the end of each excavation.
21. Tunnel and/or hand dig all concrete curbs.
22. Contractor to provide a minimum of 6" of clearance at all crossings of sanitary sewers, storm sewers, and/or other utilities.
23. Changes less than 1" vertically and 3" horizontally due to field conditions do not constitute a change in the scope of work. Contractor shall obtain approval from SSC Inspector prior to any change in the scope of work.
24. Contractor shall submit a set of marked up plans to the SSC Manager of Engineering Design.
25. Contractor shall commence work only after permits are obtained and copies are kept on site.
26. Contractor shall have sufficient equipment and manpower on the job site to complete the work on or before the completion date.
27. Contractor shall be responsible for determining actual bore pit locations and dimensions. Bore pit locations and dimensions shown on plans are the engineers opinion.
28. Contractor shall construct horizontal directional drill in accordance with ASTM F 1952, "Standard Practice for Directional Drilling for Placement of Polyethylene Pipe or Conduit Under Obstacles Including River Crossings". Drilling for Placement of Polyethylene Pipe or Conduit Under Obstacles Including River Crossings".
29. Contractor shall be responsible for determining actual bore pit locations and dimensions. Bore pit locations and dimensions shown on plans are the engineers opinion.
30. The latitude and longitude points recorded in these drawings were obtained using rapid static GPS techniques post-processed to obtain a positional accuracy of one (1) meter.

CAUTION: CATV Buried cable in construction area. Contractor to be responsible for any damage whatsoever.

CAUTION: Existing underground street light cable in construction area. Verify exact location & dig and/or boring.

CAUTION: Existing SBC facilities in construction area. Verify exact location & depth prior to any digging and/or boring.

CAUTION: Existing CenterPoint Energy Electric facilities in construction area, contact CenterPoint Energy Electric 48 hours prior to any digging and/or boring.

CAUTION: Existing CenterPoint Energy Gas facilities in construction area, contact CenterPoint Energy Gas 48 hours prior to any digging and/or boring.

CAUTION: Underground Gas Facilities.





Locations of CenterPoint Energy Gas main lines (to include Unit Gas Transmission and/or Industrial Gas Supply Corporation) were approximately as shown in an approximate location only. Service lines are not shown. For more information, contact CenterPoint Energy Gas at (713)223-4567 or 1-(800)-669-8344 a minimum of 48 hours prior to construction to have main and service lines field located.

4. 30 min. CenterPoint Energy Gas pipe line markings are not visible call (713)967-8037 (7:00 am. to 5:00 pm. Central Time) to have markings made.

* When excavation within eighteen (18') of the indicated location of CenterPoint Energy Gas facilities, all excavation must be accomplished using non-mechanized excavation procedures. Facilities to be excavated shall be marked with reflective paint, sufficient support must be provided to the contractor is fully responsible for any damages caused by his failure to exactly locate and preserve these underground facilities.


SWBT GENERAL BACKFILL & ENCASMENT SPECIFICATIONS

- TYPE 'C' BACKFILL - CEMENT STABILIZED SAND (2 SACKS PER TON OR TO MEET LATEST CITY OF HOUSTON SPECIFICATIONS).
- TYPE 'A' BACKFILL - ORIGINAL MATERIAL, FREE OF DEBRIS MATERIAL, COMPACTED TO 95% PROCTOR IN 6" LIFTS.
- CONDUIT FORMATIONS, REGARDLESS OF NUMBER OF DUCTS, SHALL MAINTAIN THE SAME MINIMUM FORMATIONS THROUGHOUT THE ENTIRE LENGTH OF THE CONDUIT.
- FORMATIONS THROUGHOUT THE ENTIRE LENGTH OF THE CONDUIT SHALL BE MAINTAINED AT ALL TIMES THROUGHOUT THE ENTIRE LENGTH OF THE CONDUIT.
- ALL DUCTS TO BE ENCASED WITH CEMENT STABILIZED SAND UNLESS OTHERWISE SPECIFIED OR REQUIRED.
- CONCRETE ENCASE DUCTS WITHIN AREAS OF GRADE CHANGES MORE THAN 20% (1" IN 5') AND BRIDGE HAVERS WITH A RADIUS OF LESS THAN 80 FEET.

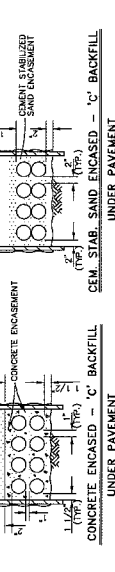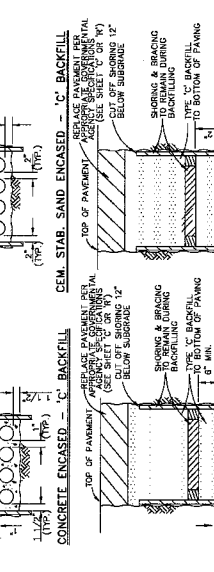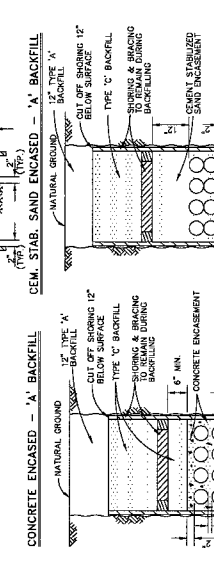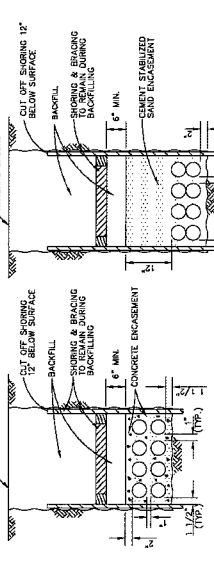





TYPE OF CONCRETE	COMPRESSIVE STRENGTH (PSI)	MAX. SIZE OF AGGREGATE (IN.)	SUMP (IN.)	TYPE OF CEMENT (SEE INSTRUCTIONS)
Masses and other form work, Machine Vibration	4000	3/4	3	I or II
Concrete	2500	1/4 to 3/8	3	I or II
Concrete for manhole encasement (for manhole base)	2500	3/4	3	I or II
Concrete for manhole encasement (for manhole walls)	2500	3/4 to 1-1/2	3	I or II

Notes: For construction requirements and for quantities of cement and aggregate, see the City of Houston Specification 622-020-801.

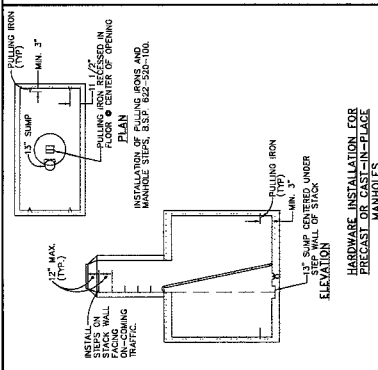

TYPICAL STEEL CASING SECTION

SIZE (IN.)	THICKNESS (IN.)
14 TO 16	0.218
18	0.231
20	0.244
22	0.257
24	0.270
26	0.283
28 TO 30	0.296
32	0.309
34 TO 36	0.322
38 TO 42	0.335

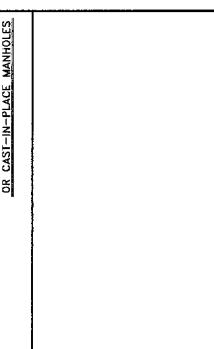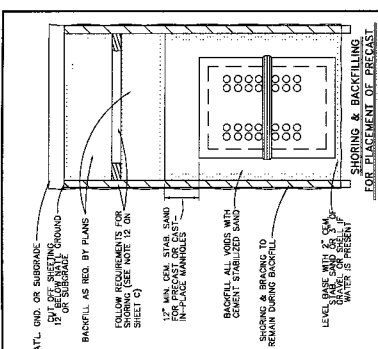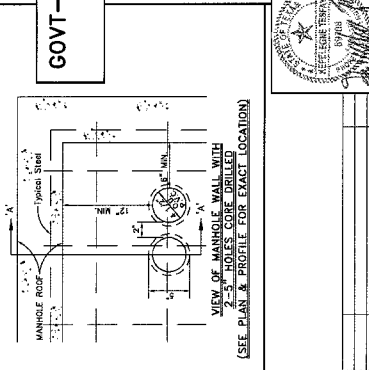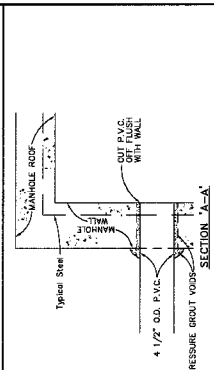

GOVT-BUY AMERICA FHWA PROJECT (SEE SHEET 100)

AT&T Texas/SWBT

NOTE: SIGNATURES VALID FOR ONE YEAR ONLY AFTER DATE OF SIGNATURES

GENERAL DETAILS & SPECIFICATIONS

CITY OF ROSENBERG
DEPARTMENT OF PUBLIC WORKS AND ENGINEERING

SCALE: PLAN 1" = 20' PROFILE 1/8" = 1" 20'

PREPARED BY: [Signature]

DESIGNED BY: [Signature]

CHECKED BY: [Signature]

DATE: 08/05/23

PROJECT NO.: 17-00000000

ISSUE DATE: 2/01

US # 214075-00

REVISION NUMBER DATE DESCRIPTION INITIAL

1 8/13

2 8/13

3 8/13

4 8/13

5 8/13

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UNITED ENGINEERS INC.

10000 Katy Freeway, Suite 1000, Houston, TX 77025

PH: 281-462-1000 FAX: 281-462-1001

WWW: www.uei.com

PROJECT NO.: 17-00000000

DATE: 08/05/23

ISSUE DATE: 2/01

US # 214075-00

REVISION NUMBER DATE DESCRIPTION INITIAL

1 8/13

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4 8/13

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6 8/13

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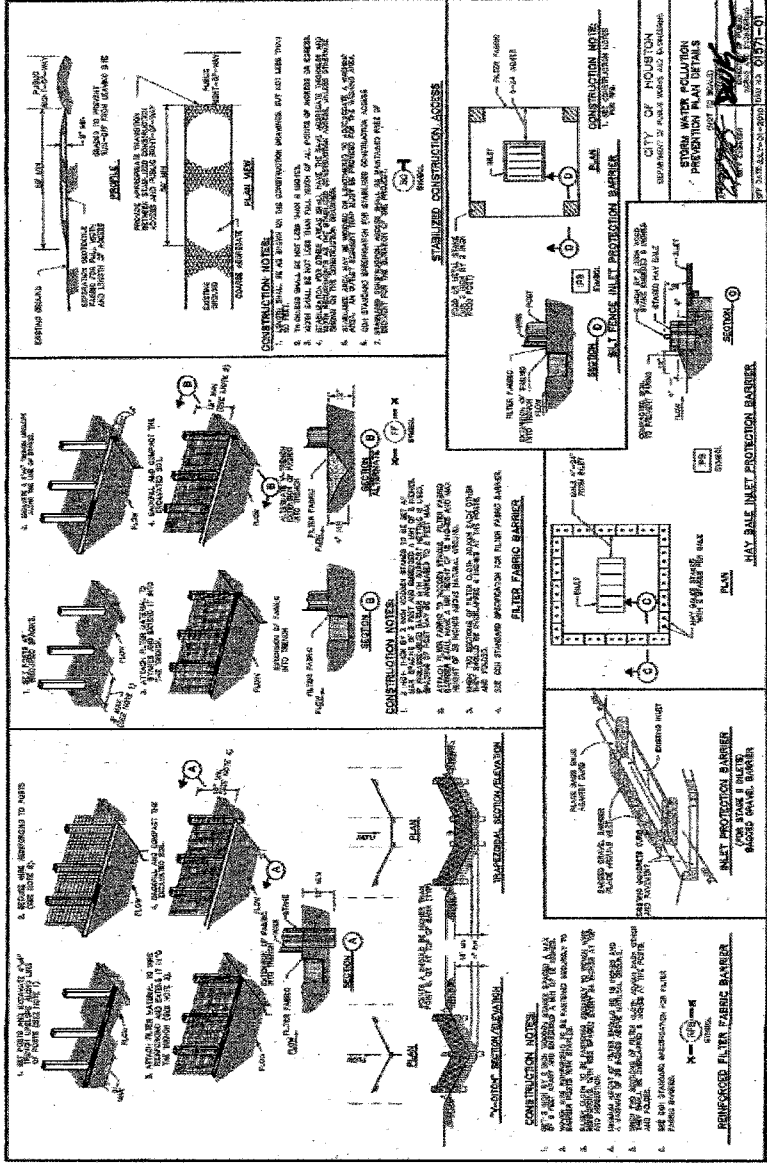
100 8/13

GENERAL CONSTRUCTION NOTES FOR STORM WATER POLLUTION PREVENTION PLAN Management Plan (SWPP) and Storm Water Utility

1. No site disturbance (clearing and grubbing) until after issuance of permit.
2. Provide Best Management Practices (BMPs) to prevent any runoff into stormwater drainage system.
3. Provide Storm Water Pollution Prevention Plan (SWPPP) forms for all construction activities.
4. Any construction that occurs on the site is a violation of the City of Houston Code of Ordinances.
5. Storm Water Pollution Prevention Plan (SWPPP) must be approved by the City of Houston.
6. Storm Water Pollution Prevention Plan (SWPPP) must be approved by the City of Houston.
7. Storm Water Pollution Prevention Plan (SWPPP) must be approved by the City of Houston.
8. Storm Water Pollution Prevention Plan (SWPPP) must be approved by the City of Houston.
9. Storm Water Pollution Prevention Plan (SWPPP) must be approved by the City of Houston.
10. Storm Water Pollution Prevention Plan (SWPPP) must be approved by the City of Houston.

CONSTRUCTION NOTES FOR CONSTRUCTION DRAINAGE

1. Contractor shall install inlet protection devices and Reinforced Filter Fabric (RFF) on all construction sites.
2. During the construction phase of the project, Contractor shall maintain the site to prevent erosion and sedimentation.
3. Contractor shall install inlet protection devices and RFF on all construction sites.
4. Contractor shall install inlet protection devices and RFF on all construction sites.
5. Contractor shall install inlet protection devices and RFF on all construction sites.
6. Contractor shall install inlet protection devices and RFF on all construction sites.
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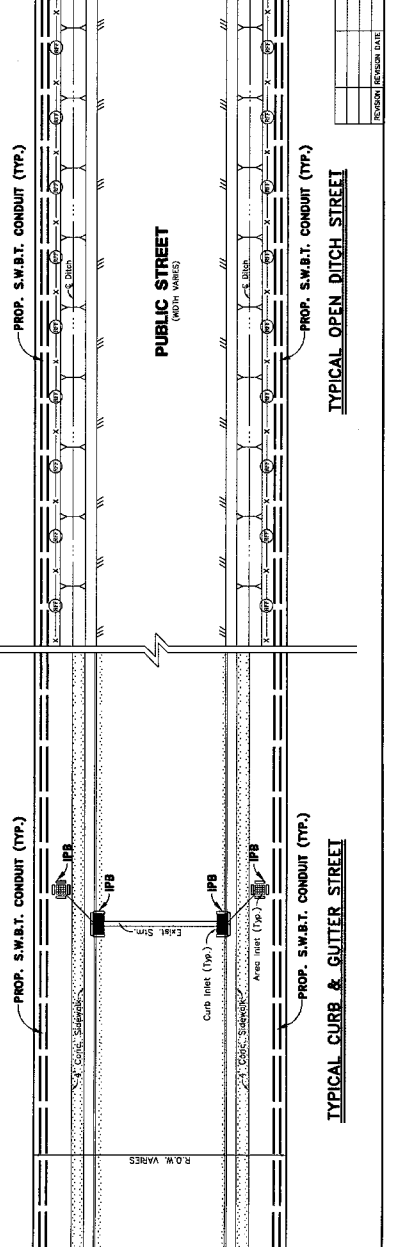


CONTRACTOR TO KEEP THIS SHEET AT JOB SITE AND POST SIGNED TCEO CONSTRUCTION SITE NOTICE IN COMPLIANCE WITH TCEO GENERAL PERMIT.


**AT&T Texas/SWBT
TYPICAL SWPPP PLAN
ROSENBERG, TEXAS**

NOTE: SIGNATURES VALID FOR ONE YEAR ONLY AFTER DATE OF SIGNATURES
CITY OF HOUSTON
 DEPARTMENT OF PUBLIC WORKS AND ENGINEERING
 PREVENTION PLAN DETAILS
 PREPARED BY: [Signature]
 CHECKED BY: [Signature]
 DATE: [Date]
 SCALE: PLAN 1" = 20' PROFILE 1" = 2'

PROJECT NO.	190609827
DATE	08/11/2010
ISSUE DATE	08/11/2010
ISSUE NO.	203
PROJECT NAME	AT&T TEXAS/SWBT
PROJECT LOCATION	ROSENBERG, TEXAS
PROJECT DESCRIPTION	STORM WATER POLLUTION PREVENTION PLAN DETAILS
PROJECT OWNER	AT&T TEXAS/SWBT
PROJECT ADDRESS	190609827
PROJECT PHONE	281-437-1000
PROJECT FAX	281-437-1000
PROJECT EMAIL	atandtexas@att.com
PROJECT WEBSITE	www.att.com



DISCLAIMER: The use of this standard to other projects or for purposes not intended by the Texas Department of Transportation is the responsibility of the user. The Texas Department of Transportation is not responsible for any errors or omissions in this standard or for any damages resulting from the use of this standard.

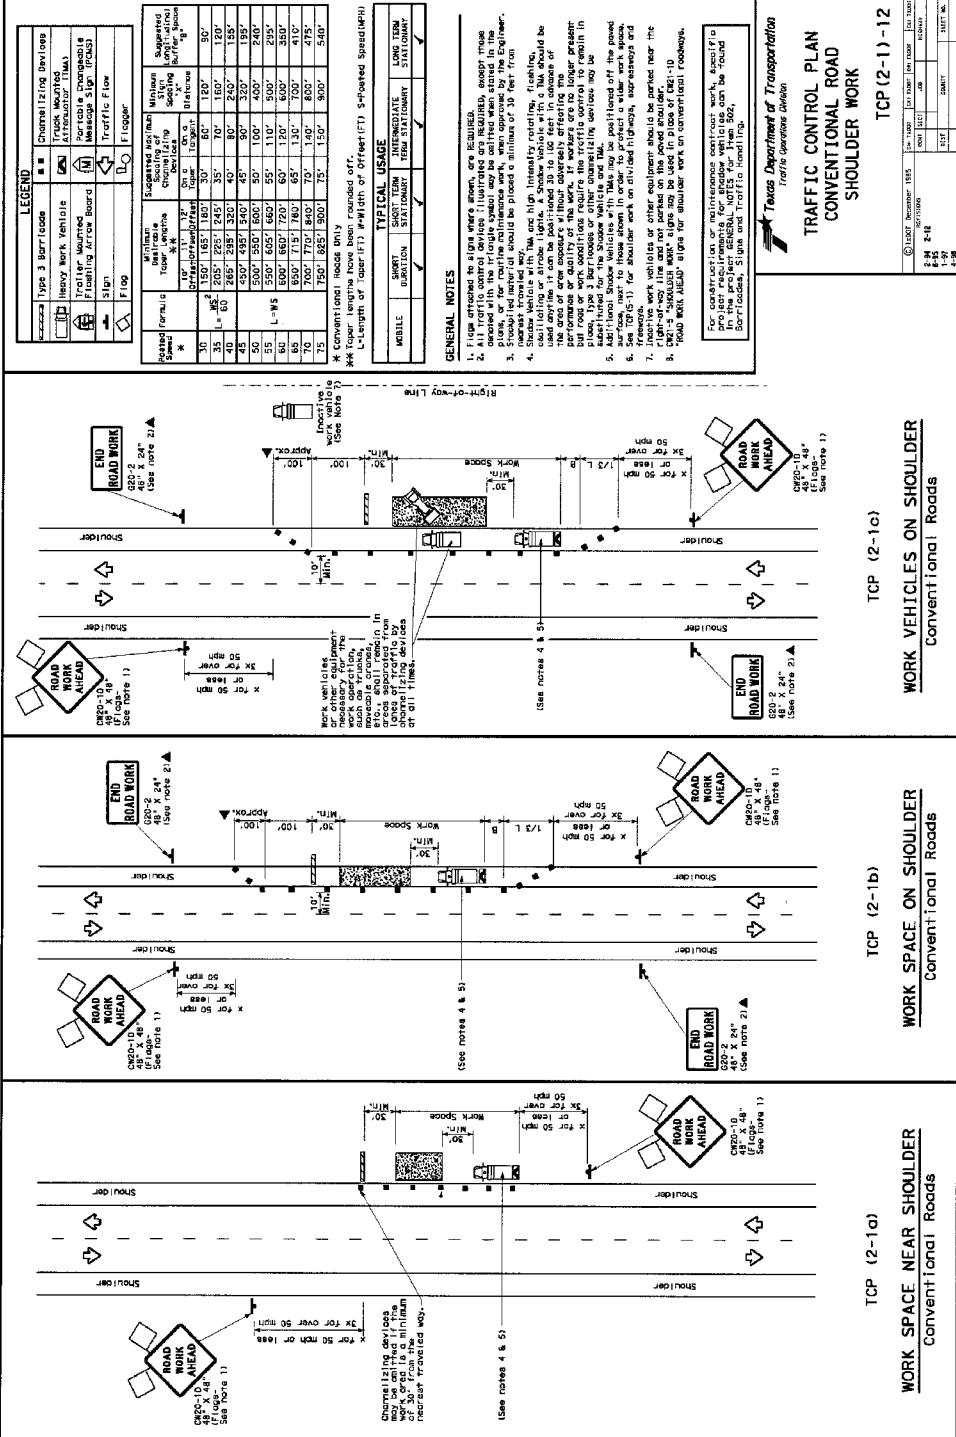

Legend	Symbol	Description
Channelizing Device	Orange Traffic Cones	Channelizing Device
Heavy Work Vehicle	Tractor/Trailer	Heavy Work Vehicle
Trailer Mounted Flashing Arrow Board	Arrow Board	Trailer Mounted Flashing Arrow Board
Sign	Sign	Sign
Flagger	Flagger	Flagger
Traffic Flow	Arrow	Traffic Flow

Speed Limit (mi/hr)	Advance Warning Distance (ft)	Work Zone Length (ft)	Minimum Spacing Between Work Vehicles (ft)	Supervised Buffer Space (ft)
30	150'	165'	30'	50'
35	205'	225'	35'	70'
40	265'	285'	40'	100'
45	325'	345'	45'	130'
50	385'	405'	50'	160'
55	445'	465'	55'	190'
60	505'	525'	60'	220'
65	565'	585'	65'	250'
70	625'	645'	70'	280'
75	685'	705'	75'	310'

GENERAL NOTES

- Flare attached to sign where shown, are required.
- Signs, or for routine maintenance work, may be omitted when stated in the notes.
- Signs, or for routine maintenance work, may be omitted when stated in the notes.
- Signs, or for routine maintenance work, may be omitted when stated in the notes.

TYPICAL USAGE

Mobile	Short Term Station	Intermediate Station	Long Term Station
✓	✓	✓	✓

GENERAL NOTES

- Flare attached to sign where shown, are required.
- Signs, or for routine maintenance work, may be omitted when stated in the notes.
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AT&T Texas/SWB
TxDOT TRAFFIC CONTROL
RICHMOND, TEXAS
CITY OF ROSENBERG
 DEPARTMENT OF PUBLIC WORKS AND ENGINEERING

TRAFFIC CONTROL PLAN
 SHOULDER ROAD
 TCP (2-1) - 12

Project No.	Sheet No.	Scale	Date
9085473	204	1" = 30'	12/10/00

FOR CONSTRUCTION OR MAINTENANCE CONTRACT WORK, SPECIFIC TO THE PROJECT, THE FOLLOWING SIGNAGE WILL BE REQUIRED:
 Channelizing Device
 Heavy Work Vehicle
 Trailer Mounted Flashing Arrow Board
 Sign
 Flagger

CONTRACT NO. 9085473
 SHEET NO. 204
 DATE: 12/10/00
 SCALE: 1" = 30'

PROJECT NO. 9085473
 SHEET NO. 204
 DATE: 12/10/00
 SCALE: 1" = 30'

PROJECT NO. 9085473
 SHEET NO. 204
 DATE: 12/10/00
 SCALE: 1" = 30'

PROJECT NO. 9085473
 SHEET NO. 204
 DATE: 12/10/00
 SCALE: 1" = 30'

GOVT-BUY AMERICA FHWA PROJECT
 (SEE SHEET 100)



Revision	Revision Date	Description	Initial

PREPARED BY: [Name]
 CHECKED BY: [Name]
 DRAWN BY: [Name]
 ISSUE DATE: 12/10/00

PROJECT NO. 9085473
 SHEET NO. 204
 DATE: 12/10/00
 SCALE: 1" = 30'

PROJECT NO. 9085473
 SHEET NO. 204
 DATE: 12/10/00
 SCALE: 1" = 30'

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