

8C

REVIEW BY FORT BEND COUNTY COMMISSIONERS COURT

On this 12 day of JULY, 2011, before the Fort Bend Commissioners Court came on to be heard and reviewed the accompanying notice of PHONOSCOPE LLC

Job Location SANSBURY BOULEVARD

Dated 06/30/11 BOND NO 103827669 Permit No. 83976

to make use of certain Fort Bend County property subject to, "A Revised Order Regulating the Laying, Construction, Maintenance, and Repair of Buried Cables, Conduits, and Pole Lines, In, Under, Across or Along Roads, Streets, Highways, and Drainage Ditches in Fort Bend County, Texas, Under the Jurisdiction of the Commissioners Court of Fort Bend County, Texas," as passed by the Commissioners Court of Fort Bend County, Texas, date the 3rd day of August, 1987, recorded in Volume _____ of the Minutes of the Commissioners Court of Fort Bend County, Texas, to the extent that such order is not inconsistent with Article 1436a, Vernon's Texas Civil Statues. Upon Motion of Commissioner Meyers, seconded by Commissioner Prestage, duly put and carried, it is ORDERED, ADJUGED AND DECREED that said notice of said above purpose is hereby acknowledged by the Commissioners Court of Fort Bend County, Texas, and that said notice be placed on record according to the regulation order thereof.

Notes:

1. Evidence of review by the Commissioners Court must be kept on the job site and failure to do so constitutes grounds for job shutdown.
2. Written notices are required:
 - a. 48 hours in advance of construction start up, and
 - b. When construction is completed and ready for final inspection

Mail notices to: Permit Administrator
Fort Bend County Engineering
P.O. Box 1449
Rosenberg, Texas 77471
281-633-7500

3. This permit expires one (1) year from date of permit if construction has not commenced.

By [Signature]
County Engineer

By _____
Drainage District Engineer/Manager

Presented to Commissioners Court and approved.

Recorded in Volume 7-12-11
Minutes of Commissioners Court.

Clerk of Commissioners Court
By [Signature]
Deputy

COUNTY OF FORT BEND

Engineering Department

P.O. BOX 1449
Rosenberg, Texas 77471-1449

Johnny Ortega
Permit Administrator

1124 Blume Road
Phone: (281) 341-7500

PERMIT APPLICATION REVIEW FORM FOR CABLE, CONDUIT, AND POLE LINE ACTIVITY IN FORT BEND COUNTY

PERMIT NO. 083976

The following "Notice of Proposed Cable, Conduit, and/or Pole Line activity in Fort Bend County" and accompanying attachments have been reviewed and the notice conforms to appropriate regulations set by Commissioner's Court of Fort Bend County, Texas.

- (1) Complete Application Form.
- a. Name of road, street, and/or drainage ditch affected.
- b. Vicinity map showing course of direction.
- c. Plans and specifications.

- (2) Bond:
- District Attorney, approval when applicable.
- Perpetual bond currently posted.
No. 103827669
Amount \$50,000.00
- Performance bond submitted.
No. _____
Amount _____
- Cashier's Check.
No. _____
Amount _____

- (3) Verbal permission given for emergencies, to start construction before approved in Commissioner's Court.

Precinct Engineer Acknowledgment


Date

Precinct Commissioner Acknowledgment

Date

- (4) _____
Drainage District Approval when applicable

We have reviewed this project and agree it meets minimum requirements.

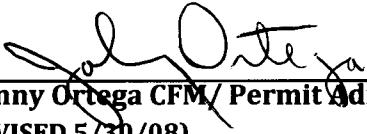

Johnny Ortega CFM/ Permit Administrator
(REVISED 5/30/08)

06/30/2011

Date

**NOTICE OF PROPOSED CABLE, CONDUIT AND/OR POLE LINE ACTIVITY
IN, UNDER, ACROSS OR ALONG ROADS, STREETS, HIGHWAYS AND DRAINAGE DITCHES
IN FORT BEND COUNTY**

APPLICANT'S JOB NO. _____
 PERMIT No. 83976 PCT. No. 1
 BOND No. 103827669

Formal notice is hereby given that _____
 proposes to lay, construct, maintain and/or repair cable, conduit and/or pole line, in, under,
 across, or along roads, streets, highways and drainage ditches in Fort Bend County, as follows:

In, Under, or Across Roads and/or Drainage Ditches

Road or Ditch Name	Distance & Direction From Nearest Intersection	Length of Crossing	Type of Construction			
			Bored	Jacked	Driven	Cased

Along Roads and/or Drainage Ditches

Road or Ditch Name	Distance & Direction From Nearest Intersection	To	Distance
SANDBURY BLVD.	33 FT SOUTH WEST OF		430 FT
	C/L OF CRABB RIVER RD.		

General Description

PROPOSE TO BORE/TRENCH 430' AND INSTALL CONDUIT AND
 FIBER OPTIC CABLE WITHIN R.O.W OF SANDBURY BLVD.

The Location and description of the proposed installation and appurtenances is more fully shown on the attached detail drawings. The laying, construction, maintenance and/or repair of the proposed installation shall be subject to "A Revised Order Regulating the Laying, Construction, Maintenance and/or Repair of Cables, Conduits, and/or Pole Lines, In, Under, Across, or Along Roads, Streets, Highways and Drainage Ditches in Fort Bend County, Texas, Under the Jurisdiction of the Commissioners Court of Fort Bend County, Texas," as passed by Commissioners Court of Fort Bend County, Texas, dated the 3rd. day of August, 1987, recorded in Volume 639 of the Minutes of the Commissioners Court of Fort Bend County, Texas.

Written notices are required: 1) 48 hours in advance of start of construction and
 2) when construction is complete and ready for final inspection.

Mail to: Permit Administrator/Fort Bend County Engineering
 P.O. Box 1449, Rosenberg, TX 77471.

Violation of requirements shall constitute grounds for job shut down.

Does project comply with Fort Bend County Outdoor Lighting Ordinance?
Yes ()
No ()

COMPANY NAME: PHONOSCOPE L&C
 AGENT and/or OWNER

(Signature)
 (Signature)


NAME & TITLE HARRELL TAYLOR/AUTOCAD DRAFTER
 (Please Print)

DATE 6/14/2011

ADDRESS 6105 WESTLINE DR.
 (Street/P.O. Box)

HOUSTON TEX 77036
 City State Zip

TELEPHONE NO: (713)272-4600/832-615-7749
 (accessible 24 hrs/day, 7 days/week)

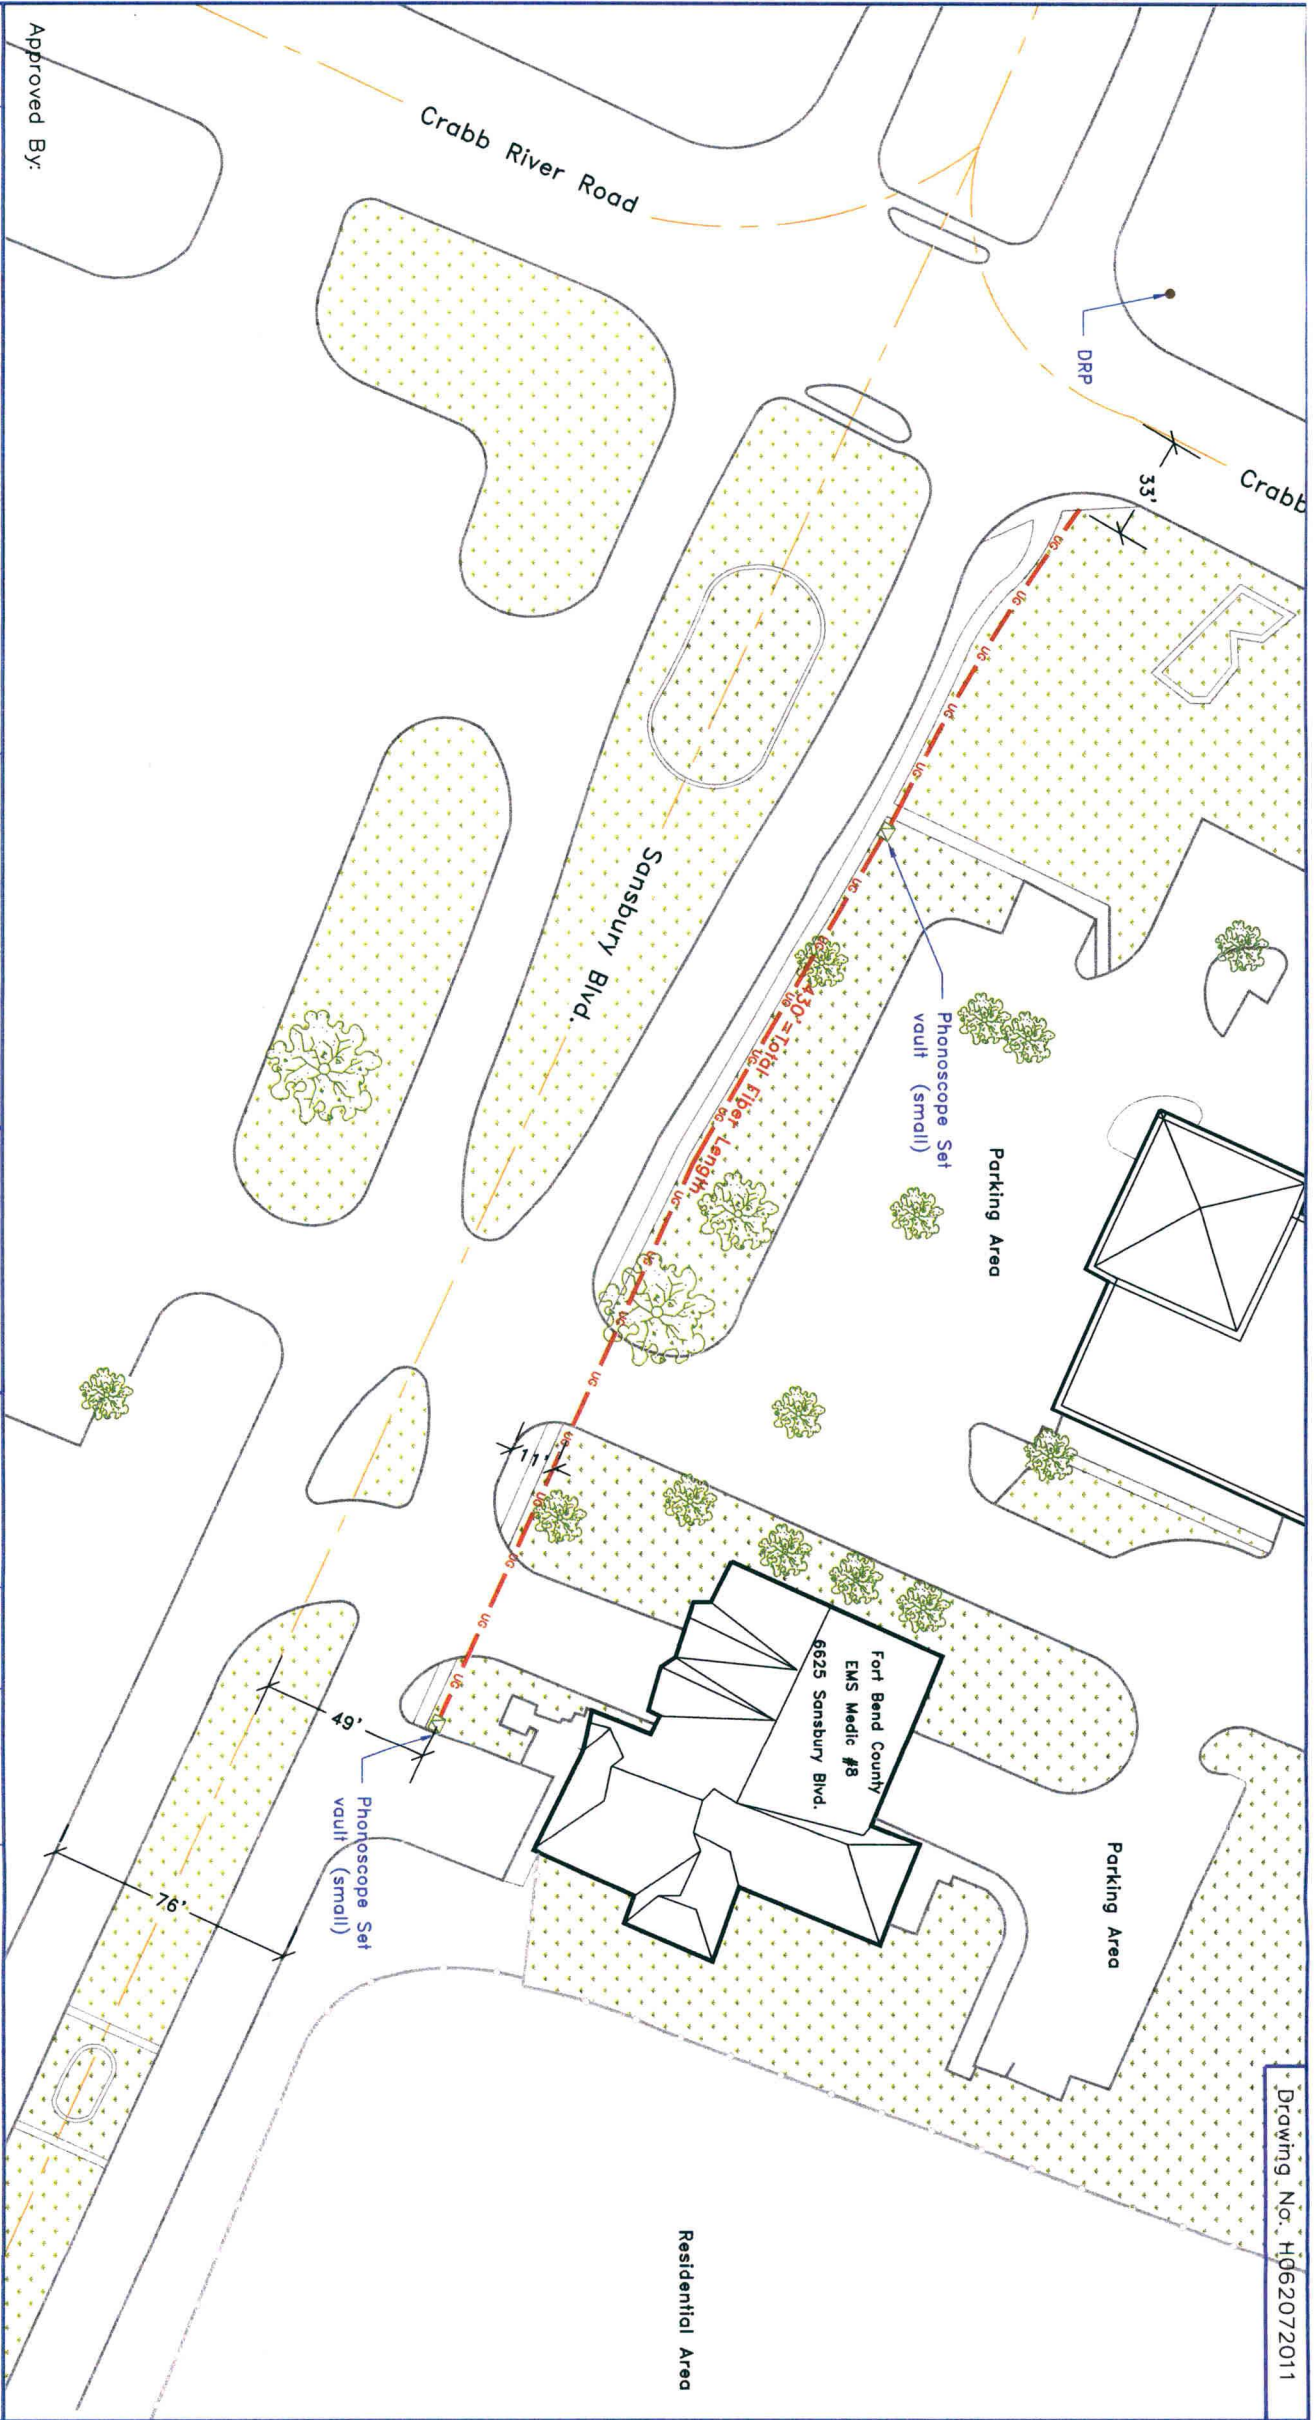

Approved By:

Symbol	Description	Revisions
U6	(3) 1" PVC conduit encasing fiber optic cable underground	
▽	Phonoscope Set vaults (small)	
●	Existing Utility pole	

Key Map: 606 R & 607 N

Drawn By: Harrell Taylor
 Scale: N.T.S.
 Date: 06/07/2011

PHONOSCOPE

FORT BEND COUNTY


Notice of Proposed Utility Installation
 Proposed Underground Wireline Construction
 Site Plan - 6625 Sansbury Blvd

1 of 3

W. O. # 48196

General Notes:

- 1) Surface to be restored to its original condition in compliance with Fort Bend County Standards.
- 2) Traffic Control Plan (1-1c) standards to be used as noted on page 3.

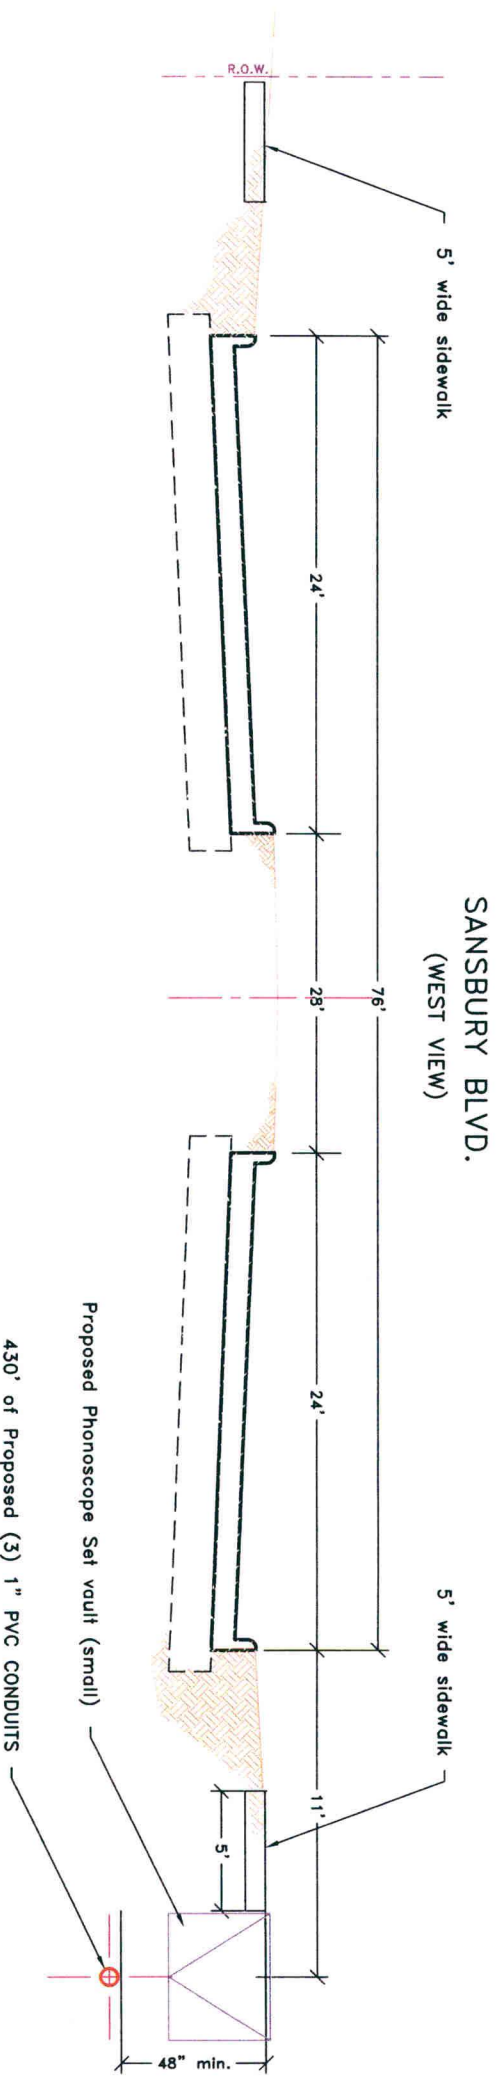

Approved By:

Symbol	Description	Revisions	Drawn By:	Scale:	Date:	FT BEND CO. EMS MEDIC 8 Notice of Proposed Utility Installation Proposed Underground Wireline Crossing Street Cross Section / Profile
— 48"	(3) 1" PVC conduits at a min. of 48" below existing surface		Harrell Taylor	N.T.S.	06/08/2011	
						2 of 3 W.O.# 48196




Key Map: 606 S & 607 N
Confidential and Proprietary



1	2	3	4	5	6	7	8	9	10	11	12	13	14	15	16	17	18	19	20	21	22	23	24	25	26	27	28	29	30	31	32	33	34	35	36	37	38	39	40	41	42	43	44	45	46	47	48	49	50
LEVELS DISPLAYED																																DATE:	DN:																
ACC:																																DW:	CK:																
FILE:																																CK:																	

DISCLAIMER
 The use of this standard is governed by the "Texas Engineering Practice Act". No warranty of any kind is made by TxDOT for any purpose whatsoever. TxDOT assumes no responsibility for the conversion of this standard to other formats or for incorrect results or damages resulting from its use.

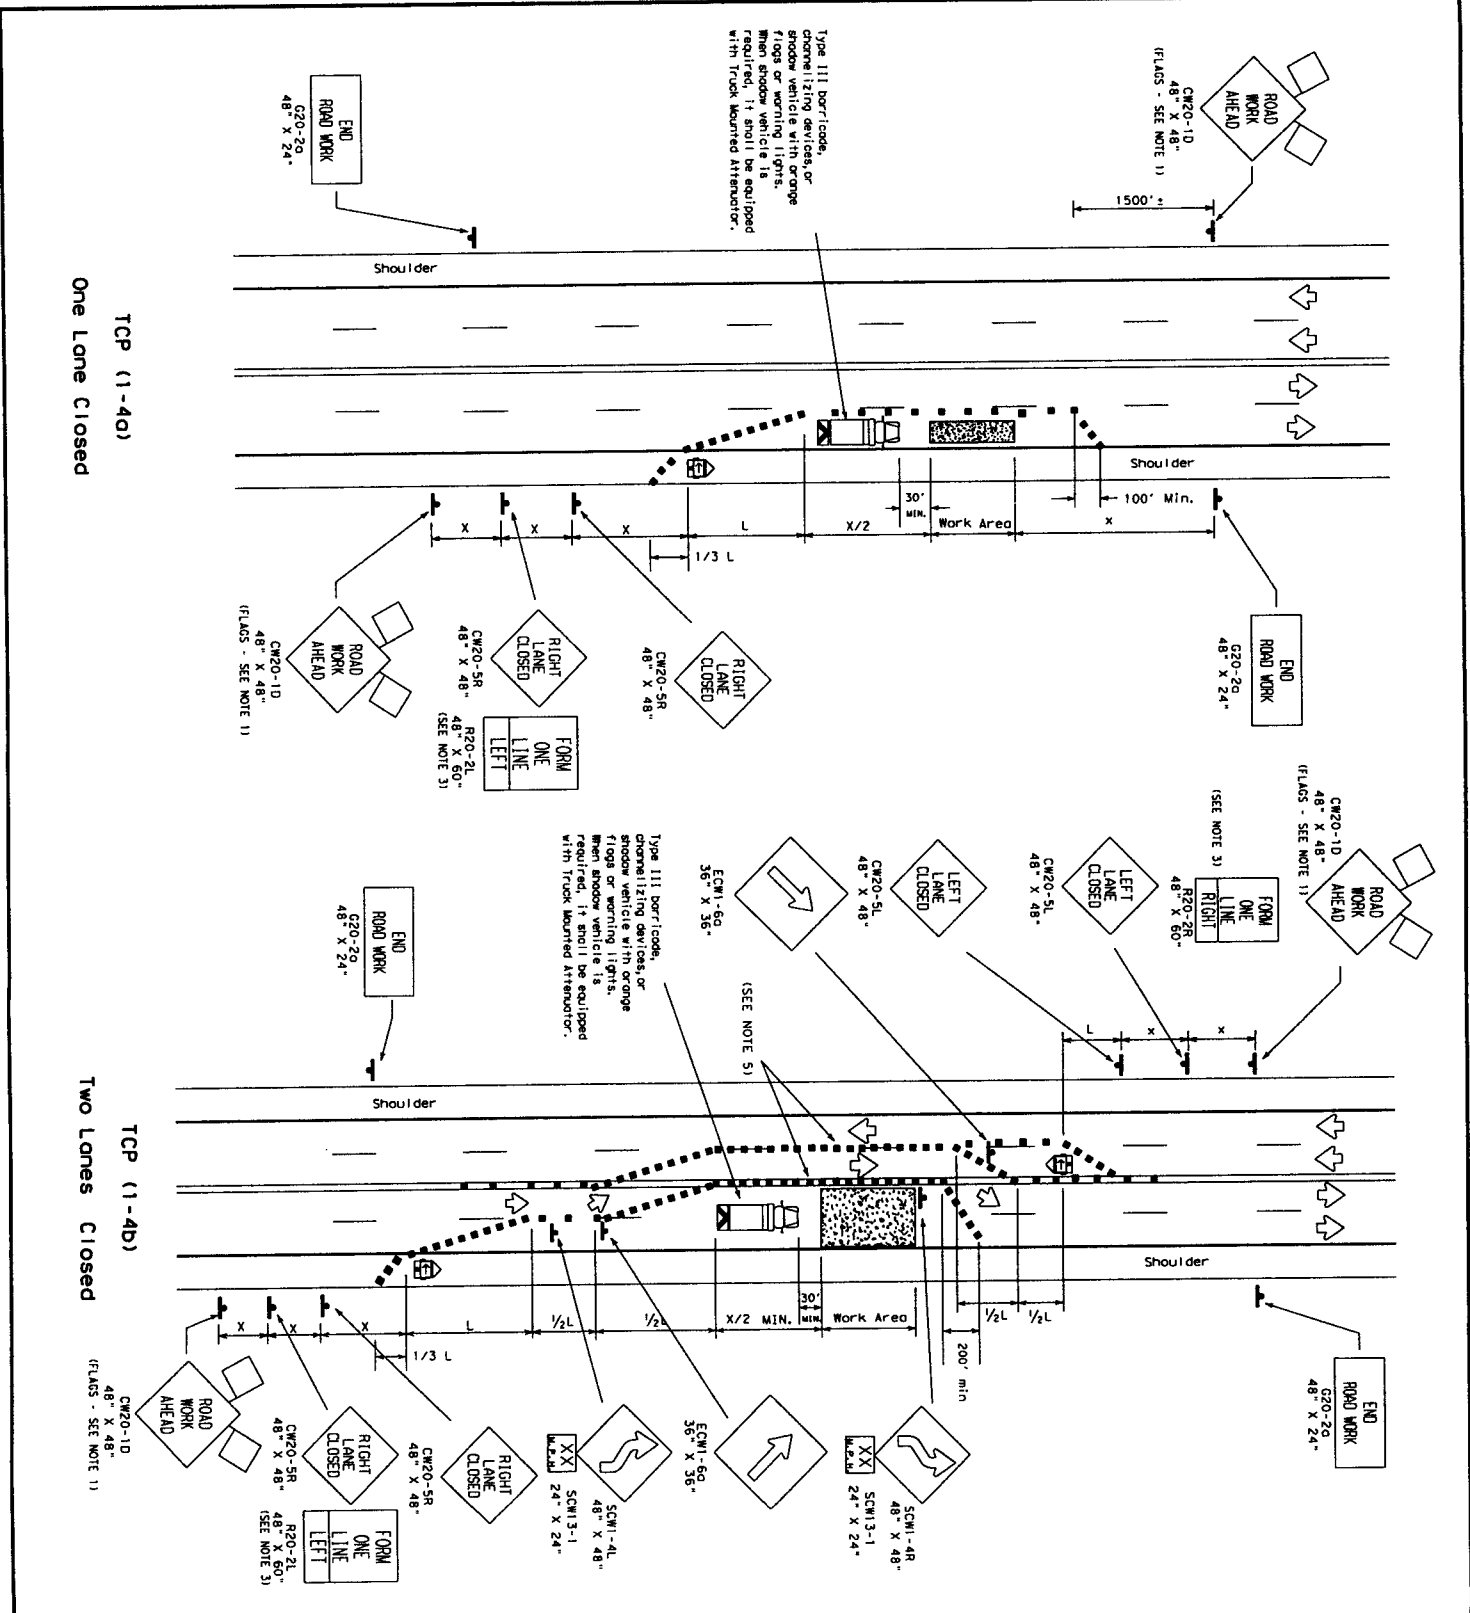

TRAFFIC CONTROL PLAN

TCP (1-4) - 98

STANDARD PLANS
 TEXAS DEPARTMENT OF TRANSPORTATION
 Traffic Operations Division

The equipment for shadow vehicles will be as listed in the project GENERAL NOTES, Item 502, Barricades, Signs and Traffic Handling.

STANDARD ENGINEER
 Traffic Operations Division - TE
 Texas Department of Transportation
 125 East 11th Street, 3403
 Austin, TX 78701-4153
 Phone (512) 416-3161
 Fax (512) 416-3161
 Email: TE-StandardPlans@tpa-dot.state.tx.us

LEGEND

- Type III Barricade
- Heavy Work Vehicle
- Trailer Mounted Flashing Arrow Panel
- Flagger
- Sign Post
- Channelizing Devices
- Truck Mounted Attenuator
- Portable Changeable Message Sign
- Flag

GENERAL NOTES:

- Letters otherwise stated in the plans, flags oriented to the signs are REQUIRED.
- All traffic control devices illustrated are REQUIRED, except those removed with the 'Triangle' symbol may be omitted when stored elsewhere.
- The 'Road One Lane Left' sign may be used following the RIGHT LANE CLOSED sign. Spacing distance between signs should be the minimum distance indicated, or reported if the visibility of the work zone is less than 1000'. If the maximum spacing of channelizing devices in a tangent section should be no greater than 10 feet.
- Signs shall be placed in the work zone as directed over a double yellow centerline. The maximum spacing of channelizing devices in a tangent section should be no greater than 10 feet.

Only pre-qualified products shall be used. A list of compliant products and their sources may be obtained by writing or faxing:

STANDARD ENGINEER
 Traffic Operations Division - TE
 Texas Department of Transportation
 125 East 11th Street, 3403
 Austin, TX 78701-4153
 Phone (512) 416-3161
 Fax (512) 416-3161
 Email: TE-StandardPlans@tpa-dot.state.tx.us

* Conventional Roads Only
 ** Tower lengths have been rounded off.
 † Length of tower (ft.) Bottom of offset (ft.), Suggested Speed (mph)

Posting	Formula	Minimum Distance (ft.)	Suggested Maximum Length of Tower (ft.)	Minimum Sign Spacing (ft.)
30	WS ₁	150' - 165'	180' - 30'	60' - 75'
35	WS ₂	205' - 225'	245' - 35'	70' - 90'
40	L + 60	265' - 295'	320' - 40'	80' - 100'
45	450' - 495'	540' - 45'	90' - 110'	320'
50	500' - 550'	600' - 50'	100' - 125'	400'
55	550' - 605'	660' - 55'	110' - 140'	500'
60	L + WS	600' - 660'	720' - 60'	120' - 150'
65	650' - 715'	780' - 65'	130' - 165'	* 600'
70	700' - 770'	840' - 70'	140' - 175'	* 700'
				* 800'

TYPICAL USAGES

MOBILE	SHORT STATIONARY	INTERMEDIATE STATIONARY	LONG TERM STATIONARY
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