



FORT BEND COUNTY WESTPARK PARK & RIDE ON-SITE SEWAGE FACILITY

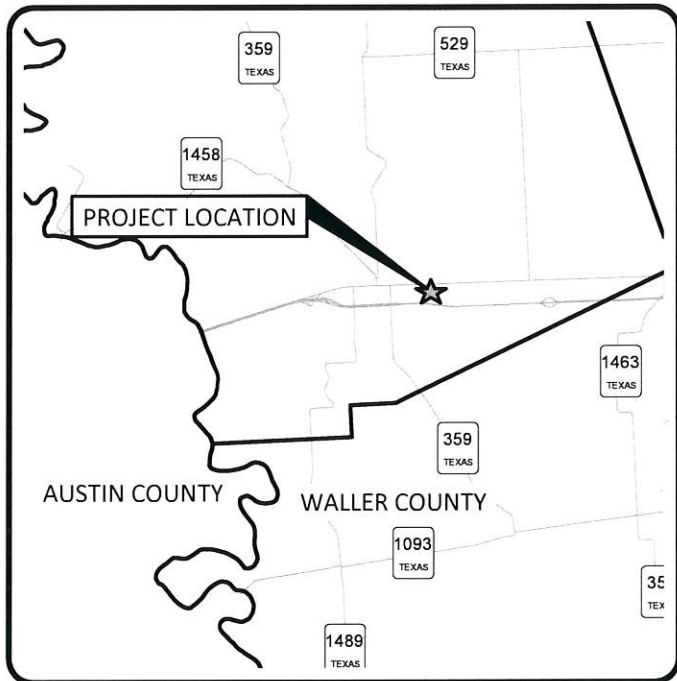

LOCATION MAP
NTS

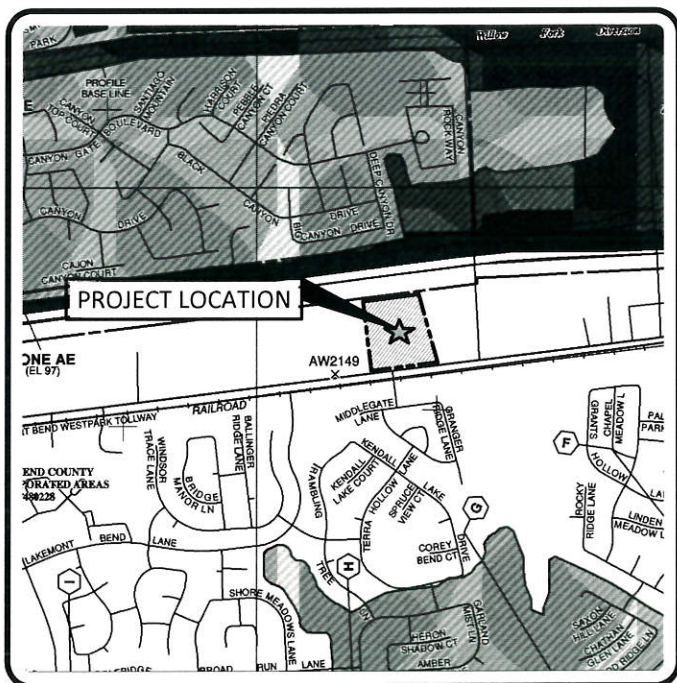


FLOOD PLAIN INFORMATION

SCALE: 1" = 1000'-0" (24"x36")
1" = 2000'-0" (11"x17" 8.5"x11")

ACCORDING TO THE FEDERAL EMERGENCY MANAGEMENT AGENCY
FLOOD INSURANCE RATE MAP COMMUNITY
PANEL No. 48157C0130L DATED: 4/2/2014
THIS TRACT LIES WITHIN ZONE X, AREAS OUTSIDE OF THE 500 YEAR FLOOD PLAIN
THE BASE FLOOD ELEVATION IS 97.00'

OWNER INFORMATION:
FORT BEND COUNTY
301 JACKSON ST, RM 101
RICHMOND, TEXAS 77469-3108

PROJECT LOCATION:
19820 FM 1093 RD.
KATY, TEXAS 77450

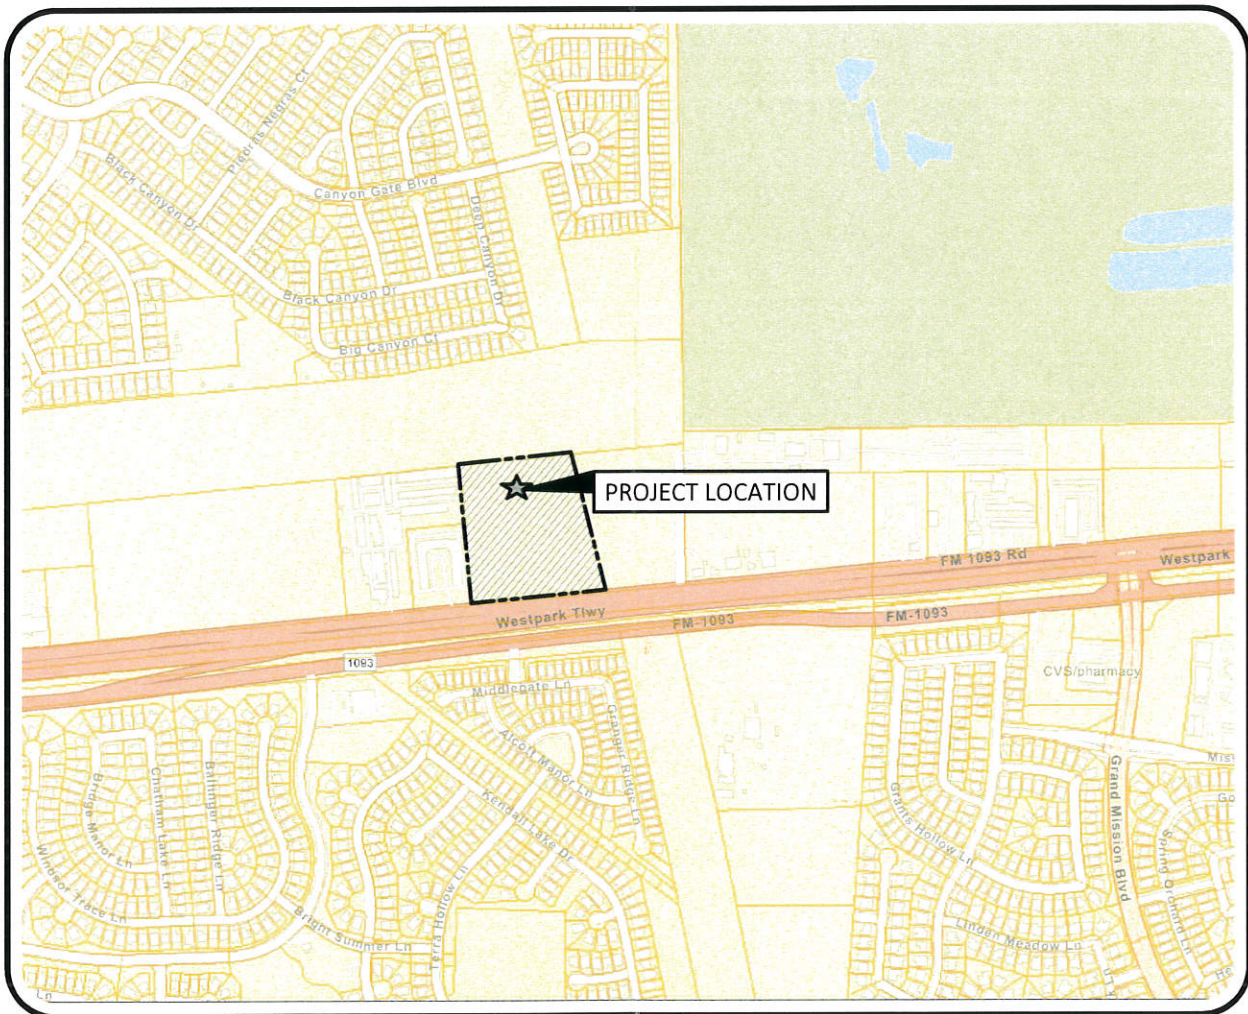

VICINITY MAP

FORT BEND COUNTY, TEXAS
KEY MAP PAGE No. 526 F
SCALE: 1" = 500'-0" (24"x36")
1" = 1000'-0" (11"x17" 8.5"x11")

SHEET INDEX

SHEET No.	SHEET NAME
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02	DESIGN CRITERIA & GENERAL NOTES
03	SITE PLAN
04	OSSF PLAN
05	OSSF TANK AREA PLAN & DETAILS
06	OSSF TANK SCHEMATIC

REVISION	DATE
DESCRIPTION	M/D/YY

WATERENGINEERS, INC.
Water & Wastewater Treatment Consultants
TEXAS BOARD OF PROFESSIONAL ENGINEERS FIRM No. 2066
17230 HUFFMEISTER ROAD
CYPRESS, TEXAS 77429
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**FORT BEND COUNTY
WESTPARK PARK & RIDE
ON-SITE SEWAGE FACILITY**
19820 FM 1093 RD.
KATY, TEXAS 77450

SHEET NAME:
COVERSHEET

DRAWN BY: JLW
CHECKED BY: NCL
PJT No.: 5772-21008
DATE: 06/27/2024
SHEET No.:

01 OF 06



\\server\wei cad\current jobs\5772 fbc park & ride\oss\02 design criteria & general notes.dwg

Fort Bend County Westpark Park & Ride On-Site Sewage Facility Projected Sewage Flows									
Daily Flows		TCEQ Chapter 285 (Modified)		BOD LOADING		NOTES			
Bus Drivers		4 gal. / day		600 mg/l BOD					
Park & Ride Guests (292 Parking Spaces)		2 gal. / day		600 mg/l BOD					
DAILY OCCUPANCY									
Population ~ Number of Persons		SUN	MON	TUES	WEDS	THURS	FRI	SAT	
Bus Drivers		12	12	12	12	12	12	12	
Park & Ride Guests (292 Parking Spaces)		292	292	292	292	292	292	292	
DAILY FLOW									
Flow ~ gallons per day		SUN	MON	TUES	WEDS	THURS	FRI	SAT	Total
Bus Drivers		48	48	48	48	48	48	48	336
Park & Ride Guests (292 Parking Spaces)		584	584	584	584	584	584	584	4,088
Total Flow Generated (gallons)		632	632	632	632	632	632	632	4,424
Plant Throughput		(632)	(632)	(632)	(632)	(632)	(632)	(632)	(4424)
Hydraulic Carryover To Be Stored		0	0	0	0	0	0	0	
Volume in Storage, gallons		0	0	0	0	0	0	0	
DESIGN FLOW									
Average Daily Flow		632 gallons per day			Based on TCEQ Ch 285 low flow fixtures				
Max. Daily Flow		632 gallons per day							
Raw Wastewater BOD		3.16 lb BOD per day			Based on Assumed BOD's & Avg Flow				
Average Wastewater BOD Conc.		600 mg/l							
PRETREATMENT TANK									
Required Pretreatment Tank Volume		632 gallons			Minimum 1 Max Day Flow				
Proposed Pretreatment Tank Volume		1,338 gallons			Provide (1) Gatco Model DZ-1250 SEP (1383 gal.)				
Pretreatment Tank Detention		51 hours							
BOD Reduction in Pretreatment Tanks, % Removal		0% removal							
BOD Remaining for Treatment		3.2 lb BOD per day							
Duration of Flow into Pretreatment Tanks		24 hours per day			Based on 24 Hours of operation during an event per day				
Duration of Flow into ATU" from Dosing Tanks		24 hours per day			Based on 24 Hours of operation, 7 days a week				
HOLDING / DOSING TANK									
Required Holding / Dosing Tank Volume		967 gallons			1.33 times max. Daily Flow + 20% Storage Volume Required				
Proposed Holding / Dosing Tank Volume		1,383 gallons			Provide (1) Gatco DZ-1250 Pump Tank (1383 gal.)				
Flow Dosed to ATU's		6.58 gal. / dose			Provide (2) Hydromatic SHEF 30 - 0.33 hp Dosing Pumps				
Dosing Duration		2.00 min. every 15 min.							
Feed Rate to each ATU		3.29 gpm			Adjust Ball Valve in ATU & Dosing Pump Recycle Valve accordingly				
BOD Fed to ATU's		0.13 lb BOD per hour			Based on 24 Hours of operation per day				
AEROBIC TREATMENT UNIT									
Hydraulic Capacity of ATU's (Each)		1,500 gallons per day							
BOD Capacity of ATU's (Each)		3.75 lb BOD per day							
Aerobic Treatment Units Proposed		1 ea			Provide (1) Pro-Flo Model 1500 GPD Aerobic Treatment Units				
Total ATC Hydraulic Capacity of ATU's		1,500 gallons per day							
Total BOD Treatment Capacity of ATU's (daily)		3.75 lb BOD per day							
Total BOD Treatment Capacity of ATU's (hourly)		0.16 lb BOD/hour			> 0.13		# BOD/hour = OK		
EFFLUENT PUMP TANK									
Effluent Holding Tank Volume Required		841 gallons			Based on 1.33 times Average Daily Flow				
Effluent Holding Tank Volume Provided		1,383 gallons			Provide (1) Gatco DZ-1250 Pump Tank (1383 gal.)				
EFFLUENT DISPOSAL AREA									
Spray Irrigation Application Rate		0.045 gallons/day/sq ft			Based on Class II Soil				
Disposal Area Required		14,044 square feet							
Disposal Area Provided		14,138 square feet							
Diameter of Spray Heads		60 feet			30 foot radius				
Area of Coverage for each spray Head		2,828 square feet			Non-overlapping areas				
Minimum No of Spray Heads Req'd		5.0 ea							
Proposed No. of Sprayheads		5.0 ea			Install 30 foot radius Sprayheads				
Flow Per Spray Head		3.1 gpm							
No. of Proposed Zones		1 ea							
No. of Spray Heads Per Zone		5 ea							
Flow Per Zone		15.50 gpm			Provide Franklin Series V - 3/4 hp 15.5 gpm @ 150' TDH				
Pumping Duration Per Zone		40.8 minutes/day			Start pump at 1:00 am, run for 40.8 Minutes per zone				

GENERAL ON-SITE SEWAGE FACILITY NOTES:

1. AN ON-SITE SEWERAGE FACILITY LICENSE MUST BE OBTAINED FROM THE LOCAL REGULATORY AUTHORITY PRIOR TO CONSTRUCTION OF THIS SYSTEM.
2. ALL CONSTRUCTION METHODS AND MATERIALS SHALL BE IN ACCORDANCE WITH MUNICIPAL, COUNTY AND STATE RULES AND POLICIES UNLESS SPECIFICALLY NOTED ON THIS DRAWING AND APPROVED BY THE LOCAL LICENSING AUTHORITY.
3. SYSTEM INSTALLATION SHALL BE BY A REGISTERED INSTALLER II OF ON-SITE SEWAGE FACILITIES, AS REQUIRED BY ARTICLE 4477-7E, VERNON'S TEXAS CIVIL STATUTES, OR BY THE OWNER OF THE PROPERTY UNDER LICENSE.
4. THIS SYSTEM, IF INSTALLED AND OPERATED IN ACCORDANCE WITH THIS PLAN AND STATE, COUNTY OR LOCAL RULES AND REGULATIONS, SHOULD NOT PRESENT A HAZARD TO PUBLIC HEALTH, OR THREATEN ADJACENT WATER WELLS.
5. IT IS THE INSTALLER'S RESPONSIBILITY TO INSURE THAT SAFE DISTANCES FROM ANY WATER WELLS MEET OR EXCEED STATE AND LOCAL CRITERIA, AND ARE IN ACCORDANCE WITH THE LICENSE ISSUED.
6. IT IS THE INSTALLER'S RESPONSIBILITY TO REVIEW THE DESIGN CRITERIA WHICH ACCOMPANIES OR IS SHOWN ON THIS DRAWING. THE CRITERIA IS AN IMPORTANT PART OF THE CONSTRUCTION DOCUMENTATION PACKAGE.
7. STORM OR SITE DRAINAGE IMPROVEMENTS SHOWN ON THIS PLAN SHALL BE CONSTRUCTED PRIOR TO COMMENCEMENT OF CONSTRUCTION OF THE ON-SITE SEWAGE FACILITY.
8. SITE SHALL BE CAREFULLY FINISH GRADED AFTER COMPLETION OF SYSTEM INSTALLATION TO PROVIDE POSITIVE STORM WATER RUNOFF. ABSORPTION AREAS SHALL BE CROWNED. DRAINAGE SWALES SHALL BE CONSTRUCTED TO ADEQUATELY CONVEY STORM WATER AWAY FROM THE ABSORPTION AREA.
9. IF PROPERTY IS LOCATED WITHIN THE 100-YEAR FLOOD PLAIN, ALL MECHANICAL AND ELECTRICAL COMPONENTS SHALL BE ELEVATED AT LEAST 18 INCHES ABOVE THE 100 YEAR FLOOD ELEVATION, OR WATERPROOFED.
10. IF ANY DISCREPANCIES EXIST BETWEEN THIS PLAN AND ACTUAL SITE CONDITIONS, IT IS THE RESPONSIBILITY OF THE INSTALLER TO NOTIFY THE ENGINEER AND LICENSING AUTHORITY PRIOR TO CONSTRUCTION.
11. ELECTRICAL WORK SHALL BE IN CONFORMANCE WITH THE NATIONAL ELECTRICAL CODE, CURRENT EDITION.
12. CONDENSATE FROM AIR CONDITIONING, ICE MACHINES OR OTHER REFRIGERATION EQUIPMENT SHALL NOT BE DISCHARGED INTO THE ON-SITE SEWAGE SYSTEM UNLESS SYSTEM HAS BEEN OVERSIZED TO ACCOMMODATE SUCH DISCHARGE. WATER SOFTENER BACKWASH SHALL NOT BE INTRODUCED INTO THE ON-SITE SEWAGE SYSTEM. POOL/SPA DRAINS OR BACKWASH SHALL NOT BE INTRODUCED INTO SEWERAGE SYSTEM.
13. PLUMBING STUBOUTS SHALL BE CONSTRUCTED AS SHALLOW AS POSSIBLE. MAXIMUM DEPTH BELOW NATURAL GROUND TO FLOWLINE: 12 INCHES.
14. THE LICENSING AUTHORITY SHALL BE NOTIFIED FOR INSPECTION PRIOR TO COVERING OF ANY SYSTEM COMPONENTS.
15. CONTRACTOR SHALL NOTIFY UTILITY COORDINATING COMMITTEE, 800-669-8344 AND/OR TEXAS ONE CALL SYSTEM, 800-245-4545, WELL IN ADVANCE OF CONSTRUCTION FOR THE PURPOSE OF LOCATING UNDERGROUND LINES. AUTHORITY: OSHA RULE 1926.651.
16. WHERE A NEW POTABLE WATERLINE CROSSES A NEW PRESSURE RATED WASTEWATER MAIN OR LATERAL, ONE SEGMENT OF THE WATERLINE PIPE SHALL BE CENTERED OVER THE WASTEWATER LINE SUCH THAT THE JOINTS OF THE WATERLINE PIPE ARE EQUIDISTANT AND AT LEAST NINE FEET HORIZONTALLY FROM THE CENTER LINE OF THE WASTEWATER LINE OR LATERAL. THE POTABLE WATER LINE SHALL BE AT LEAST SIX INCHES ABOVE THE WASTEWATER LINE OR LATERAL. WHENEVER POSSIBLE, THE CROSSING SHALL BE CENTERED BETWEEN THE JOINTS OF THE WASTEWATER MAIN OR LATERAL. THE WASTEWATER PIPE SHALL HAVE A MINIMUM RATING OF AT LEAST 150 psi. THE WASTEWATER MAIN OR LATERAL SHALL BE EMBEDDED IN CEMENT STABILIZED SAND FOR THE TOTAL LENGTH OF ONE PIPE SEGMENT PLUS 12 INCHES BEYOND THE JOINT ON EACH END.
17. IT IS THE INSTALLER'S RESPONSIBILITY TO BE FAMILIAR WITH AND COMPLY WITH OSHA TRENCH SAFETY PROVISIONS.
18. ALL WASTEWATER CLEAN OUTS AND RISER COVERS SHALL BE A MINIMUM OF 12" BELOW FINISHED FLOOR ELEVATION, INCLUDING ANY SUNKEN SLAB AREAS THAT HAVE PLUMBING FIXTURES. PURPOSE: TO PROVIDE OVERFLOW RELIEF IN CASE OF PUMP FAILURE OR WASTEWATER SYSTEM LINE CLOGGING.
19. DISTRIBUTION PIPING FOR TREATED EFFLUENT FOR SURFACE APPLICATION OR EMITTER SYSTEMS SHALL BE SCH 40 PVC, MADE OF PURPLE COLOR MATERIAL. ALL IRRIGATION SPRAY HEADS SHALL HAVE PURPLE COLORED COVERS OR TOPS. CONVENTIONAL WHITE COLOR PVC FITTINGS MAY BE USED.
20. UNLESS OTHERWISE SPECIFIED, THE MINIMUM DEPTH OF COVER OVER PIPELINES AND CONDUITS SHALL BE AS FOLLOWS:
 - A. ELECTRICAL CONDUIT - 24 INCHES (36 INCHED UNDER ROADWAYS)
 - B. SANITARY SEWER FORCE MAINS - 24 INCHES (35 INCHES UNDER ROADWAYS)
 - C. LATERAL SPRINKLER LINES - 12 INCHES
20. LOW VOLTAGE CONTROL CONDUCTORS SHALL BE UL APPROVED, DIRECT BURIAL TYPE UF, NO. 12 AWG, SOLID COPPER, UNLESS OTHERWISE REQUIRED, IN ACCORDANCE WITH THE CONTROL EQUIPMENT MANUFACTURERS RECOMMENDATION.



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FORT BEND COUNTY
WESTPARK PARK & RIDE
ON-SITE SEWAGE FACILITY

19820 FM 1093 RD.
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SHEET NAME:

DESIGN CRITERIA & GENERAL NOTES

DRAWN BY:	JLW
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PJT No.:	5772-21008
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