

# REVIEW BY FORT BEND COUNTY COMMISSIONERS COURT

## **Fort Bend County**

Engineering Department 301 Jackson Suite 401 Richmond, Texas 77469

004 000 7500
281.633.7500
Permits@fortbendcountytx.gov

	X Right of Way Commercial D Permit No: 2018-23	Driveway Permit
Appli	cant: Comcast of Houston, LLC	
Job L	ocation Site: 8303 McHard Road , Houston, TX	C 77053
Bond	No. Date of Bond: 7/24/	/2007 Amount: \$100,000.00
Laying Roads Comn of the	g, Construction, Maintenance, and Repair of Buried s, Streets, Highways, and Drainage Ditches in Fort B	ssed by the Commissioners Court of Fort Bend County, Texas, County, Texas, to the extent that such order is not
Notes 1. 2.	Evidence of review by the Commissioners Court m grounds for job shutdown. Written notices are required: a. 48 hours in advance of construction	d ready for final inspection, submit notification to Permit Online.org portal.
Comn notice		nd carried, it is ORDERED, ADJUDGED AND DECREED that said the Commissioners Court of Fort Bend County, Texas, and
Signa	ture	Presented to Commissioners Court and approved.
Ву:	County Engineer	Date Recorded Comm. Court No
	N/A	Clerk of Commissioners Court
Ву:	Drainage District Engineer/Manager	By: Deputy



# PERMIT APPLICATION REVIEW FORM FOR CABLE, CONDUIT, AND POLE LINE ACTIVITY IN FORT BEND COUNTY

### Fort Bend County Engineering Department

301 Jackson Suite 401 Richmond, Texas 77469 281.633.7500 Permits@fortbendcountytx.gov

X	Right of Way Permit
	Commercial Driveway Permit
Perr	nit No: 2018-23132

The following "Notice of Proposed Cable, Conduit, and/or Pole Line activity in Fort Bend County" and accompanying attachments have been reviewed and the notice conforms to appropriate regulations set by Commissioner's Court of Fort Bend County, Texas. (1) COMPLETE APPLICATION FORM: a. Name of road, street, and/or drainage ditch affected. b. Vicinity map showing course of directions c. Plans and specifications (2) BOND: County Attorney, approval when applicable. Perpetual bond currently Bond No: Amount: \$100,000.00 posted. Performance bond submitted. Bond No: Amount: Cashier's Check Check No: Amount: (3) DRAINAGE DISTRICT APPROVAL (WHEN APPLICABLE): **Drainage District Approval** Date We have reviewed this project and agree it meets minimum requirements. 10/15/2018 Permit Administrator Date

#### Scope of work to Target address - 8303 MCHARD RD

- PROJECT BEGINS AT PROPOSED PED 410' N C/L OF MCHARD RD.
- BORE 315' AND TRENCH 806' AS INDICATED
- PROJECT ENDS AT PROPOSED PED 570' E OF C/L WEST DR.
- TOTAL PROJECT IS 1121'.



WORK AREA

**VICINITY MAP** 

SCALE: NONE

#### **BUILD:**

Bore footage: 315' Trench footage: 806' Bore Pits: 6 Potholes: 0' New Aerial: Overlash: 0' New Vaults: 0 **Existing Vaults:** New Pedestals: 0 **Existing Pedestals:** 0 Overpull Existing Conduit: 0' Total Project Footage: 1121'

#### LEGEND

RISER

Ŏ UTILITY POLE

DOWN GUY AND ANCHOR

PEDESTAL / VAULT

AERIAL ROUTE
UNDERGROUND ROUTE

### **CONTACTS**


Lia Lopez Construction — Serviceability & Permit Supervisor (713) 637—5248 (Ext. 2775248)

> Juan Jimenez Construction Specialist (713) 637-5248 (Ext. )





#### FORT BEND COUNTY, TEXAS

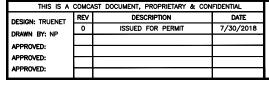



7666 Blanding Boulevard Jacksonville, FL 32244 (904) 777- 9052



TITLE	PAGE	
8303 MG	CHARD	RD


PROJ#:77666

CONSTRUCTION TYPE: UNDERGROUND

SYSTEM: HOUSTON

NODE: N/A

### SHEET 1

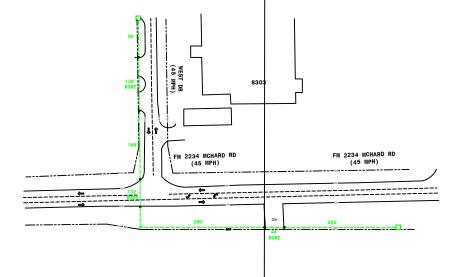

SHEET 2

- 1. CONTRACTOR SHALL CALL FOR LOCATES 3 DAYS PRIOR TO PLANNED COMMENCEMENT OF WORK.
- 2. THE CONTRACTOR SHALL DETERMINE THE EXACT LOCATION OF ALL UNDERGROUND FACILITIES BEFORE COMMENCING WORK AND AGREE TO BE FULLY RESPONSIBLE FOR ALL DAMAGES CAUSED BY HIS FAILURE TO EXACTLY LOCATE AND PRESERVE ALL UNDERGROUND FACILITIES.
- 3. NO MORE TRENCH OPENED AT ONE TIME THAN CAN BE BACKFILLED AND COMPACTED IN 10" LIFTS AT THE END OF EACH DAY. (NO TRENCH LEFT OPENED OVERNIGHT)
- 4. ALL EXCESS EXCAVATION TO BE REMOVED FROM THE ROAD RIGHT-OF-WAY AT THE END OF EACH DAY.
- 5. DITCHES TO BE OPENED AT THE END OF EACH DAY TO ASSURE
- 6. ROAD MUST BE KEPT OPEN TO TRAFFIC AND CONTRACTOR MUST PROVIDE ADEQUATE FLAGMEN, SIGNALS, ETC., TO PROVIDE COMPLETE SAFETY TO THE PUBLIC.
- 7. IF IT BECOMES NECESSARY FOR EQUIPMENT TO OPERATE ON A PORTION OF THE PAVEMENT, PRECAUTIONS MUST BE TAKEN TO PREVENT ANY DAMAGE WHATSOEVER TO THE PAVEMENT.
- 8. CONDITION OF ROAD UPON COMPLETION OF JOB SHALL BE AS GOOD OR BETTER THAN PRIOR TO STARTING.
- 9. CONTRACTOR SHALL COMPLY WITH ALL APPLICABLE NATIONAL ELECTRICAL SAFETY CODE (NESC) REQUIREMENTS, CENTERPOINT ENERGY ELECTRIC POLE ATTACHMENT GUIDELINES & PROCEDURES AND ALL APPLICABLE LOCAL REQUIREMENTS AND REGULATIONS FOR PLACEMENT OF AERIAL CABLE FACILITIES, 18' MIN. VERTICAL CLEARANCE





JT77666 - 8303 MCHARD RD - FORT BEND COUNTY


DESIGNED BY: TRUENET COMMUNICATIONS


DRAWN BY: ED DWG. NO. SHEET NO. COVER LAMBERT:


DATE: 07/31/2018

KEY MAP NO:

SCALE: NTS

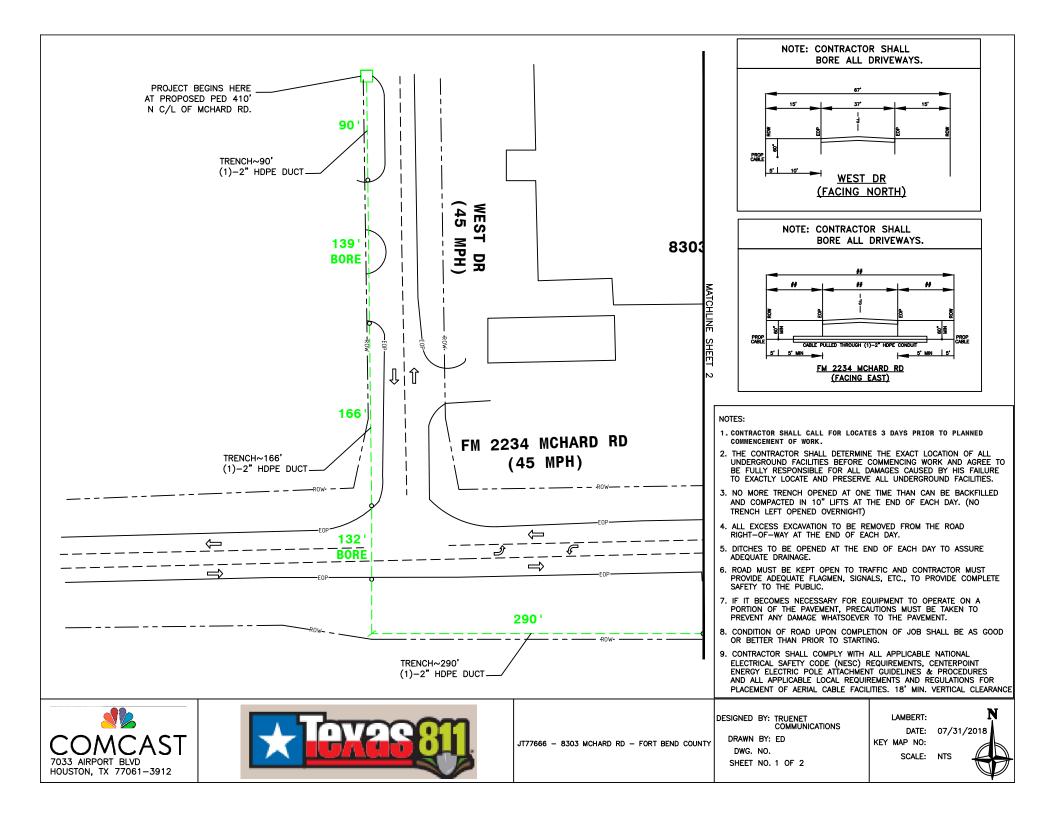

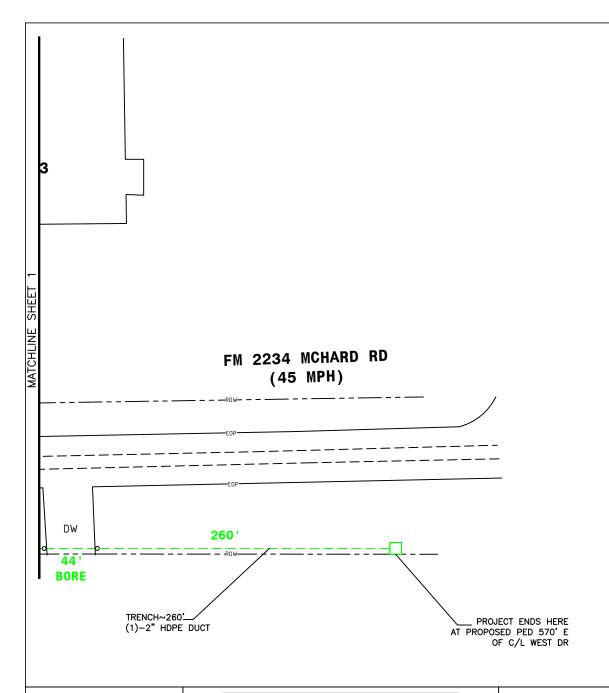

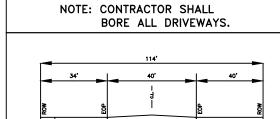

#### NOTES

 CONTRACTOR SHALL CALL FOR LOCATES 3 DAYS PRIOR TO PLANNED COMMENCEMENT OF WORK.

2234 MCHARD RD (FACING WEST)

- 2. THE CONTRACTOR SHALL DETERMINE THE EXACT LOCATION OF ALL UNDERCROUND FACILITIES BEFORE COMMENCING WORK AND AGREE TO BE FULLY RESPONSIBLE FOR ALL DAMAGES CAUSED BY HIS FAILURE TO EXACTLY LOCATE AND PRESERVE ALL UNDERGROUND FACILITIES.
- 3. NO MORE TRENCH OPENED AT ONE TIME THAN CAN BE BACKFILLED AND COMPACTED IN 10" LIFTS AT THE END OF EACH DAY. (NO TRENCH LEFT OPENED OVERNIGHT)
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- 5. DITCHES TO BE OPENED AT THE END OF EACH DAY TO ASSURE ADEQUATE DRAINAGE.
- ROAD MUST BE KEPT OPEN TO TRAFFIC AND CONTRACTOR MUST PROVIDE ADEQUATE FLAGMEN, SIGNALS, ETC., TO PROVIDE COMPLETE SAFETY TO THE PUBLIC.
- IF IT BECOMES NECESSARY FOR EQUIPMENT TO OPERATE ON A PORTION OF THE PAVEMENT, PRECAUTIONS MUST BE TAKEN TO PREVENT ANY DAMAGE WHATSOEVER TO THE PAVEMENT.
- 8. CONDITION OF ROAD UPON COMPLETION OF JOB SHALL BE AS GOOD OR BETTER THAN PRIOR TO STARTING.
- 9. CONTRACTOR SHALL COMPLY WITH ALL APPLICABLE NATIONAL
  ELECTRICAL SAFETY CODE (NESC) REQUIREMENTS, CENTERPOINT
  ENERGY ELECTRIC POLE ATTACHMENT GUIDELINES & PROCEDURES
  AND ALL APPLICABLE LOCAL REQUIREMENTS AND REGULATIONS FOR
  PLACEMENT OF AERIAL CABLE FACILITIES. 18' MIN. VERTICAL CLEARANCE






JT77666 - 8303 MCHARD RD - FORT BEND COUNTY

DESIGNED BY: TRUENET COMMUNICATIONS

DRAWN BY: ED DWG. NO. SHEET NO. 2 OF 2 LAMBERT: DATE: 07/31/2018
KEY MAP NO:

SCALE: NTS



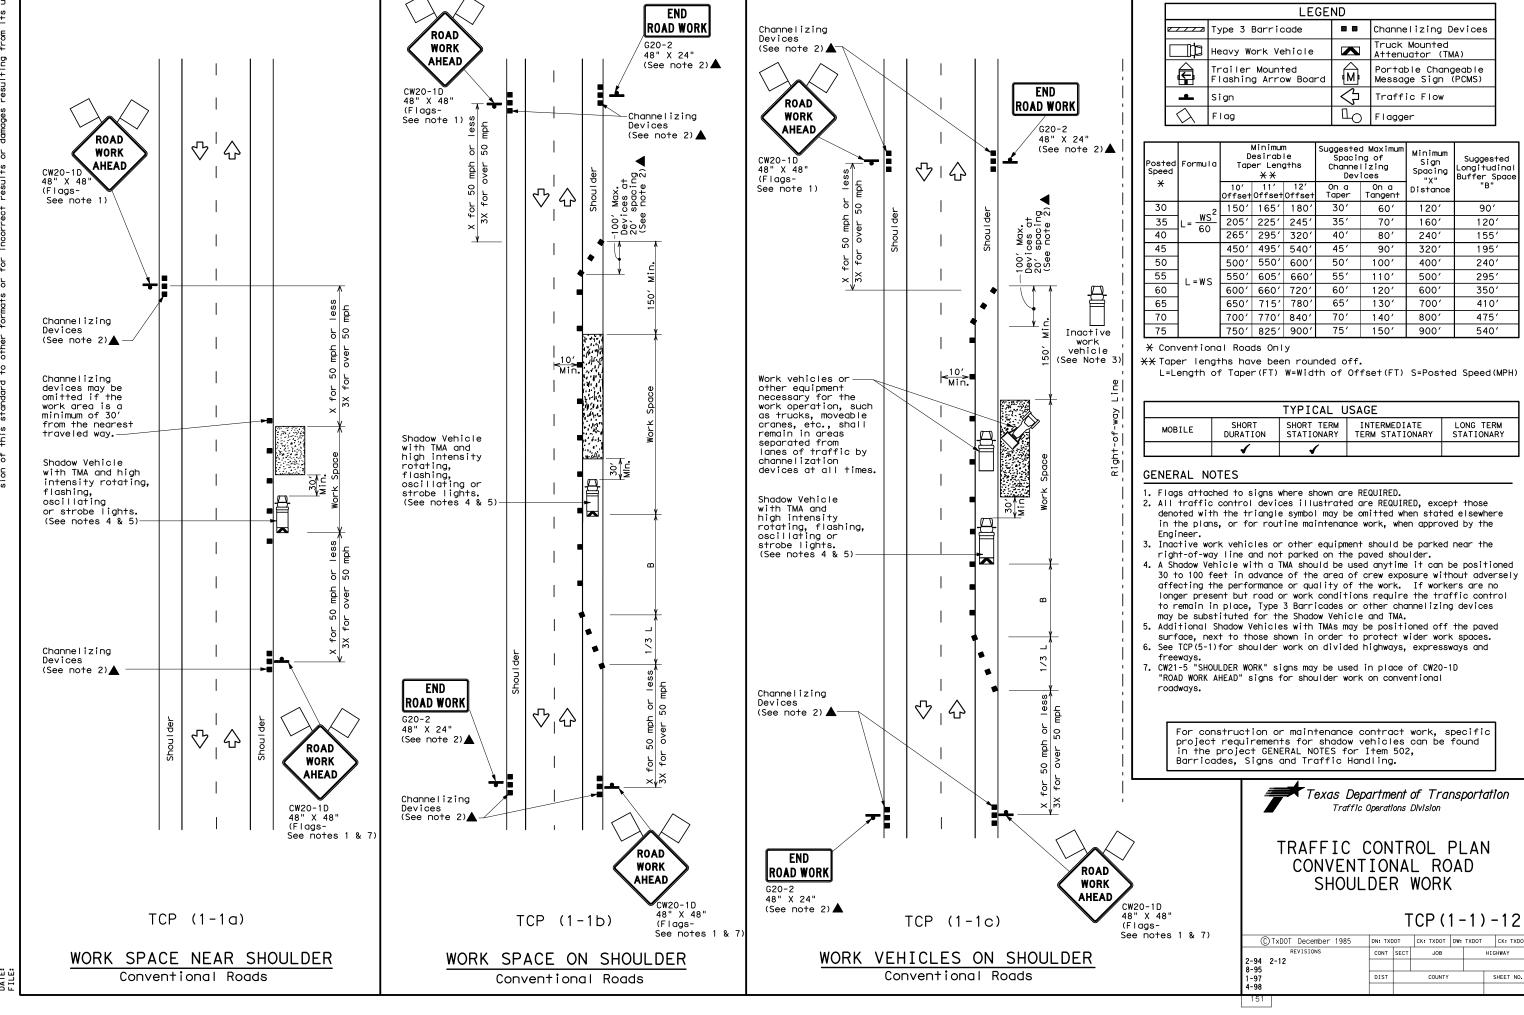



# **Notice of Proposed Installation**Utility Line On TxDOT Highway Right of Way

To the Texas Transportation Commission c/o District Engineer Texas Department of Transportation Houston District, Texas

Date	8/27/2018
Application No.	HOU20180827075039

Texas Department of Transportation Houston District, Texas	
Formal notice is hereby given that	Comcast of Houston, LLC
proposes to install a utility facility within the right-of-way of	FM2234
in Brazoria County, Texas as follows: (details are shown on pa	ge 2)
PROJECT BEGINS WHERE CABLE ENTERS THE ROW. BO PROJECT ENDS AT PROPOSED PED 570' E OF C/L WEST	
The line will be constructed and maintained on the highway rig and in accordance with the rules, regulations and policies of th (TxDOT), and all governing laws, including but not limited to th Endangered Species Act," and the "Federal Historic Preservat compliance with all governing laws, rules and regulations will be of construction.	e Texas Department of Transportation e "Federal Clean Water Act," the "National ion Act." Upon request by TxDOT, proof of
Our firm will use Best Management Practices to minimize eros proposed installation, and we will revegetate the project area a Provisions."	
Our firm will ensure that traffic control measures complying wit Uniform Traffic Control Devices will be installed and maintaine	
The location and description of the proposed installation and a containing drawings and other pertinent information uploaded	
Construction will begin on or after <u>September 3, 2018</u> and	end on or before <u>December 3, 2018</u> .
I certify that I am authorized to represent the Firm listed below conditions/provisions included in this notice.	, and that our Firm agrees to the
Utility Installation Owner	Comcast of Houston, LLC
Ву	Juan Jimenez
Title _	Permit Coordintator
	8590 West Tidwell Road
	Houston, TX 77040

Phone No. 281-624-3015

E-mail address juan\_jimenez@cable.comcast.com

### **Application Details**

Application No.	HOU20180827075035
Date	8/27/2018
Utility Installation Owner	Comcast of Houston, LLC
Ву	Juan Jimenez
TxDOT District	Houston District
County	Brazoria
Route	FM2234
Control Section	210502
Description	PROJECT BEGINS WHERE CABLE ENTERS THE ROW. BORE 176' AND TRENCH 564' AS INDICATED. PROJECT ENDS AT PROPOSED PED 570' E OF C/L WEST DR TOTAL PROJECT IS 740'.
Attachments	77666_8303 MCHARD RD_TXDOT.pdf

# TxDOT - Houston District CHECKLIST FOR REVIEW OF NOTICES OF PROPOSED INSTALLATION Online version 04/2018

Yes	No	N/A	Are the utility plans legible, drawn to scale, and accurately dimensioned?
×			Is the location of the proposed utility facility clearly shown on the plans?
	×		Do the plans show how the proposed installations connect to existing infrastructures on both ends of the proposed utility?  PROJECT STARTS ENTERING ROW
X			Is the right of way line clearly shown and the distance of the utility line from the edge of pavement shown on the plans?
X			Is the profile of the bore shown on drawings?
	×		For aerial installations, do the plans clearly show and differentiate between existing poles and new poles?
	X		For aerial installations, do the plans call out the vertical and/or horizontal clearance?
	X		Are other existing utility lines shown on the plans? Including vertical elevations and horizontal alignments.
	×		Do the plans show the required slack coil to be placed in adjacent vault/handhole/manhole/pullhole/ductbank? Minimum of 50' of slack coil for installations greater than 500' or minimum of 100' of slack coil for installations greater than 1,000'.
		X	For small cell: Will this project meet all applicable City design guidelines? If not, please explain.
		X	For small cell: Will this node or node support pole connect to a new or existing transport facility?
×			It is understood that a copy of the Utility Permit or Individual Site Agreement MUST be on the job site during any construction activities.
×			It is understood that it is the responsibility of the utility owner to contact the nearest TxDOT Maintenance Office 72 hours prior to the start of construction using the UIR System. It is also the owner's responsibility to contact TxDOT once construction is complete.